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- Legend**
- ORIGINAL GROUND ELEVATION
 - PROPOSED ELEVATION
 - PROPOSED LOT CORNER ELEVATION
 - EXISTING LOT CORNER ELEVATION
 - FLOW DIRECTION AND GRADE
 - FINISHED FIRST FLOOR ELEVATION
 - UNDERSIDE OF FOOTING ELEVATION
 - ENGINEERED FILL REQUIRED
 - TERRACING 3:1 SLOPE MAXIMUM (UNLESS OTHERWISE SHOWN)
 - DIRECTION OF EMERGENCY OVERLAND FLOW
 - PROPOSED VALVE BOX
 - PROPOSED VALVE CHAMBER
 - PROPOSED FIRE HYDRANT
 - PROPOSED SANITARY SEWER MANHOLE
 - PROPOSED STORM SEWER MANHOLE
 - PROPOSED CATCHBASIN MANHOLE
 - PROPOSED CATCHBASIN
 - PROPOSED C&T
 - PROPOSED DEPRESSED CURB LOCATION
 - PROPOSED BARRIER CURB
 - PROPOSED HEAVY DUTY ASPHALT
 - OVERLAND SPILL LOCATION
 - TWS LOCATION AS PER CITY STD
 - PROPOSED 2HR RATED FIRE WALL LOCATION

- Notes**
- DRIVEWAYS/CAR ONLY PARKING AREAS
50mm SUPERPAVE T2.5 ASPHALTIC CONCRETE
150 OPS GRANULAR "A" BASE
300 OPS GRANULAR "B" TYPE B
 - LOCAL RESIDENTIAL ROADWAYS
40mm SUPERPAVE T2.5 ASPHALTIC CONCRETE
50mm SUPERPAVE 19.0 ASPHALTIC CONCRETE
150 OPS GRANULAR "A" BASE
400 OPS GRANULAR "B" TYPE B
 - RISER COUNT AND DIMENSION - STACKED TOWNS
SR = 0.53m
4R = 0.72m
6R = 0.91m
8R = 1.10m

Revision	By	Appd.	YY.MM.DD	
2	WATER ENTRY BUILDING C	KV	KS	26.03.19
1	REVISED SITE PLAN	KV	KS	26.03.17
0	ISSUED FOR SPA	MJS	KS	23.11.07

Revision	By	Appd.	YY.MM.DD	
1	MJS	DT	MJS	25.09.30
	Dwn.	Chkd.	Dgn.	YY.MM.DD


Permit-Seal

Client/Project
MATTAMY HOMES LTD.
50 HINES ROAD, SUITE 100
OTTAWA, ON. K2K 2M5

**NORTHWOODS SUBDIVISION
PHASE 6, BLOCK 454
OTTAWA, ON, CANADA**

Title
SITE GRADING PLAN

Project No. 160402120
Drawing No. GP-1
Scale 1:250
Sheet 4 of 7
Revision 2
Date 26.03.19
Title SITE GRADING PLAN
Project # 19393

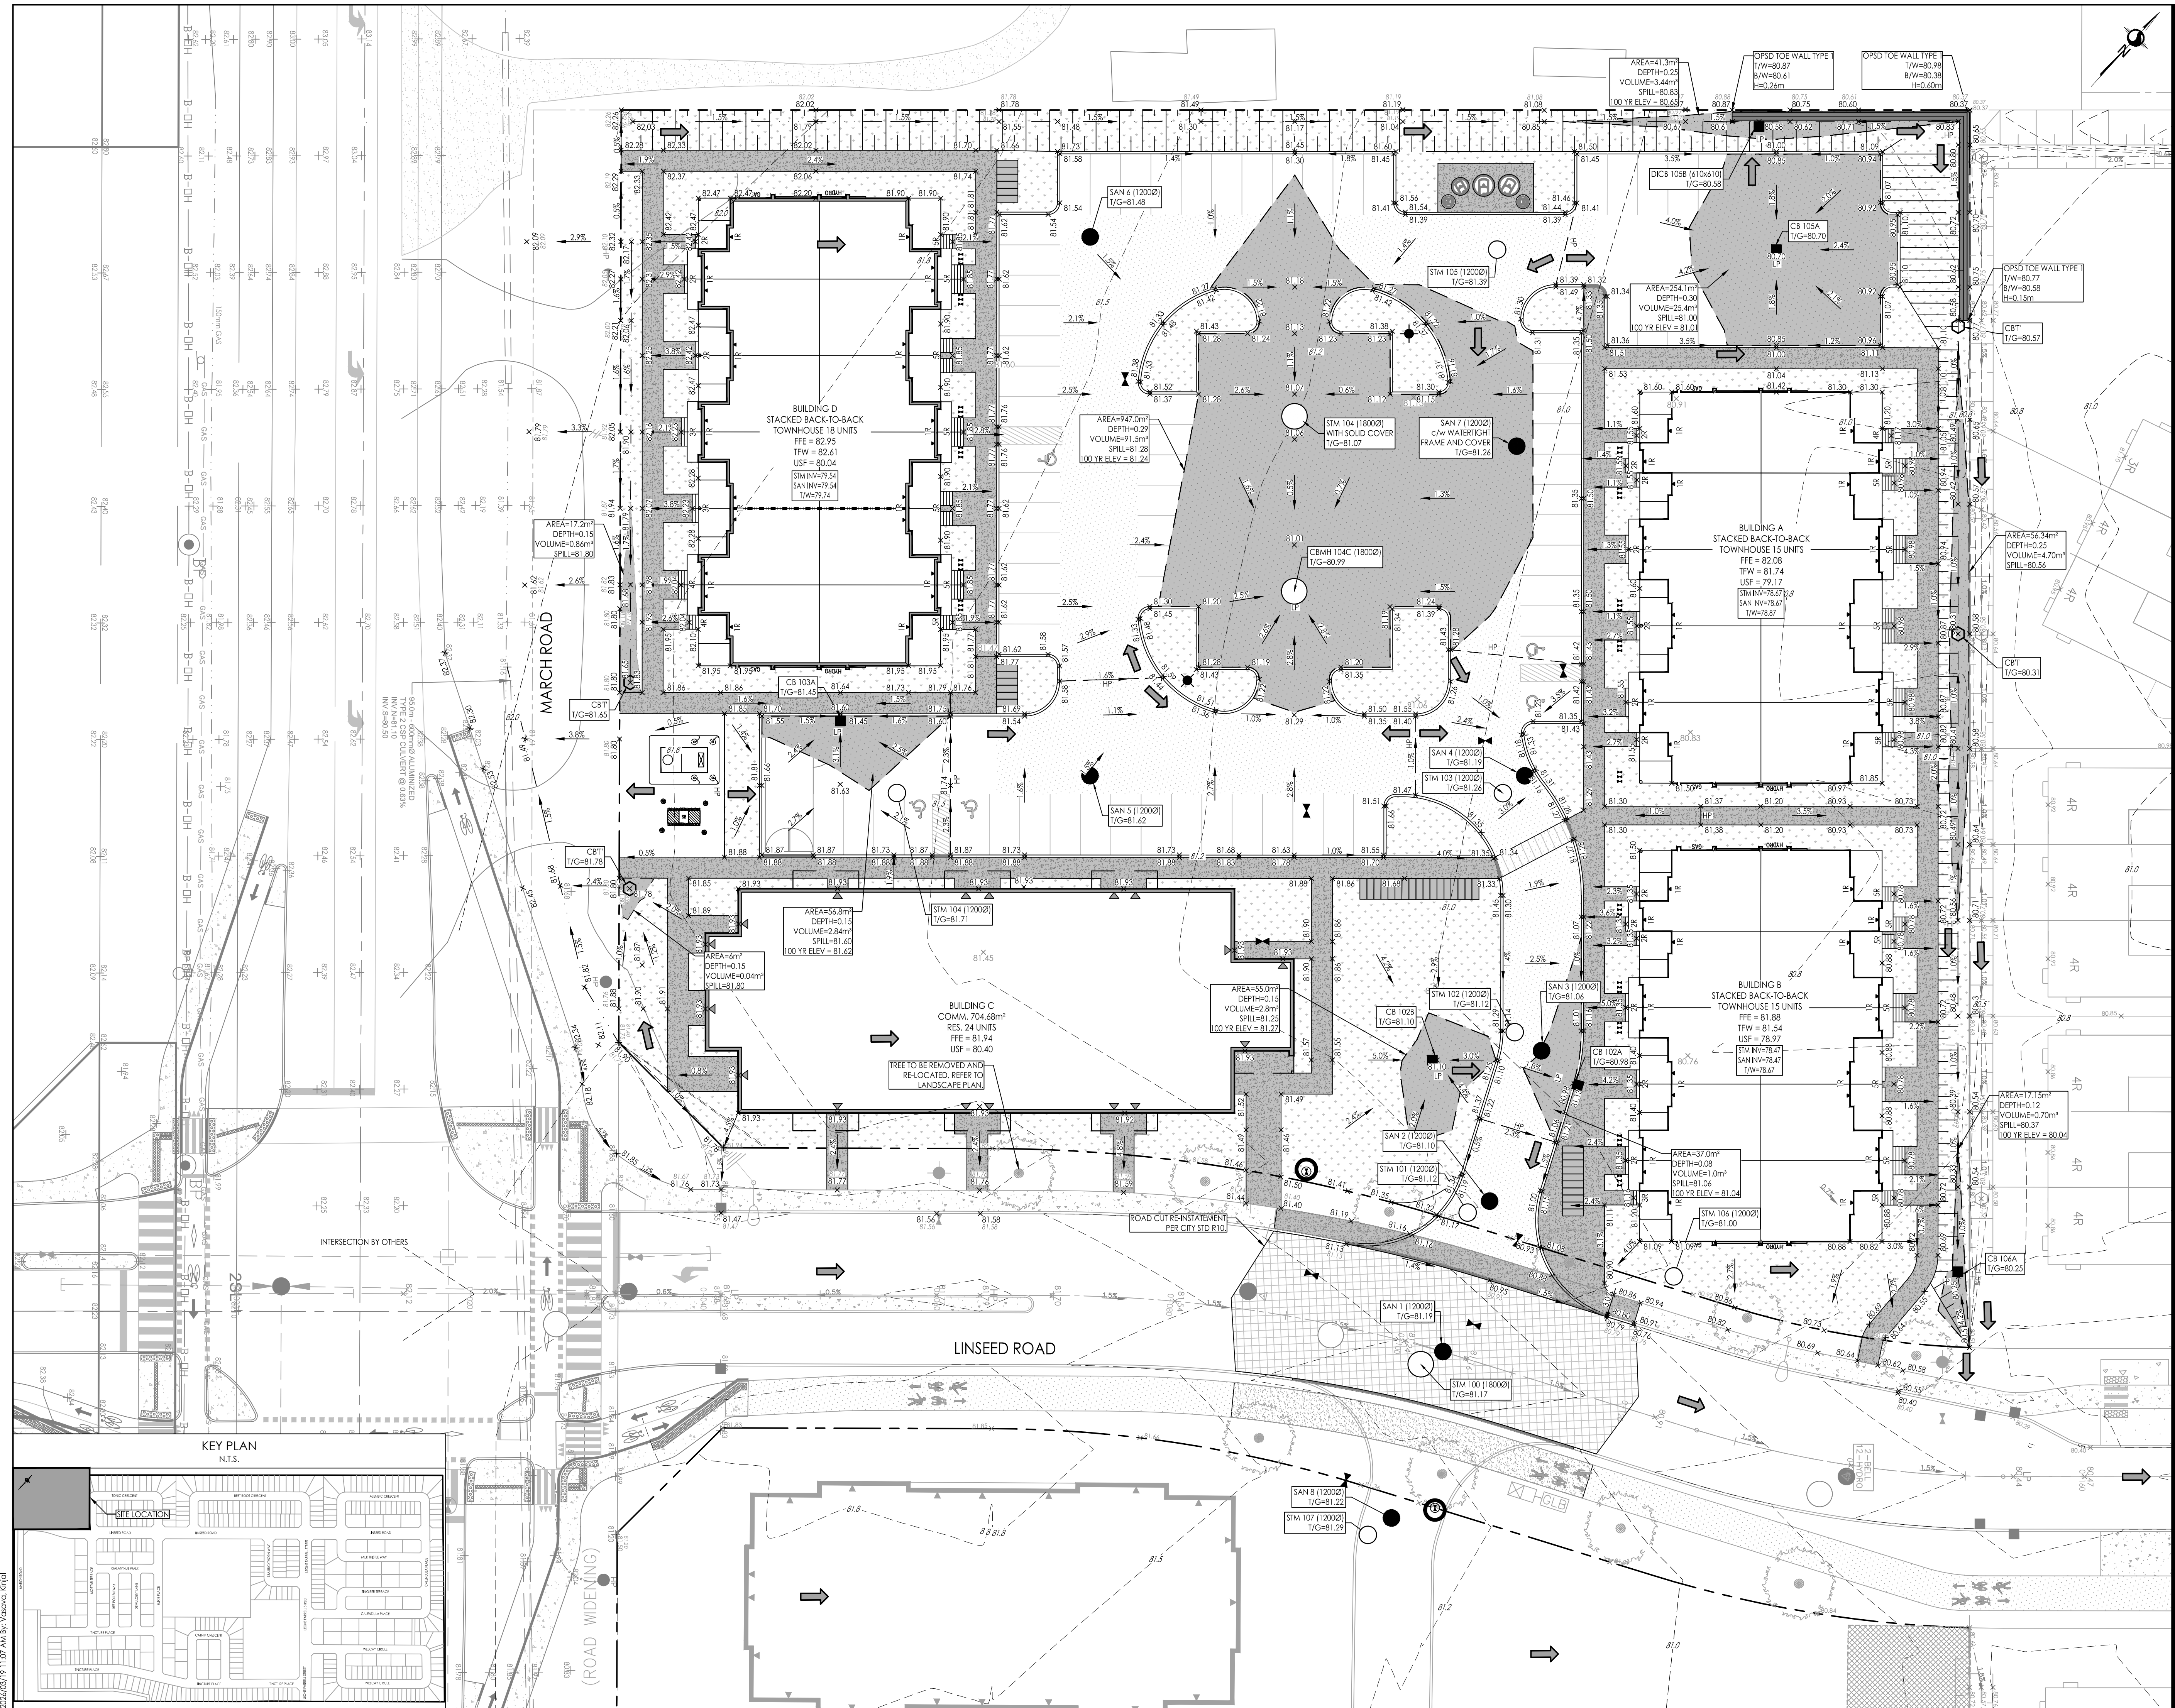

KEY PLAN
N.T.S.

