


TYPICAL PRECAST NOISE WALL ELEVATION
 SCALE NTS

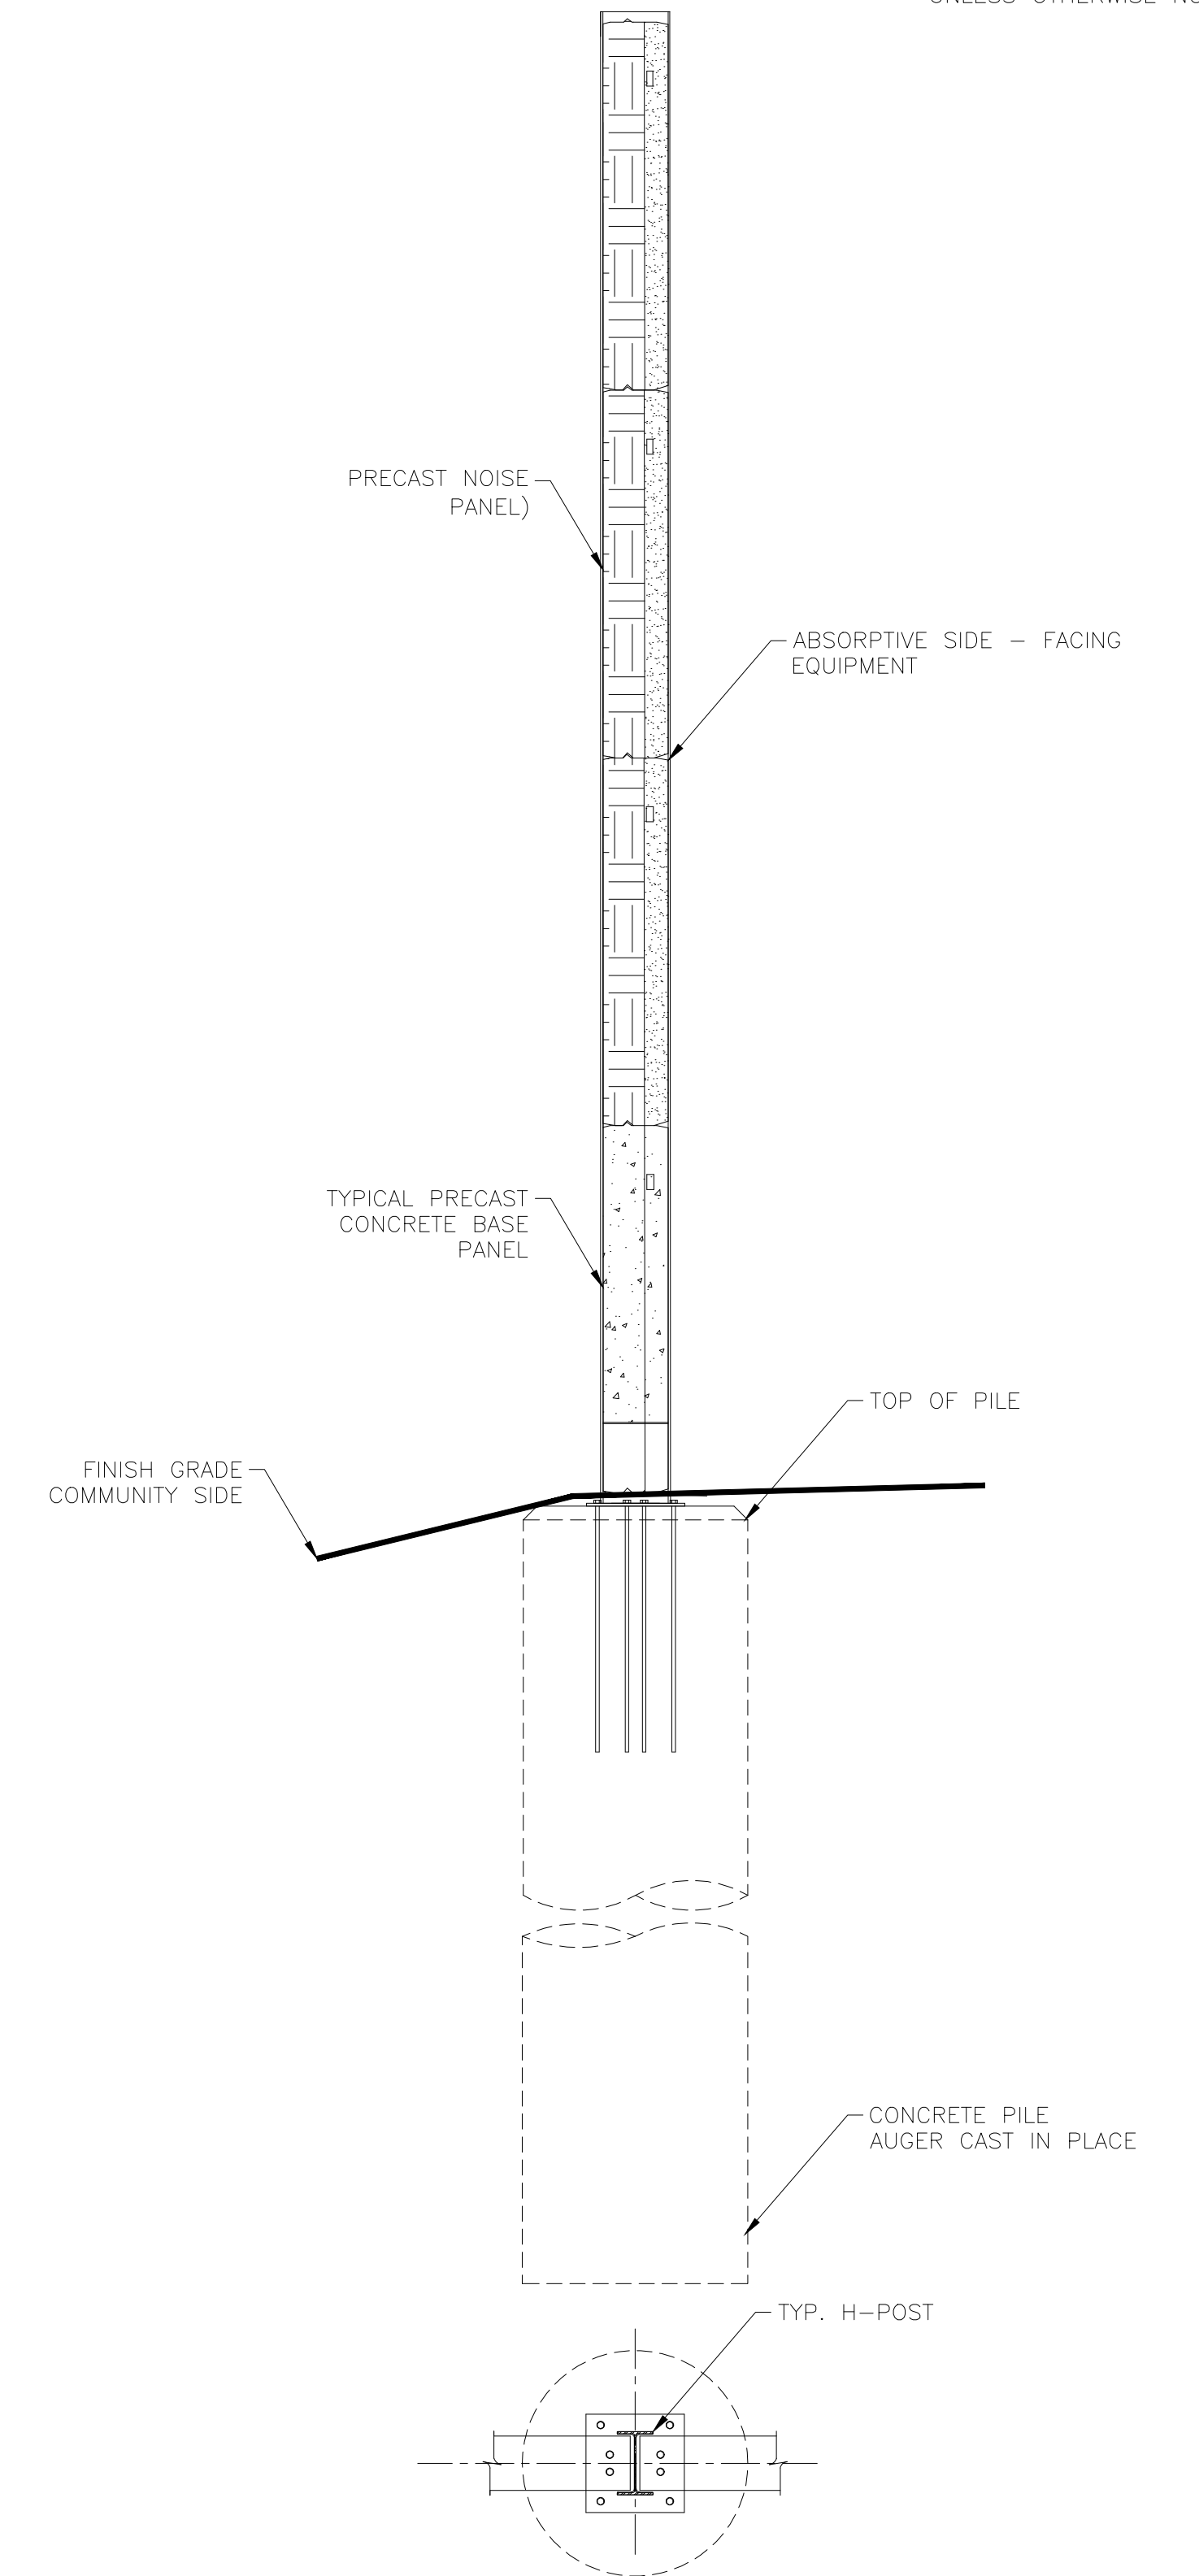

TYPICAL NOISE WALL SECTION
 SCALE NTS

**FOR INFORMATION ONLY
 NOT FOR CONSTRUCTION**

NOTES:

- FOUNDATION DESIGN AS PER LOCAL CONDITIONS IN ACCORDANCE WITH THE ENGINEER OF RECORD
- REFER TO GEOTECH REPORTS FOR LOCAL GROUND CONDITIONS
- REFER TO NOISE ASSESSMENT FOR PROPOSED NOISE BARRIER LAYOUT
- WATER PASSING GRATE OR EQUIVALENT FOR SURFACE RUN-OFF, SHALL BE DESIGNED IN ACCORDANCE WITH DRAINAGE DESIGN CAPACITY AND SURFACE GRADING.
- TYP. MIN. ACOUSTIC PANEL SURFACE DENSITY 20 KG/M2 (REFER TO OPSS 760)
- ALL DIMENSIONS ARE TYPICAL AND SHALL BE REVISED AS PER THE DETAIL DESIGN AND APPROVED BY THE ENGINEER OF RECORD

REFERENCE DRAWINGS	ISSUE	REVISIONS	DRAWN BY:	DESIGNED BY:		
			MC			
			CHECKED BY:	APPROVED BY:		
			MC			
			SCALE: AS SHOWN FULL SIZE ONLY			
DWG NO.	TITLE	NO.	DATE	ISSUED FOR	REV.	DATE
		B	2026.03.03	FOR INFORMATION ONLY - NOT CONSTRUCTION		
		A	2024.07.18	FOR INFORMATION ONLY - NOT CONSTRUCTION		

DRAWN BY:	DESIGNED BY:
MC	
CHECKED BY:	APPROVED BY:
MC	
SCALE: AS SHOWN FULL SIZE ONLY	



TRAIL ROAD BESS
 PRE-CAST NOISE WALL

OTTAWA, ON

CONTRACT NO.	DWG. NO.	REV.	SHEET
	H374571-00000-245-292-0001	B	1