


EXTERIOR MATERIALS:


- (A) ARCHITECTURAL CONCRETE BLOCK, "WHITE"
- (B) ARCHITECTURAL CONCRETE BLOCK, "WHITE"
- (CA) ARCHITECTURAL STONE, "FINE"
- (CB) ARCHITECTURAL STONE, "SPLIT"
- (C) CENTIMETER FACED INSULATION
- (LA) FORMED ALUMINUM PANEL, TYPE A "BRONZE"
- (LB) FORMED ALUMINUM PANEL, TYPE B "CHAMPAGNE"
- (LC) FORMED ALUMINUM PANEL, TYPE C "GREY"
- (LD) FORMED ALUMINUM PANEL, TYPE D "GREEN"
- (LE) FORMED ALUMINUM PANEL, TYPE E "ORANGE"
- (LF) FORMED ALUMINUM PANEL, TYPE F "YELLOW"
- (LG) FORMED ALUMINUM PANEL, TYPE G "SILVER"
- (H) FORMED ALUMINUM PANEL, STANDING BEAM VERTICAL, "CLEAR"
- (I) PREFORMED SCUPPER
- (JA) EXTERIOR LOUVER - PENTHOUSE, TYPE A "GREY"
- (JB) EXTERIOR LOUVER - GENERATOR ROOM, TYPE A "GREY"
- (JC) EXTERIOR LOUVER - SMALL, TYPE A "GREY"
- (JD) EXTERIOR LOUVER - SMALL, TYPE B "BRONZE"
- (JE) EXTERIOR LOUVER - SMALL, TYPE C "MATCH EXISTING (CHEO)"
- (JA) EXTERIOR LOUVER - ACOUSTIC, TYPE A "GREY"
- (JL) GLAZED TYP TERRACE GUARD - TYPE 1A (2400 mm HIGH)
- (JM) GLAZED TYP TERRACE GUARD - TYPE 1B (1800 mm HIGH)
- (JN) GLAZED MENTAL HEALTH TERRACE GUARD - TYPE 1 (2020 mm HIGH)
- (K) LINEAR METAL BOFFETS, WOOD-LOOK
- (L) METAL COMPOSITE PANELS, "GREY"
- (M) METAL SIDING
- LL LOOSE LINTEL (LLI) SHELF ANGLE (SFA) CONTROL JOINT (CJ)

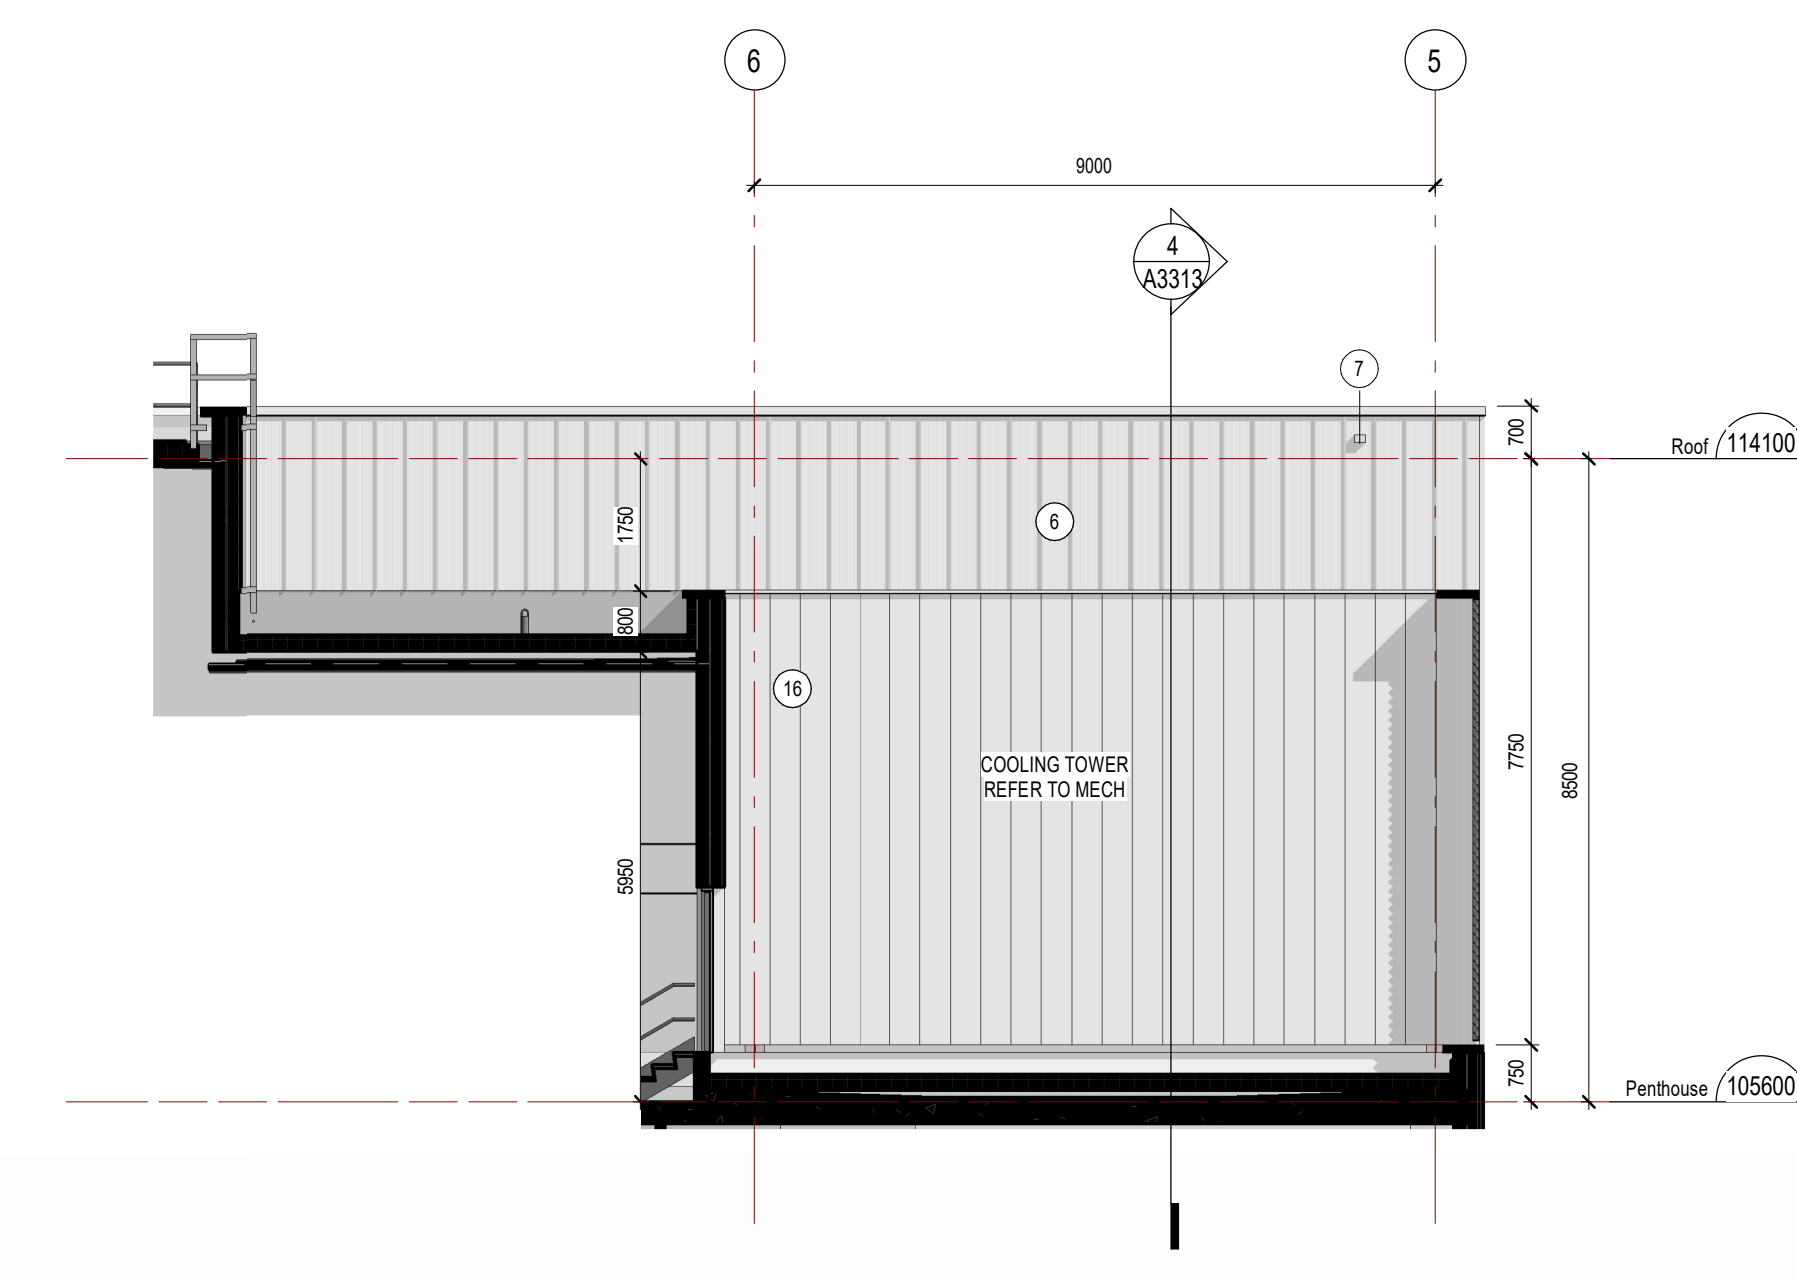


4 LEVEL 7 COOLING TOWER - SOUTH FACING
AZ22 1:100

Lily Xu
APPROVED
By Lily Xu at 1:02 pm, Apr 22, 2025


LILY XU, MCIP, RPP
MANAGER, DEVELOPMENT REVIEW SOUTH
PLANNING, DEVELOPMENT, AND BUILDING SERVICES
DEPARTMENT, CITY OF OTTAWA

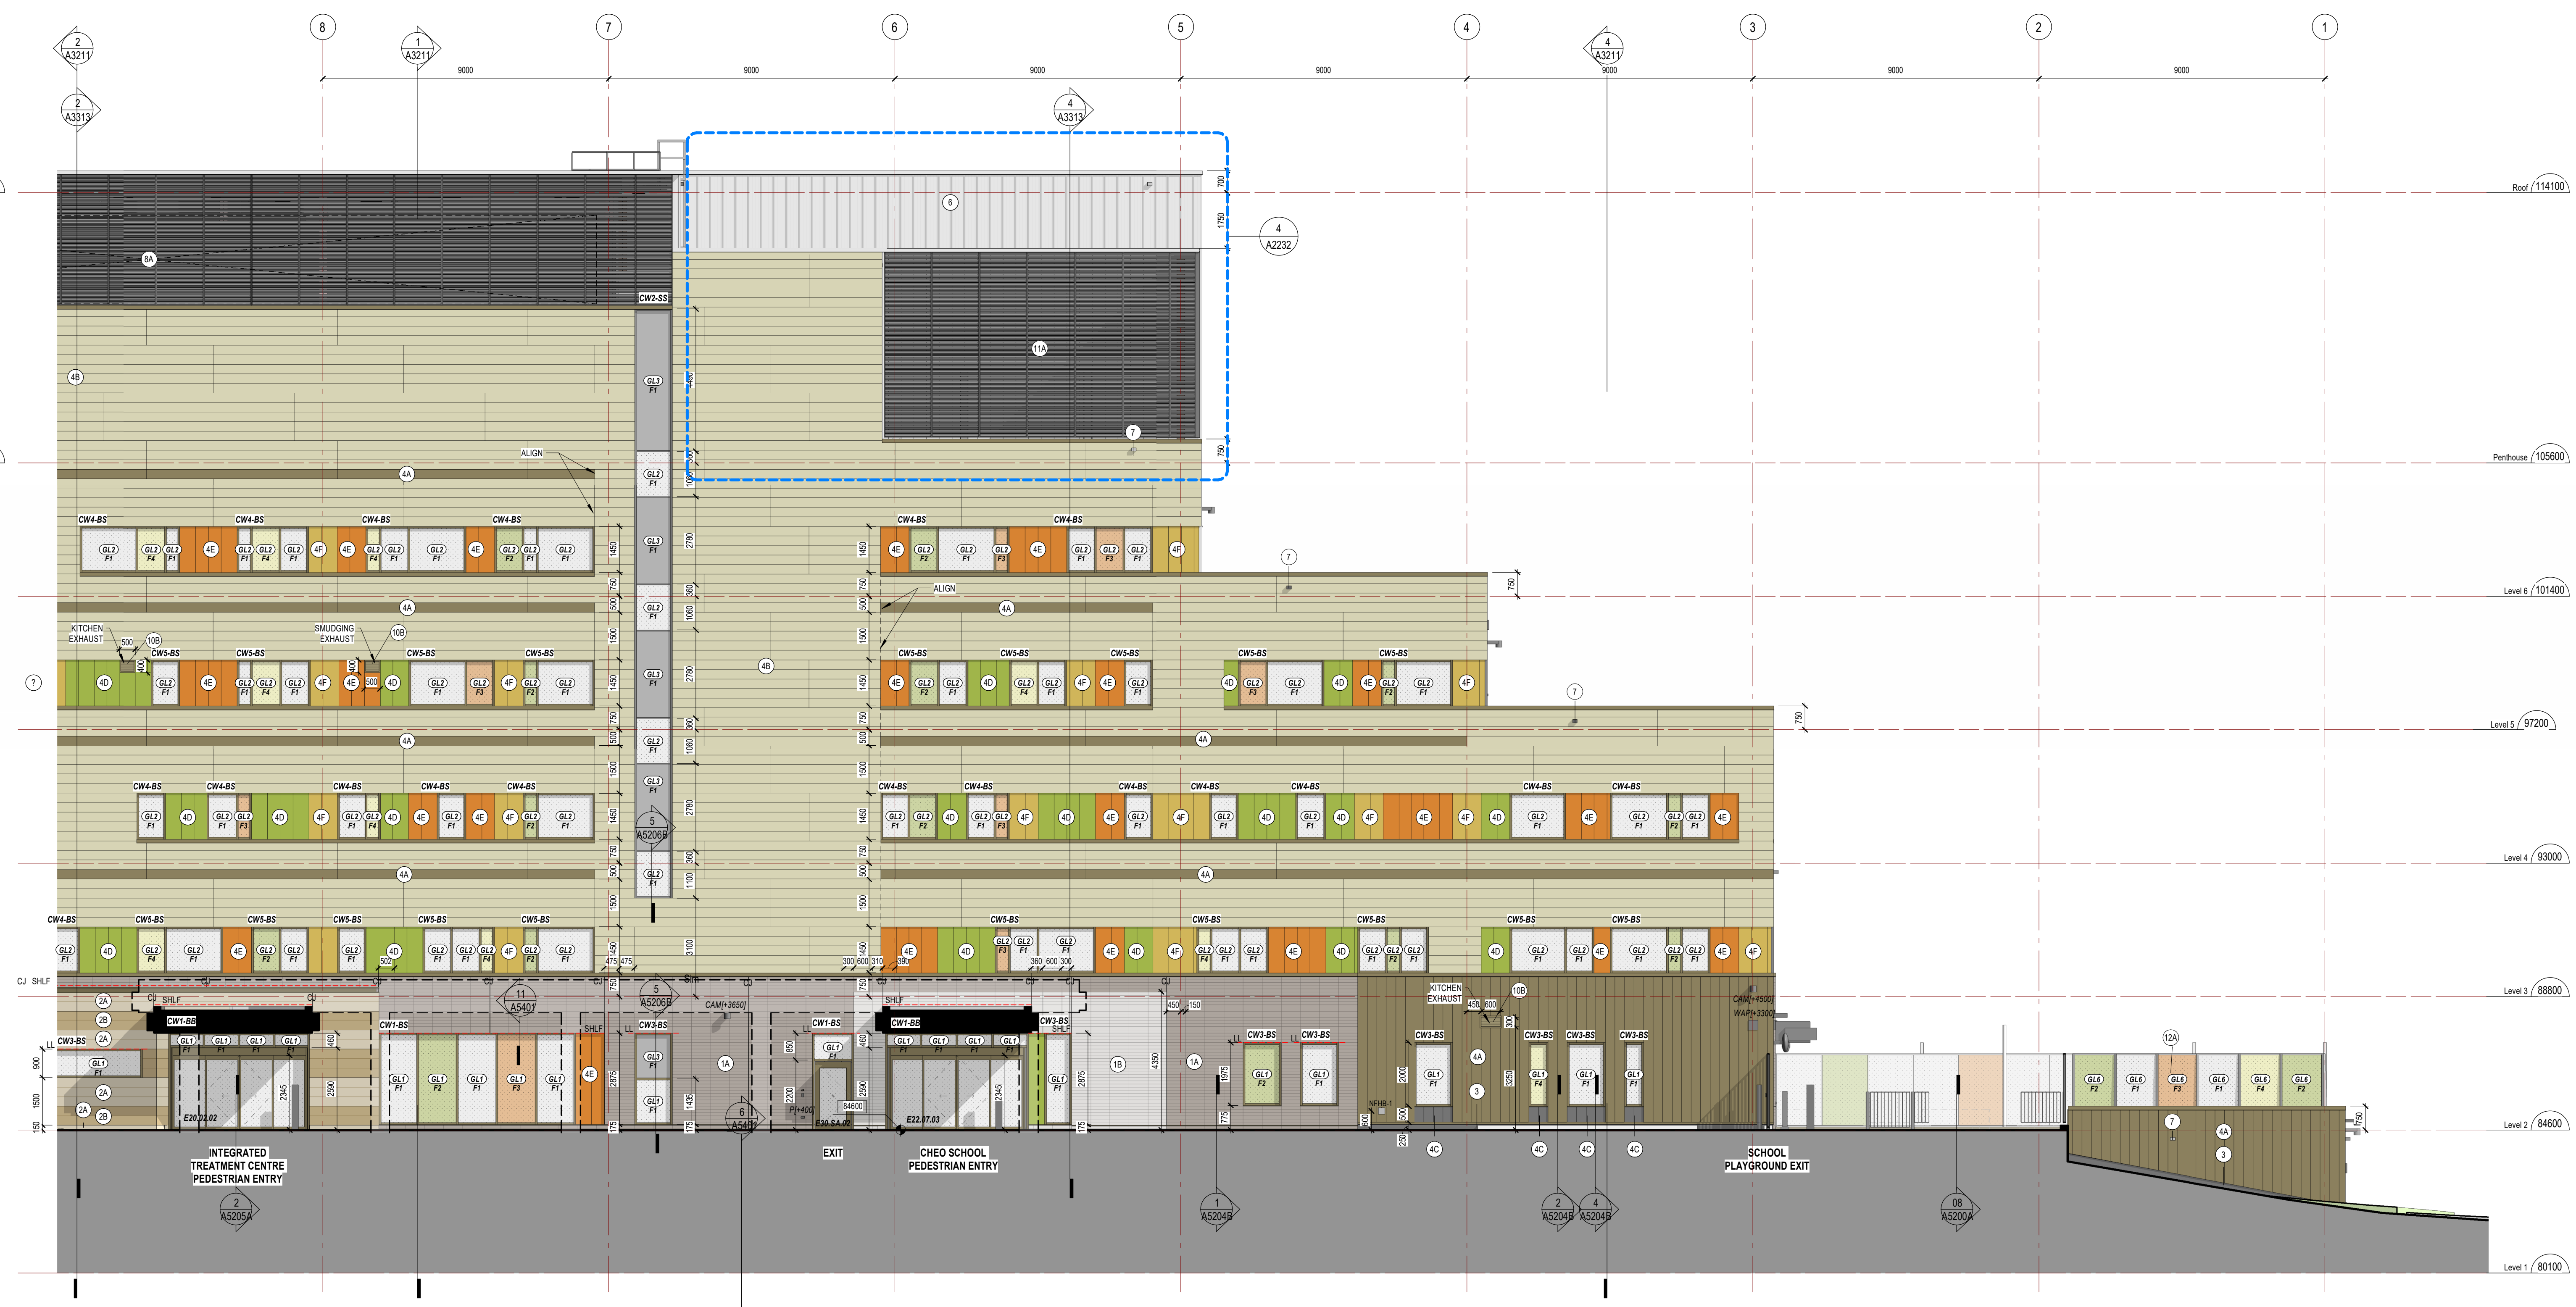

2 NORTH ELEVATION - ZONE B
AZ22 1:100

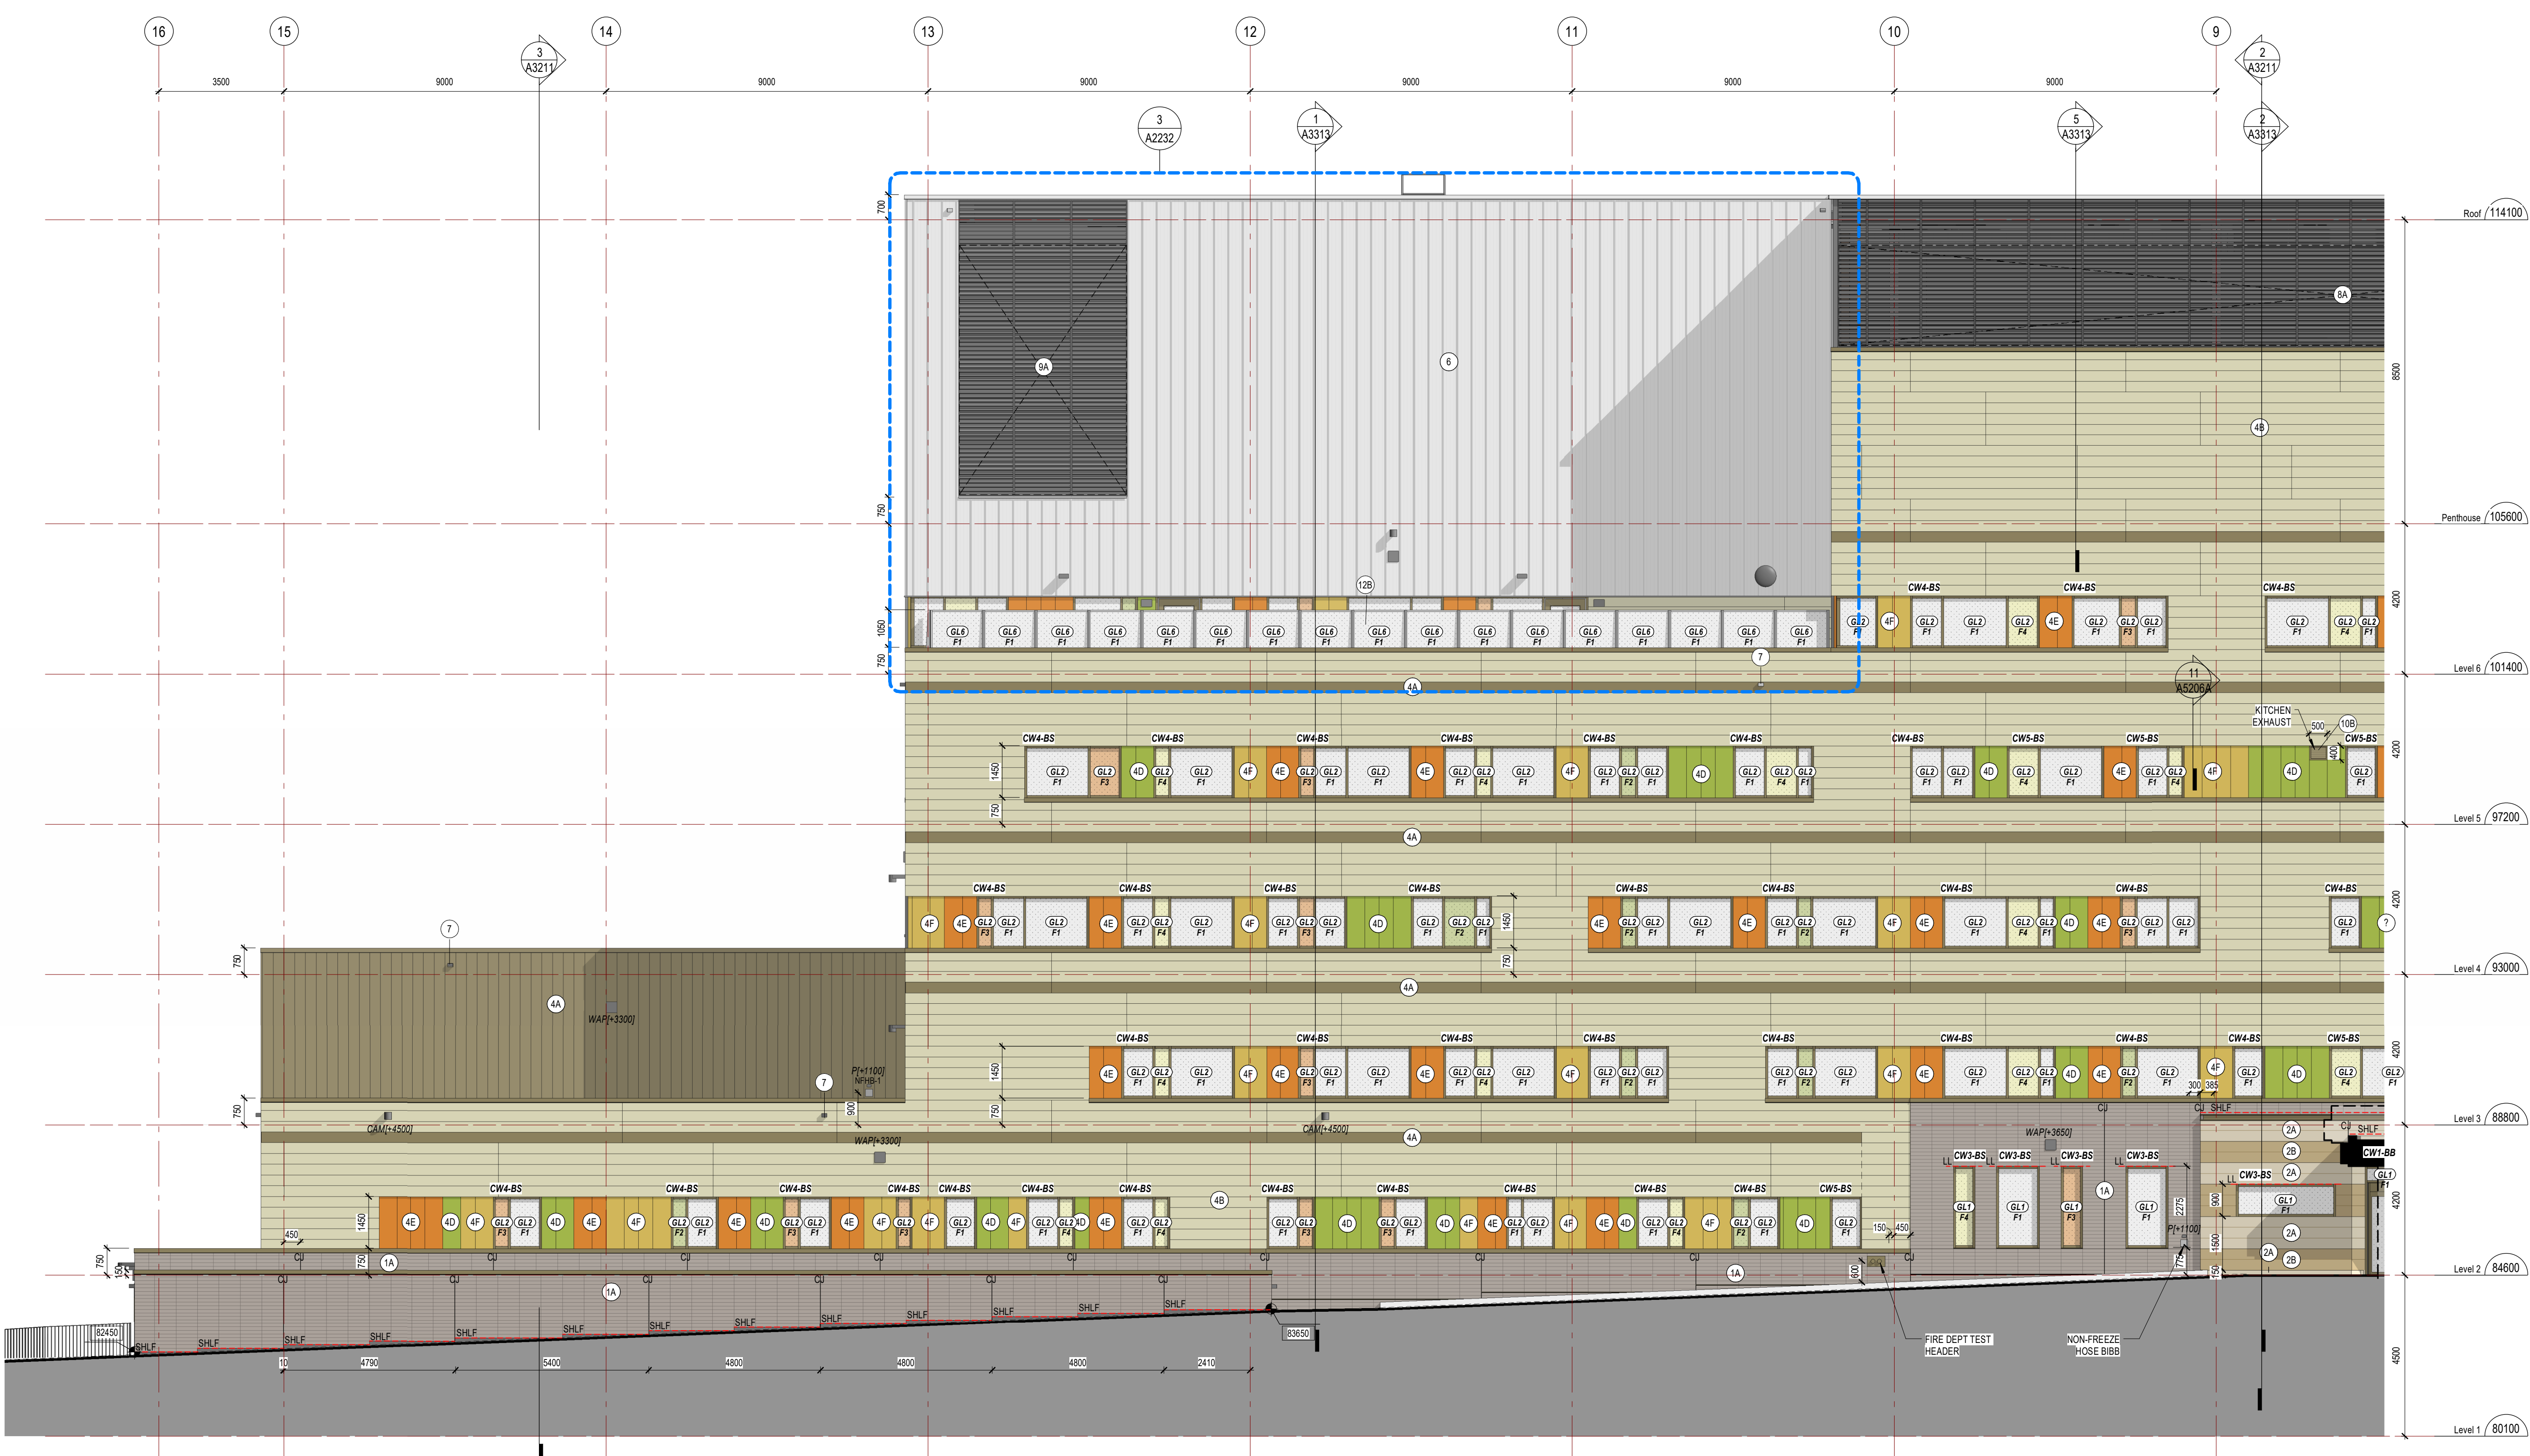


1 NORTH ELEVATION - ZONE B
AZ22 1:100

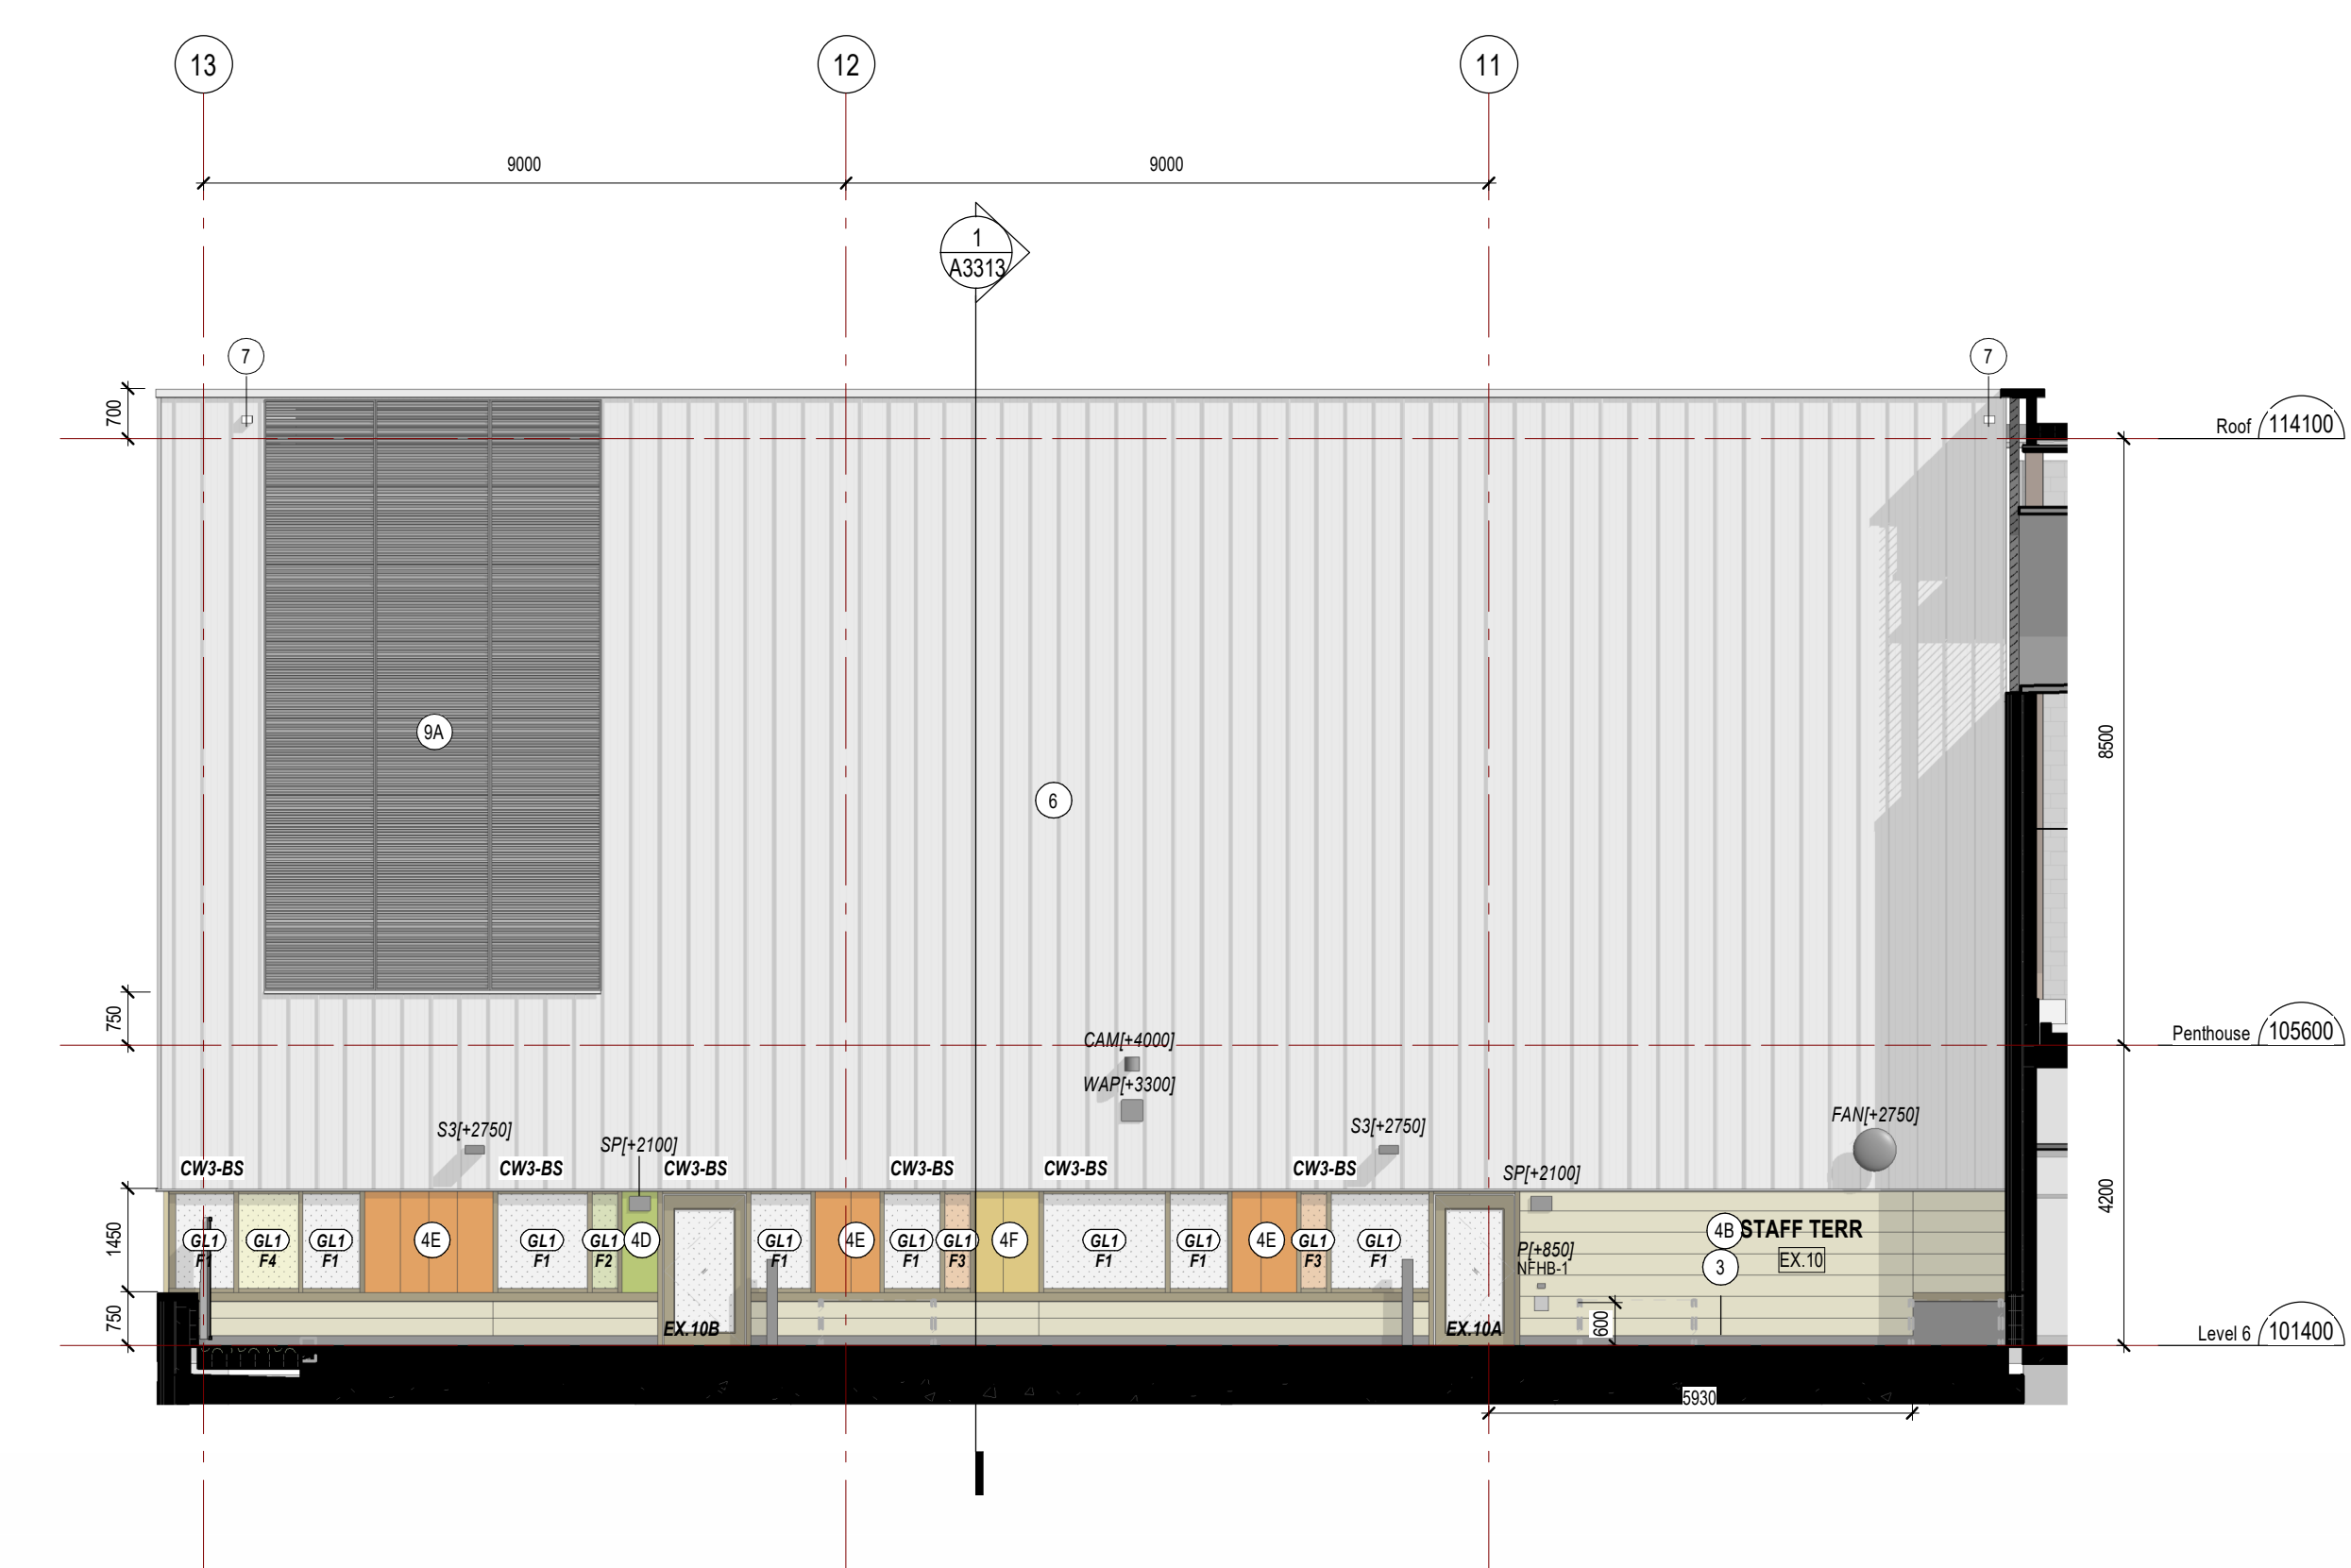

3 LEVEL 6 STAFF TERRACE - SOUTH FACING
AZ22 1:100

- 204041 ISSUED FOR SITE PLAN CONTROL, RESUBMISSION
- 204042 ISSUED FOR 100% CONSTRUCTION DOCUMENTS
- 204107 ISSUED FOR 100% CONSTRUCTION DOCUMENTS
- 204050 ISSUED FOR BUILDING PERMIT
- 204053 ISSUED FOR SITE PLAN CONTROL
- 204058 ISSUED FOR 90% CONSTRUCTION DOCUMENTS
- 204504 ISSUED FOR STEEL TENDER
- 204019 ISSUED FOR 100% DESIGN DEVELOPMENT
- 201215 ISSUED FOR SPEC DRAFT
- 201215 ISSUED FOR 90% DESIGN DEVELOPMENT
- # Date Revision

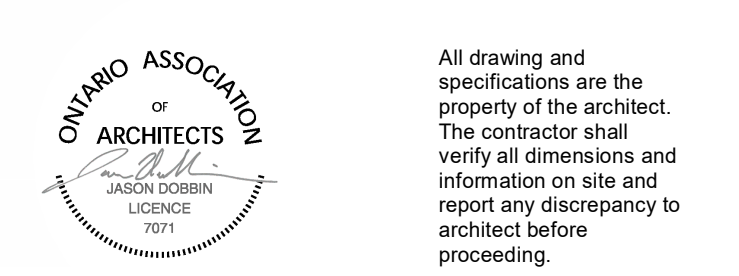

CHEO Integrated Treatment Centre

401 Smyth Rd
Ottawa, ON K1H 8L1

BUILDING ELEVATIONS - NORTH

scale: As indicated
drawn by: Author
reviewed by: Checker
job number: 22004
plot date: 250207
drawing number:

A2232

File Number: D07-12-24-0121
Plan Number: 19223