

1 TREE CONSERVATION REPORT & LANDSCAPE PLAN  
L.1 SCALE: 1:200

### PROPOSED PLANT LIST

KEY	QTY	BOTANICAL NAME	COMMON NAME	SIZE	CONDITION	REMARKS	NATIVE SPECIES
<b>TREES</b>							
*FM	1	Acer x freemanii	Freemans Maple	50mm cal.	B&B		YES
*HB	1	Celtis occidentalis	Hackberry	50mm cal.	B&B		YES
*SB	2	Amelanchier canadensis	Serviceberry	50mm cal.	B&B		YES
*SF	1	Amelanchier laevis 'JFS-ARB'	Spring Flurry Serviceberry	50mm cal.	B&B		YES
<b>SHRUBS</b>							
DW	8	Cornus sericea	Red Osier Dogwood	800 mm ht.	Potted	1200 mm o.c.	YES
RR	21	Rosa rugosa	Rugosa Rose	800 mm ht.	Potted	1200 mm o.c.	NO
SS	15	Sorbaria sorbifolia 'Sem'	Sem False Spirea	600mm ht.	Potted	1000 mm o.c.	NO
<b>PERENNIALS AND ORNAMENTAL GRASSES</b>							
BL	60	Leymus arenarius 'Blue Dune'	Blue Dune Grass	250mm pot	Potted	800 mm o.c.	NO
DL	70	Hemerocallis 'Stella D'Oro'	Stella D'Oro Daylily	100mm pot	Potted	400 mm o.c.	NO
KF	28	Calamagrostis 'Karl Foerster'	Karl Foerster Grass	250mm pot	Potted	800 mm o.c.	NO
MS	56	Miscanthus sinensis 'Strictus'	Poncypine Grass	250mm pot	Potted	800 mm o.c.	NO
RG	98	Pharisis 'Strawberries n' Cream'	Ribbon Grass	250mm pot	Potted	600 mm o.c.	NO

\* TREE IS PROPOSED ON PRIVATE PROPERTY

### 40 YEAR CANOPY CALCULATION:

**-3407m2 area of work**

**-2 Large deciduous trees proposed (154m2 ea.), and 3 small deciduous trees proposed (7m2 ea)**

**=329m2 canopy cover =9.7% canopy cover**


**\*Large deciduous tree calculated at 14m spread, small deciduous trees at 3m spread**

- ### GENERAL NOTES:
- IT IS THE RESPONSIBILITY OF THE APPROPRIATE CONTRACTOR OR OFFICIAL TO REPORT ANY ERRORS, OMISSIONS OR DISCREPANCIES ON THIS PLAN WITH ACTUAL SITE CONDITIONS TO THE LANDSCAPE ARCHITECT BEFORE PROCEEDING WITH CONSTRUCTION.
  - THE CONTRACTOR IS TO NOTIFY ALL UTILITY COMPANIES AND AUTHORITIES PRIOR TO ANY EXCAVATION AND ASCERTAIN LOCATIONS OF UNDERGROUND SERVICES.
  - THE CONTRACTOR IS TO REINSTATE ALL AREAS AND ITEMS DAMAGED AS A RESULT OF CONSTRUCTION ACTIVITY.
  - THE CONTRACTOR IS TO COMPLY WITH ALL PERTINENT CODES AND BY-LAWS.
  - THE CONTRACTOR IS TO MAINTAIN A POSITIVE SURFACE RUN-OFF THROUGHOUT THE ENTIRE CONSTRUCTION PERIOD.
  - THE LANDSCAPE ARCHITECT IS NOT RESPONSIBLE FOR SUBSURFACE CONDITIONS.
  - THE CONTRACTOR IS TO IDENTIFY ALL EXISTING TREES TO REMAIN ON SITE WITH THE LANDSCAPE ARCHITECT PRIOR TO CONSTRUCTION.
  - THE CONTRACTOR IS TO STAKE THE PROPOSED LOCATION OF ALL PLANT MATERIAL IN CONJUNCTION WITH THE LANDSCAPE ARCHITECT PRIOR TO EXCAVATION.
  - MINIMUM DISTANCES FOR SELECTED DECIDUOUS TREES ARE AS FOLLOWS:
    - BUILDING FOUNDATIONS - 7.5M
    - SIDEWALKS - 1.5M
    - PUBLIC STREETS - 2.5M
    - UNDERGROUND INFRASTRUCTURE - 2.0M
  - ALL TREES WITHIN 1M OF UNDERGROUND UTILITY TRENCHES ARE TO BE EXCAVATED BY HAND.
  - REMOVE ALL PROTECTIVE WRAPPING FROM TREE TRUNKS AFTER INSTALLATION.
  - STAKING OF TREES SHALL ONLY BE PERFORMED IF NECESSARY.
  - ENSURE THAT MULCH IS PULLED BACK A MINIMUM DISTANCE OF 75MM FROM BASE OF TREE TRUNK.


### EXISTING TREE LIST

KEY	QTY	BOTANICAL NAME	COMMON NAME	SIZE	CONDITION	REMARKS	OWNERSHIP	COMMENTS
1	1	Acer saccharum	Sugar Maple	300mm DBH	GOOD	To remain	City of Ottawa	100% canopy
2	1	Acer saccharum	Sugar Maple	330mm DBH	GOOD	To remain	City of Ottawa	100% canopy
3	1	Acer saccharum	Eastern White Cedar	150-200mm DBH	GOOD	To remain	City of Ottawa	100% canopy
4	1	Quercus rubra	Red Oak	140mm DBH	GOOD	To remain	City of Ottawa	100% canopy
5	1	Quercus rubra	Red Oak	360mm DBH	GOOD	To remain	1360 Ogilvie	100% canopy
6	1	Quercus rubra	Red Oak	400mm DBH	GOOD	To remain	1360 Ogilvie	100% canopy
7	1	Gleditsia triacanthos	Honey Locust	190mm DBH	GOOD	To be removed	1360 Ogilvie	100% canopy
8	1	Acer negundo	Manitoba Maple	140-170mm DBH	GOOD	To remain	1360 Ogilvie	100% canopy
9	1	Acer ginnala	Amur Maple	6x150mm DBH	GOOD	To remain	1360 Ogilvie	100% canopy
10	1	Malus spp.	Crabapple	300mm DBH	GOOD	To remain	1360 Ogilvie	100% canopy
11	1	Gleditsia triacanthos	Honey Locust	500mm DBH	GOOD	To be removed	1360 Ogilvie	100% canopy
12	1	Malus spp.	Crabapple	300mm DBH	GOOD	To remain	1360 Ogilvie	100% canopy
13	1	Malus spp.	Crabapple	310mm DBH	GOOD	To remain	1360 Ogilvie	100% canopy
14	1	Malus spp.	Crabapple	320mm DBH	GOOD	To remain	1360 Ogilvie	100% canopy
15	1	Gleditsia triacanthos	Honey Locust	220mm DBH	GOOD	To be removed	1360 Ogilvie	100% canopy
16	1	Acer negundo	Manitoba Maple	100-200mm DBH	GOOD	To be removed	1360 Ogilvie	100% canopy
16	1	Ulmus americana	American Elm	110-150mm DBH	GOOD	To be removed	1360 Ogilvie	100% canopy
17	1	Acer platanoides	Norway Maple	400mm DBH	GOOD	To be removed	1360 Ogilvie	100% canopy
18	1	Acer platanoides	Norway Maple	300mm DBH	POOR	To be removed	1360 Ogilvie	40% canopy
19	1	Quercus rubra	Red Oak	260mm DBH	FAIR	To be removed	1360 Ogilvie / City	80% canopy
20	1	Pinus nigra	Austrian Pine	320mm DBH	GOOD	To remain	1360 Ogilvie / City	100% canopy
21	1	Acer platanoides	Norway Maple	100mm DBH	GOOD	To remain	1360 Ogilvie / City	100% canopy
22	1	Acer platanoides	Norway Maple	100mm DBH	GOOD	To remain	City of Ottawa	100% canopy
23	1	Acer platanoides	Norway Maple	100mm DBH	GOOD	To remain	City of Ottawa	100% canopy
24	1	Gleditsia triacanthos	Honey Locust	250mm DBH	GOOD	To be removed	1360 Ogilvie	100% canopy


\*Denotes non-urban

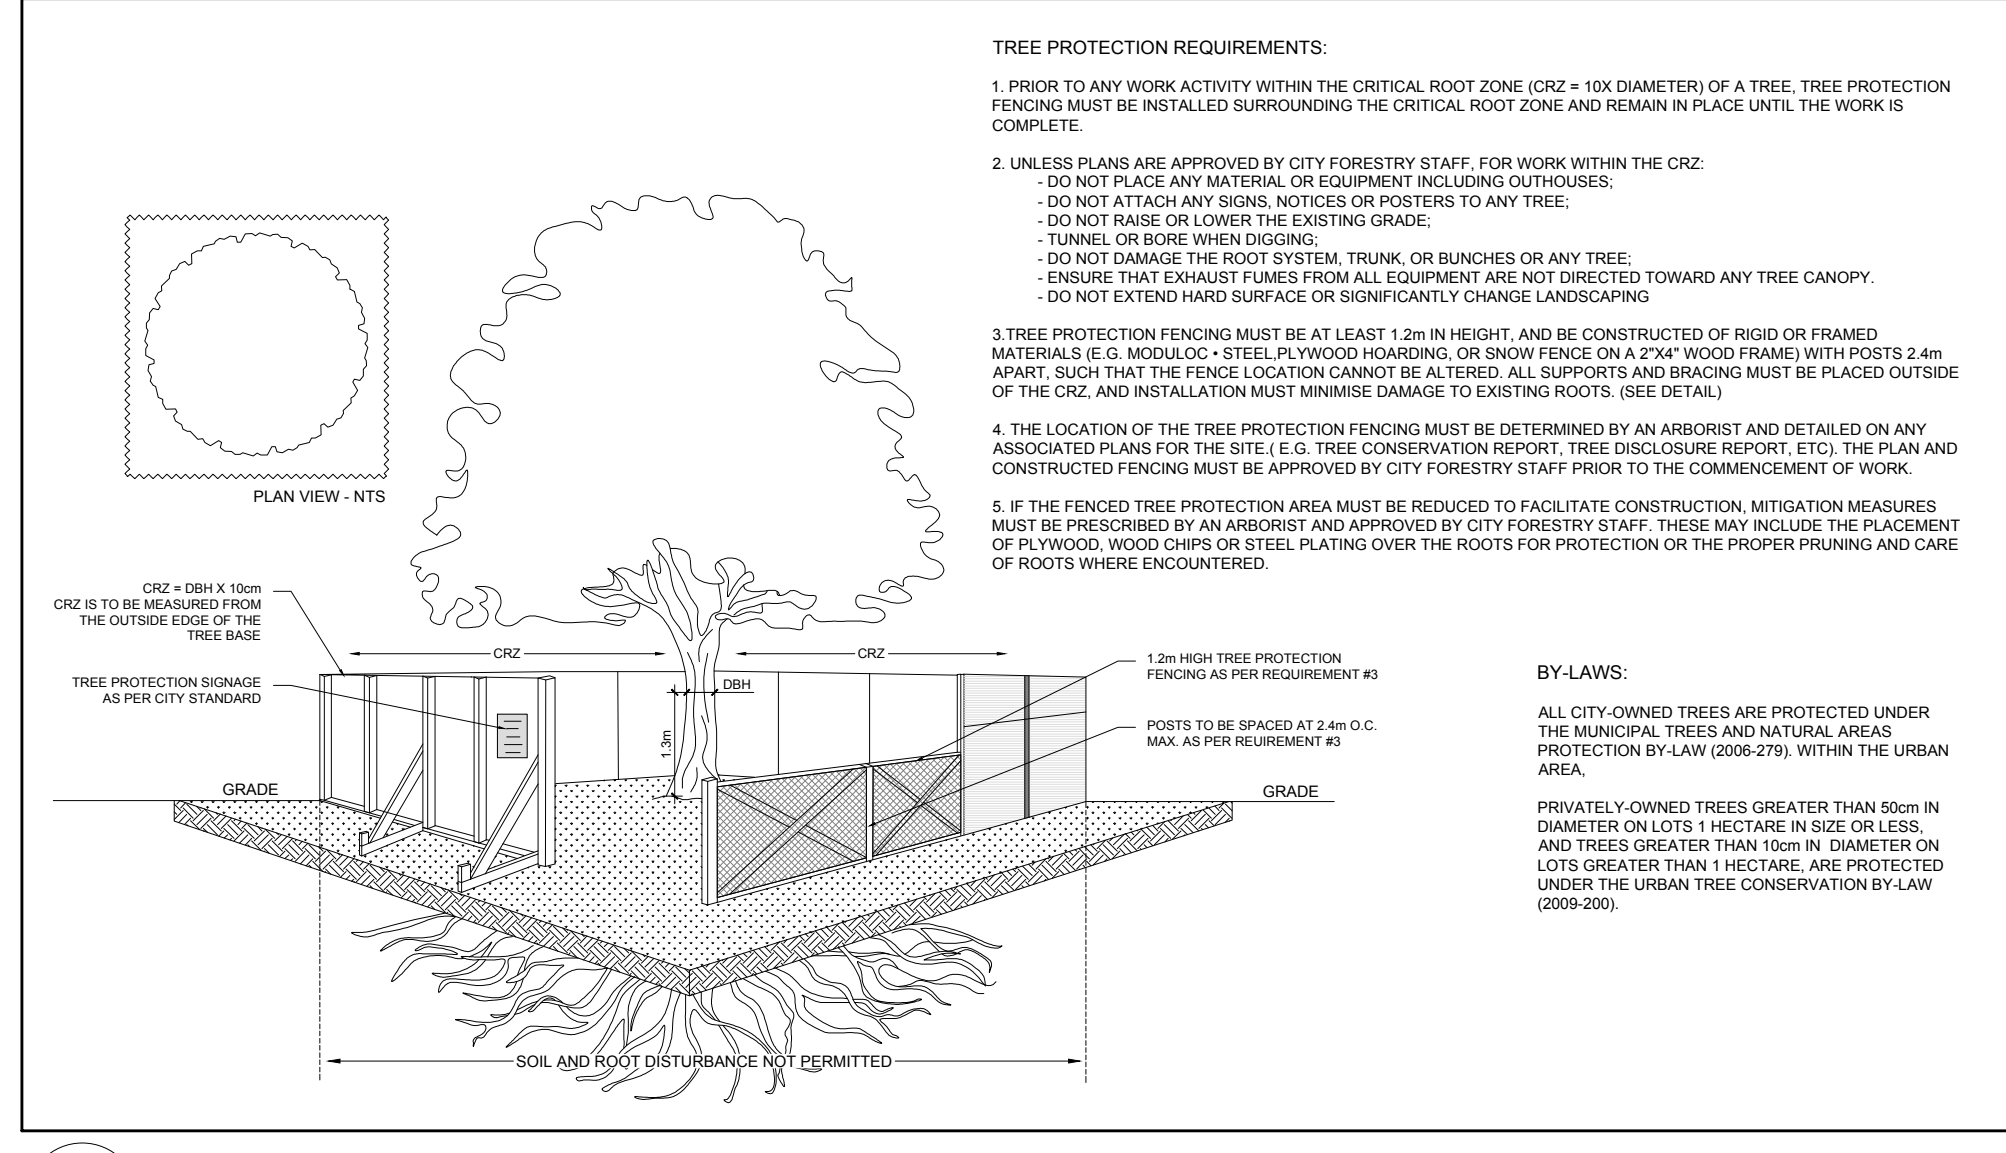

2 TREE PROTECTION FENCE  
L.1 SCALE: NTS

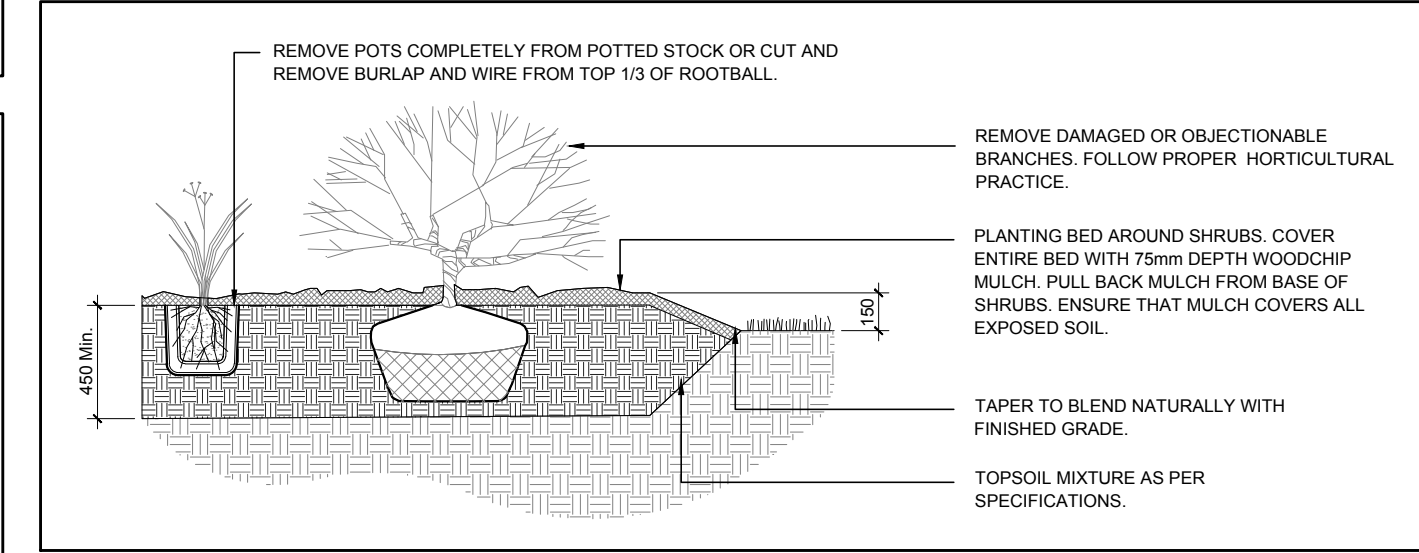

3 SHRUB & PERENNIAL PLANTING  
L.1 SCALE: NTS

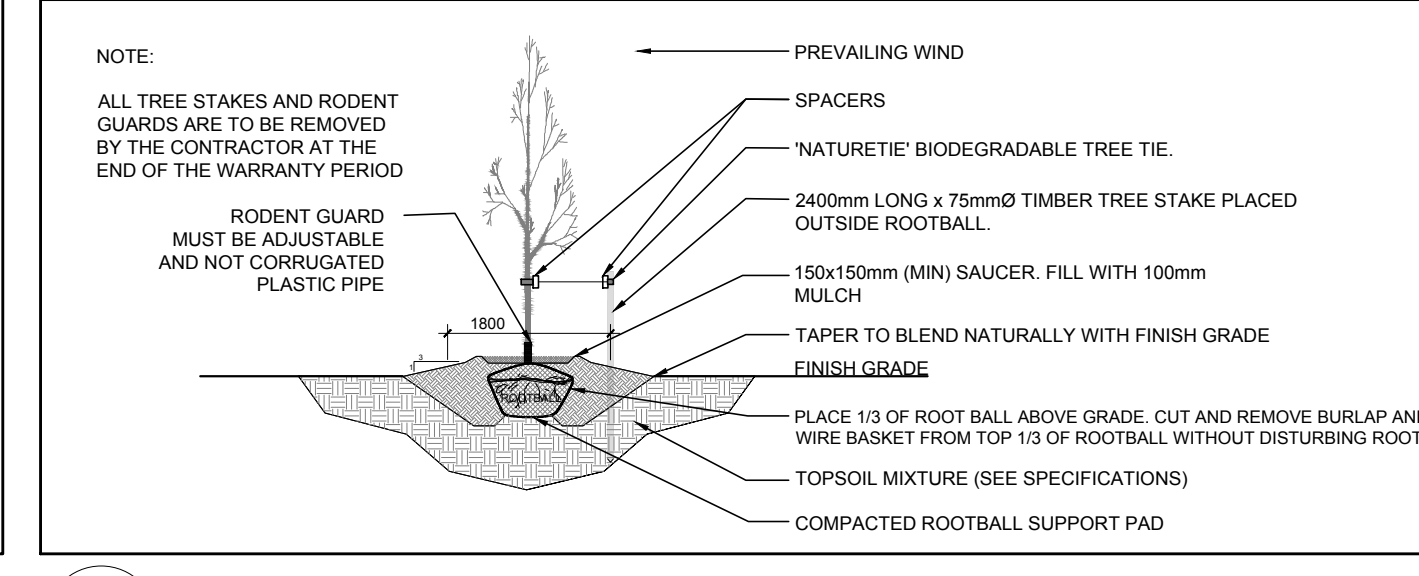

4 DECIDUOUS TREE PLANTING  
L.1 SCALE: NTS

CLIENT  
**BETTER LIVING CO-OPERATIVE**  
OTTAWA, ONTARIO, CANADA

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SURVEYORS: **ANNIS, O'SULLIVAN, VOLLEBECK LTD.**  
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Email: info@anniso.com

### LEGEND

- EXISTING TREE TO REMAIN
- GROUP OF EXISTING TREES TO BE REMOVED
- EXISTING TREE TO BE REMOVED
- PROPOSED DECIDUOUS TREE
- REQUIRED SOIL VOLUME AT A 1.5m DEPTH (20m3 FOR SMALL, 30m3 FOR LARGE TREES)
- PROPOSED SHRUBS / PERENNIALS
- PROPOSED SOD
- PROPOSED PRECAST CONCRETE PAVERS
- PROPOSED ENGINEERED WOOD FIBRE
- TREE PROTECTION FENCE
- EXISTING LIGHT STANDARD
- EXISTING FIRE HYDRANT
- EXISTING TRANSFORMER
- EMERGENCY ENTRANCE / SERVICE DOORS
- MAIN ENTRANCE
- APPROXIMATE EXTENT OF EXCAVATION

No.	Issue	Date	DR	CK
13	REVISED PER NEW SITE PLAN	03/11/2026	ML	JL
12	REVISED PER NEW SITE PLAN	03/04/2026	ML	JL
11	STAIRS REVISED	01/13/2026	WF	JL
10	ISSUED FOR MINOR VARIANCE	03/26/2025	ML	JL
9	ISSUED FOR BUILDING PERMIT	02/19/2025	ML	JL
8	ISSUED PER CITY COMMENTS	10/09/2024	ML	JL
7	ISSUED FOR COORDINATION	09/04/2024	ML	JL
6	REVISED PER FORESTRY COMMENTS	07/31/2024	ML	JL
5	REVISED PER NEW SITE PLAN	07/10/2024	ML	JL
4	REVISED PER CITY COMMENTS	07/05/2024	ML	JL
3	ISSUED FOR SITE PLAN CONTROL	06/14/2024	ML	JL
2	ISSUED FOR 33% REVIEW	12/01/2023	ML	JL
1	ISSUED FOR DISCUSSION AND REVIEW	11/01/2023	ML	JL

**JAMES B. LENNOX & ASSOCIATES INC.**  
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PROJECT  
**BLOCK 3 REDEVELOPMENT**  
1360 OGILVIE ROAD, OTTAWA ON

DRAWING  
**TREE CONSERVATION REPORT & LANDSCAPE PLAN**

STAMP

SCALE  
AS SHOWN

START DATE  
OCTOBER 2023

PROJECT NO.  
23CSV218

PROJECT NORTH

DRAWING NO.  
**L.1**

PLOT SIZE ARCH-D

D07-12-24-0061 #19156