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CSW
 Landscape Architecture
 Urban Design
 Site Planning
 Recreation and Park Planning
 Project Management
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NO.	ISSUE/REVISION	DATE
4	RE-ISSUED TO SITE PLAN CONTROL	2022-12-09
3	RE-ISSUED TO SITE PLAN CONTROL	2022-08-19
2	RE-ISSUED TO SITE PLAN CONTROL	2022-04-26
1	ISSUED TO SITE PLAN CONTROL	2021-10-29

NOT FOR CONSTRUCTION


PROJECT
**CF RIDEAU CENTRE
 REGISTRY SITE**

PROJECT ADDRESS
 70 NICOLAS ST.
 OTTAWA, ON


TITLE
**LANDSCAPE
 DETAILS
 (GROUND LEVEL)**

PROJECT NO.	DRAWN	CHECKED
2088-01	SE	JC


DRAWING NO.	REVISION NO.
L2.0	1

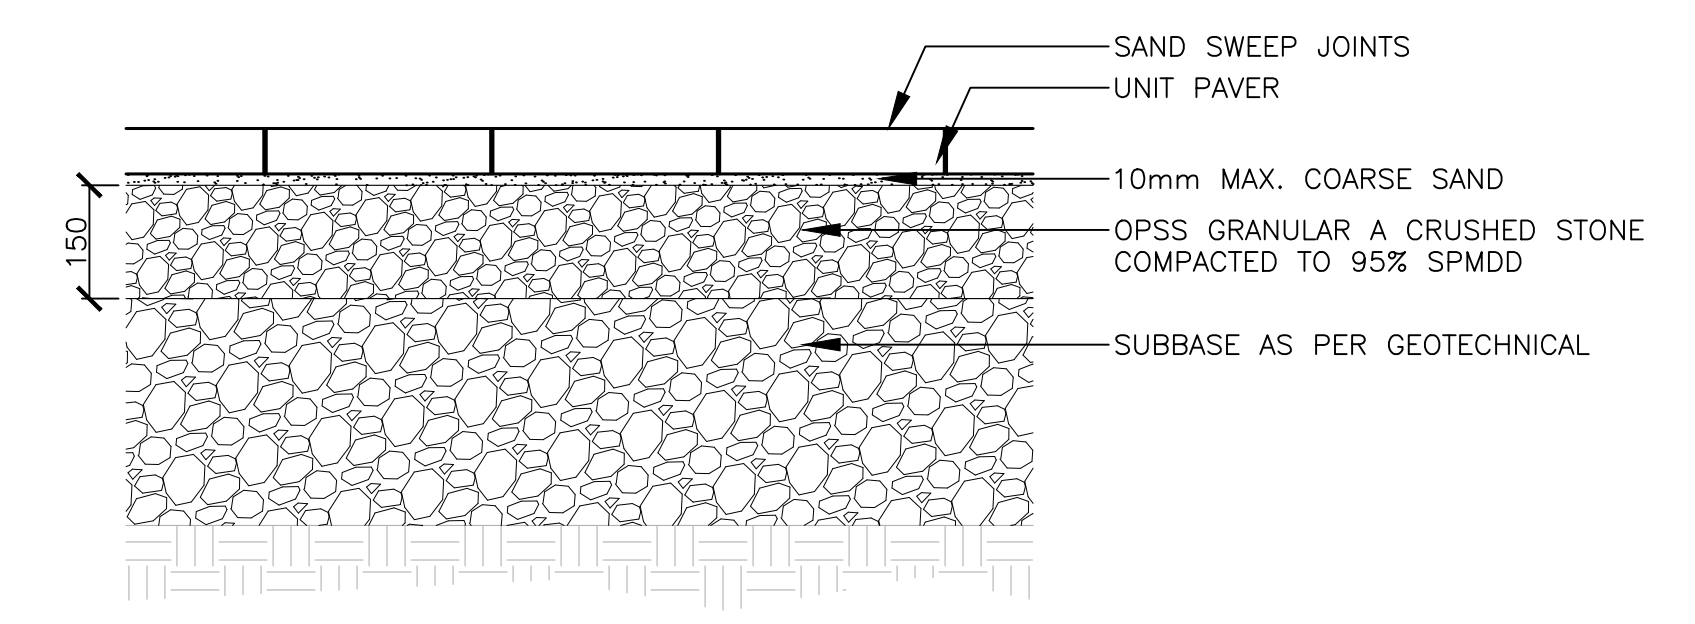


1 UNIT PAVING (VEHICULAR) Scale: 1:10

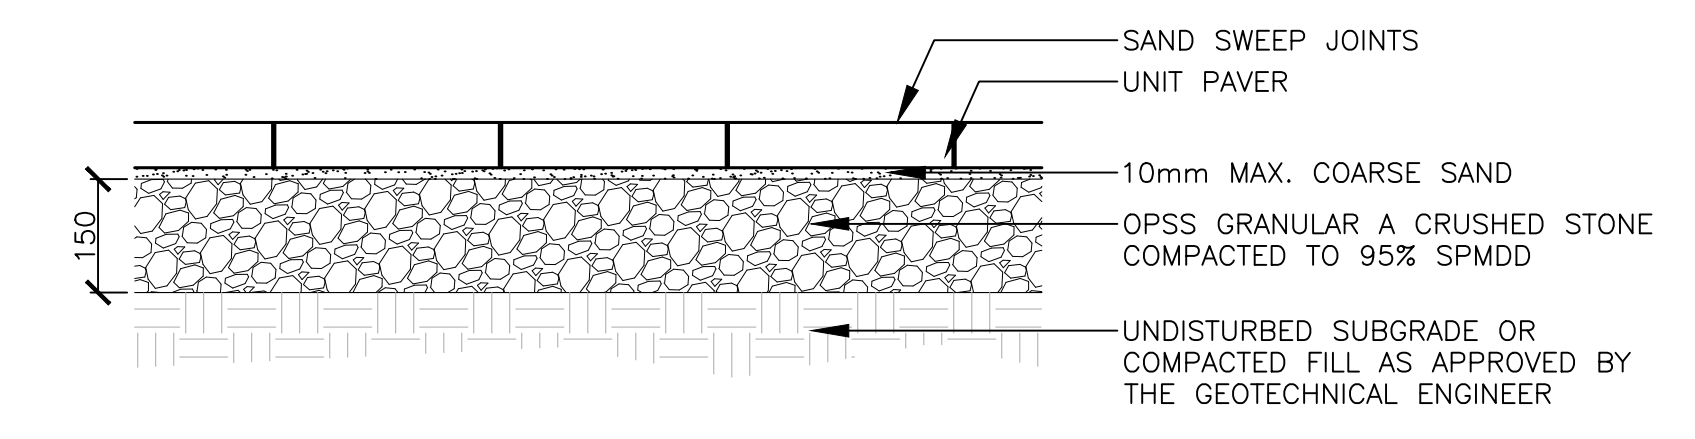


2 UNIT PAVING (PEDESTRIAN) Scale: 1:10

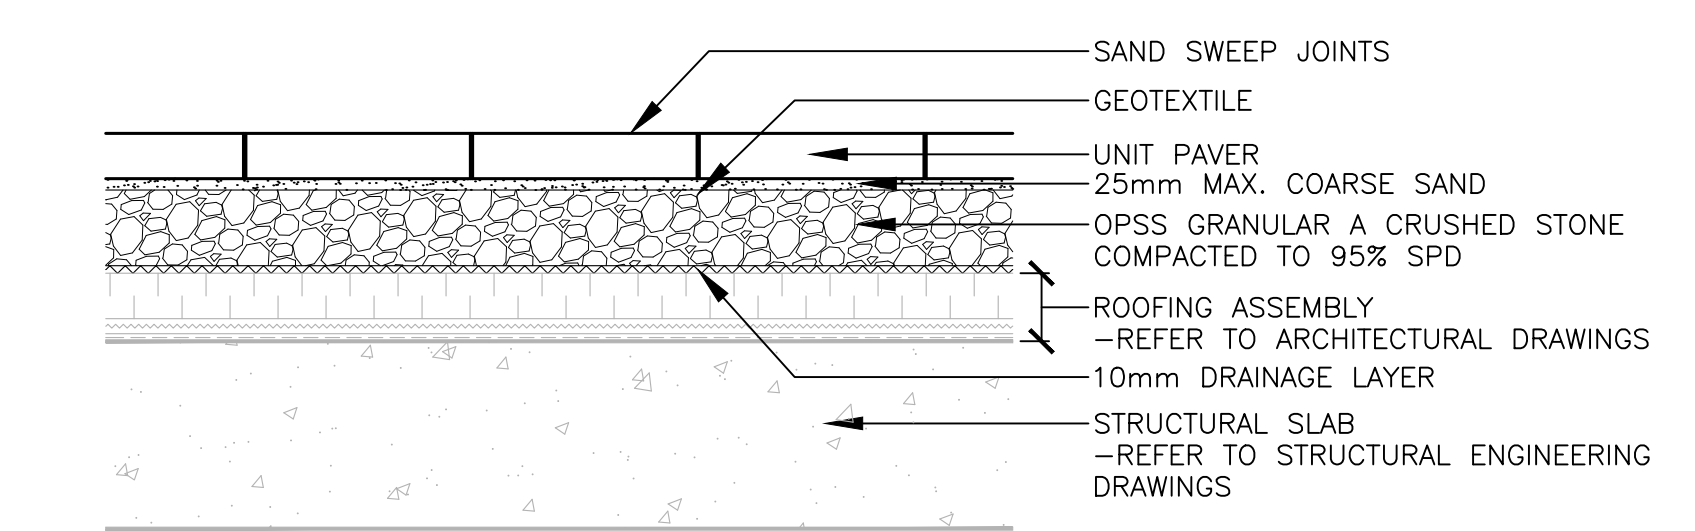


3 UNIT PAVING OVER SLAB Scale: 1:10

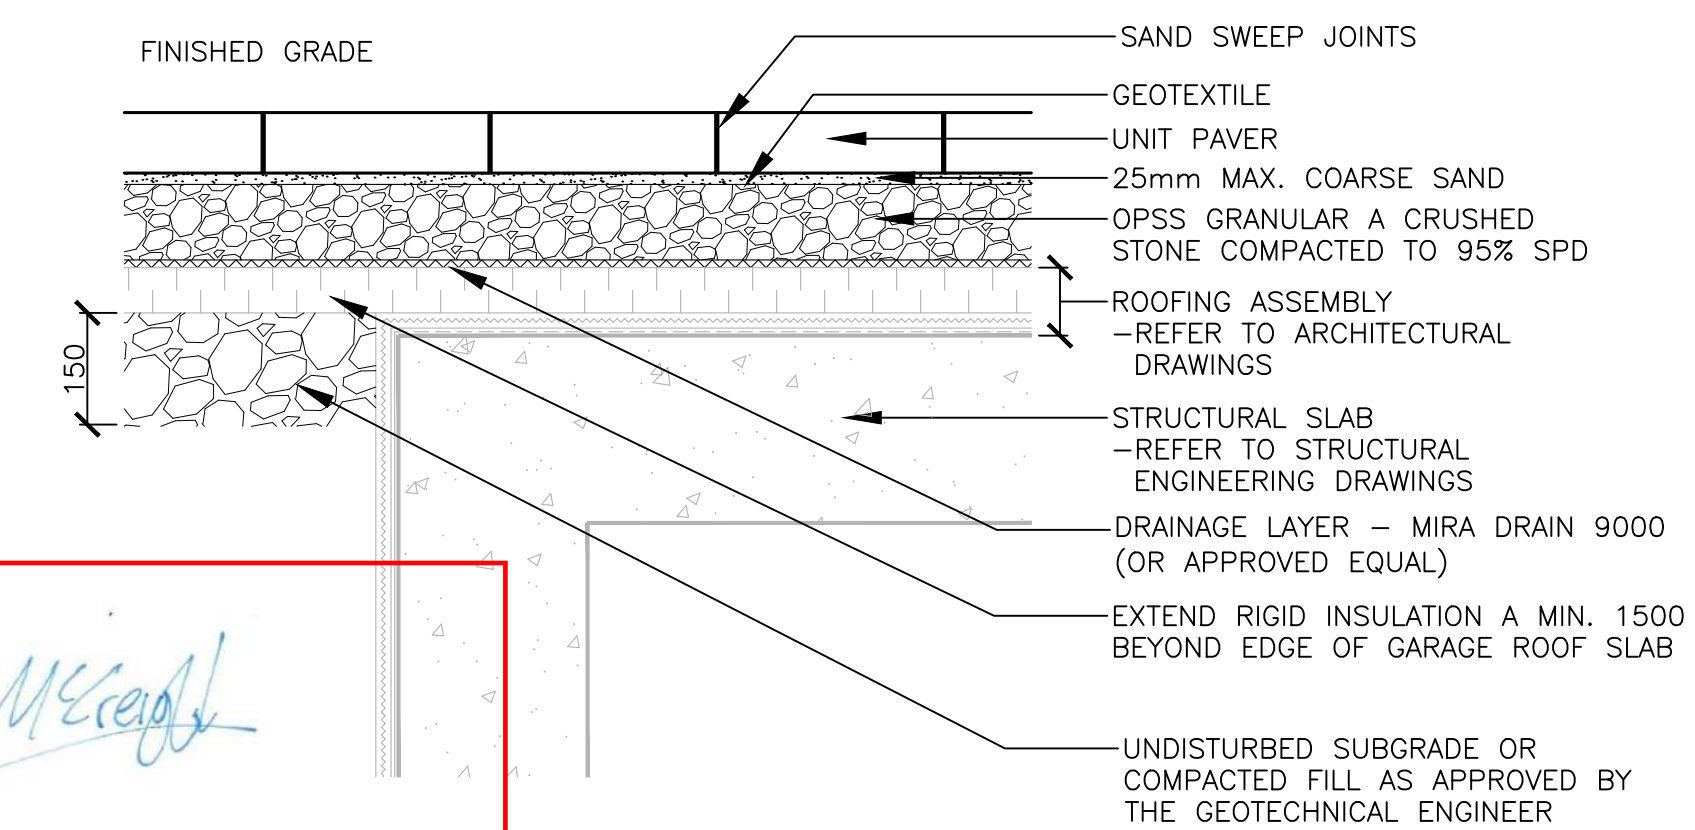

5 GRANITE CURB Scale: 1:10

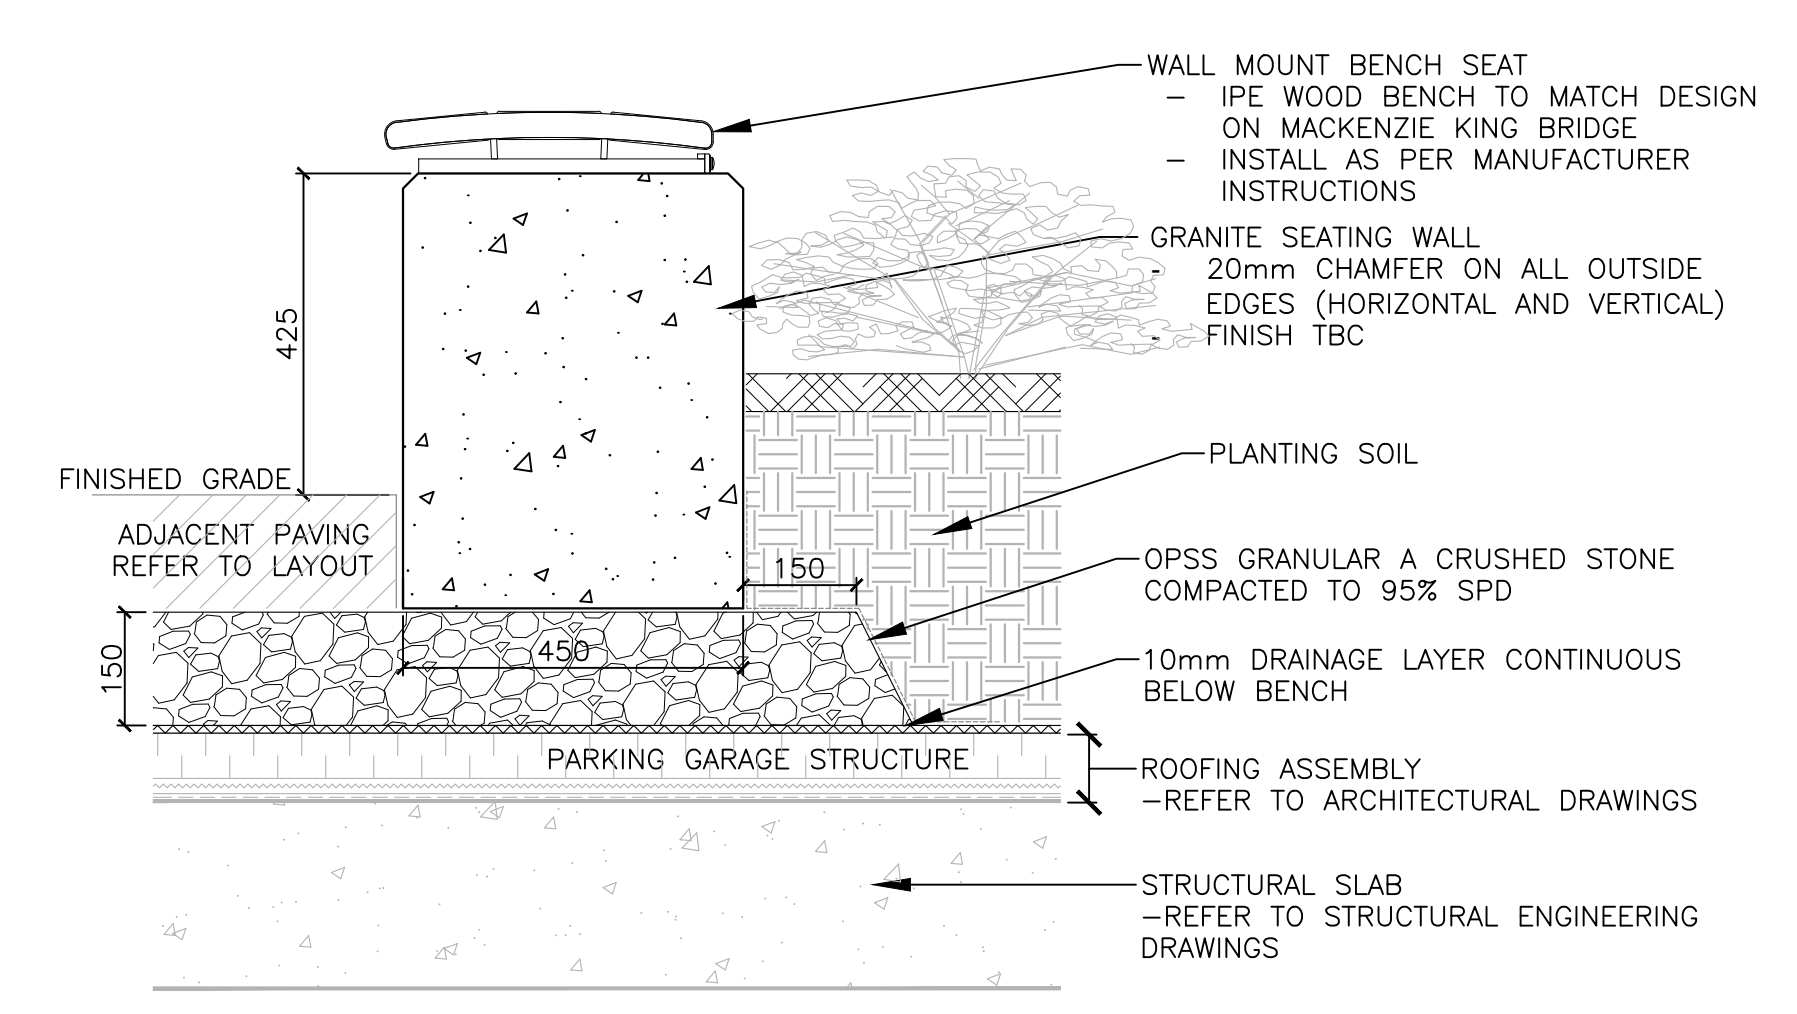


6 GRANITE SEATING WALL Scale: 1:10

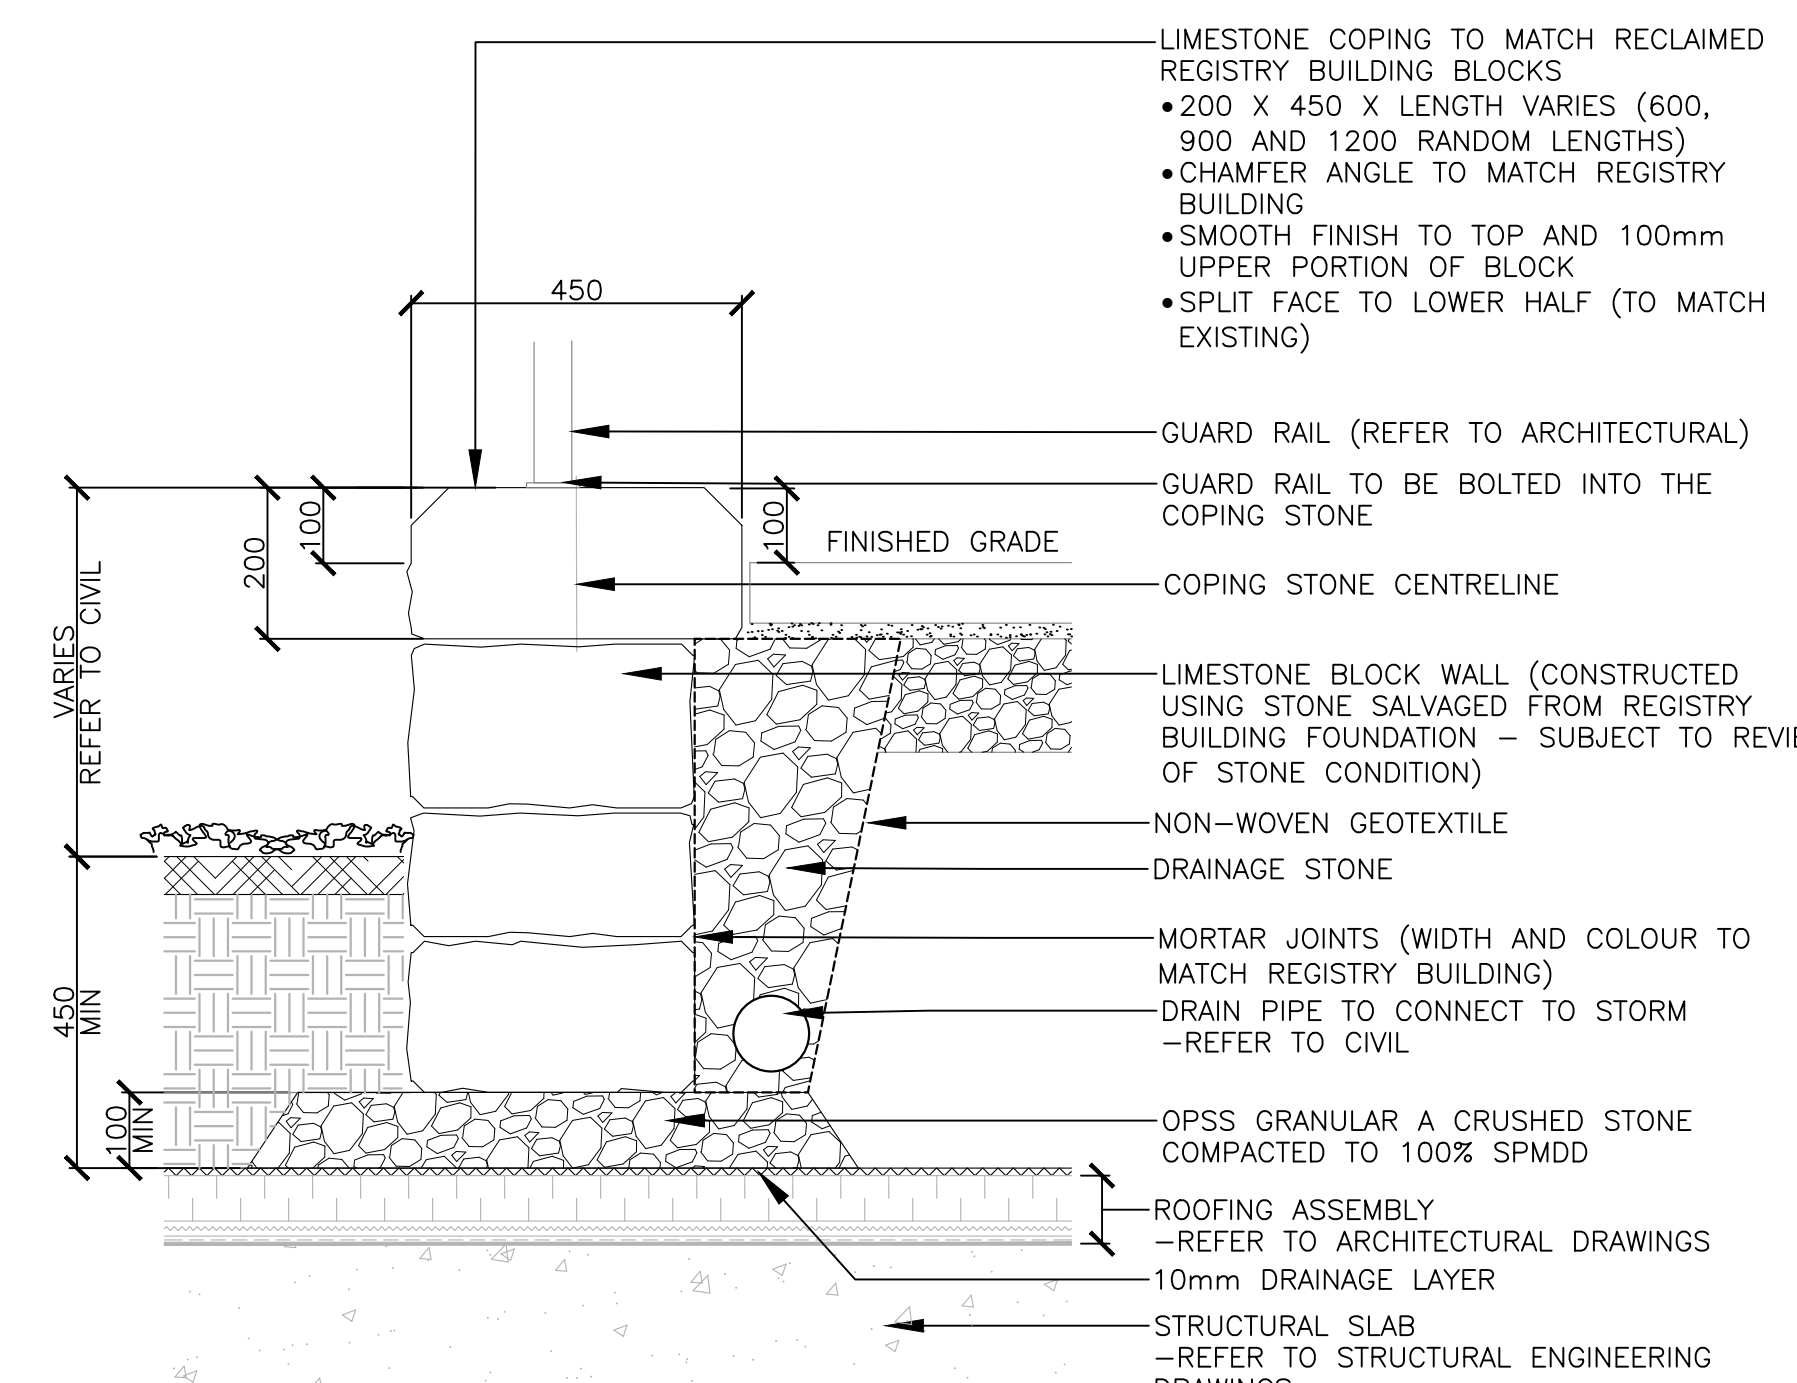


NOTES:
 1. TOP OF WALL TO REMAIN AT CONSISTENT ELEVATION. REFER TO GRADING PLAN FOR ELEVATIONS
 2. BOTTOM COURSE TO BE BURIED MINIMUM 2/3 HEIGHT.
 3. EXCAVATION AND SUBGRADE CONDITION TO BE REVIEWED BY GEOTECHNICAL ENGINEER.
 4. DRILL AND DOWEL AS REQUIRED FOR STRUCTURAL SUPPORT AT GUARDRAIL POSTS.
 5. CONTRACTOR TO PROVIDE ENGINEER STAMPED SHOP DRAWINGS FOR REVIEW.

7 RETAINING WALL Scale: 1:10

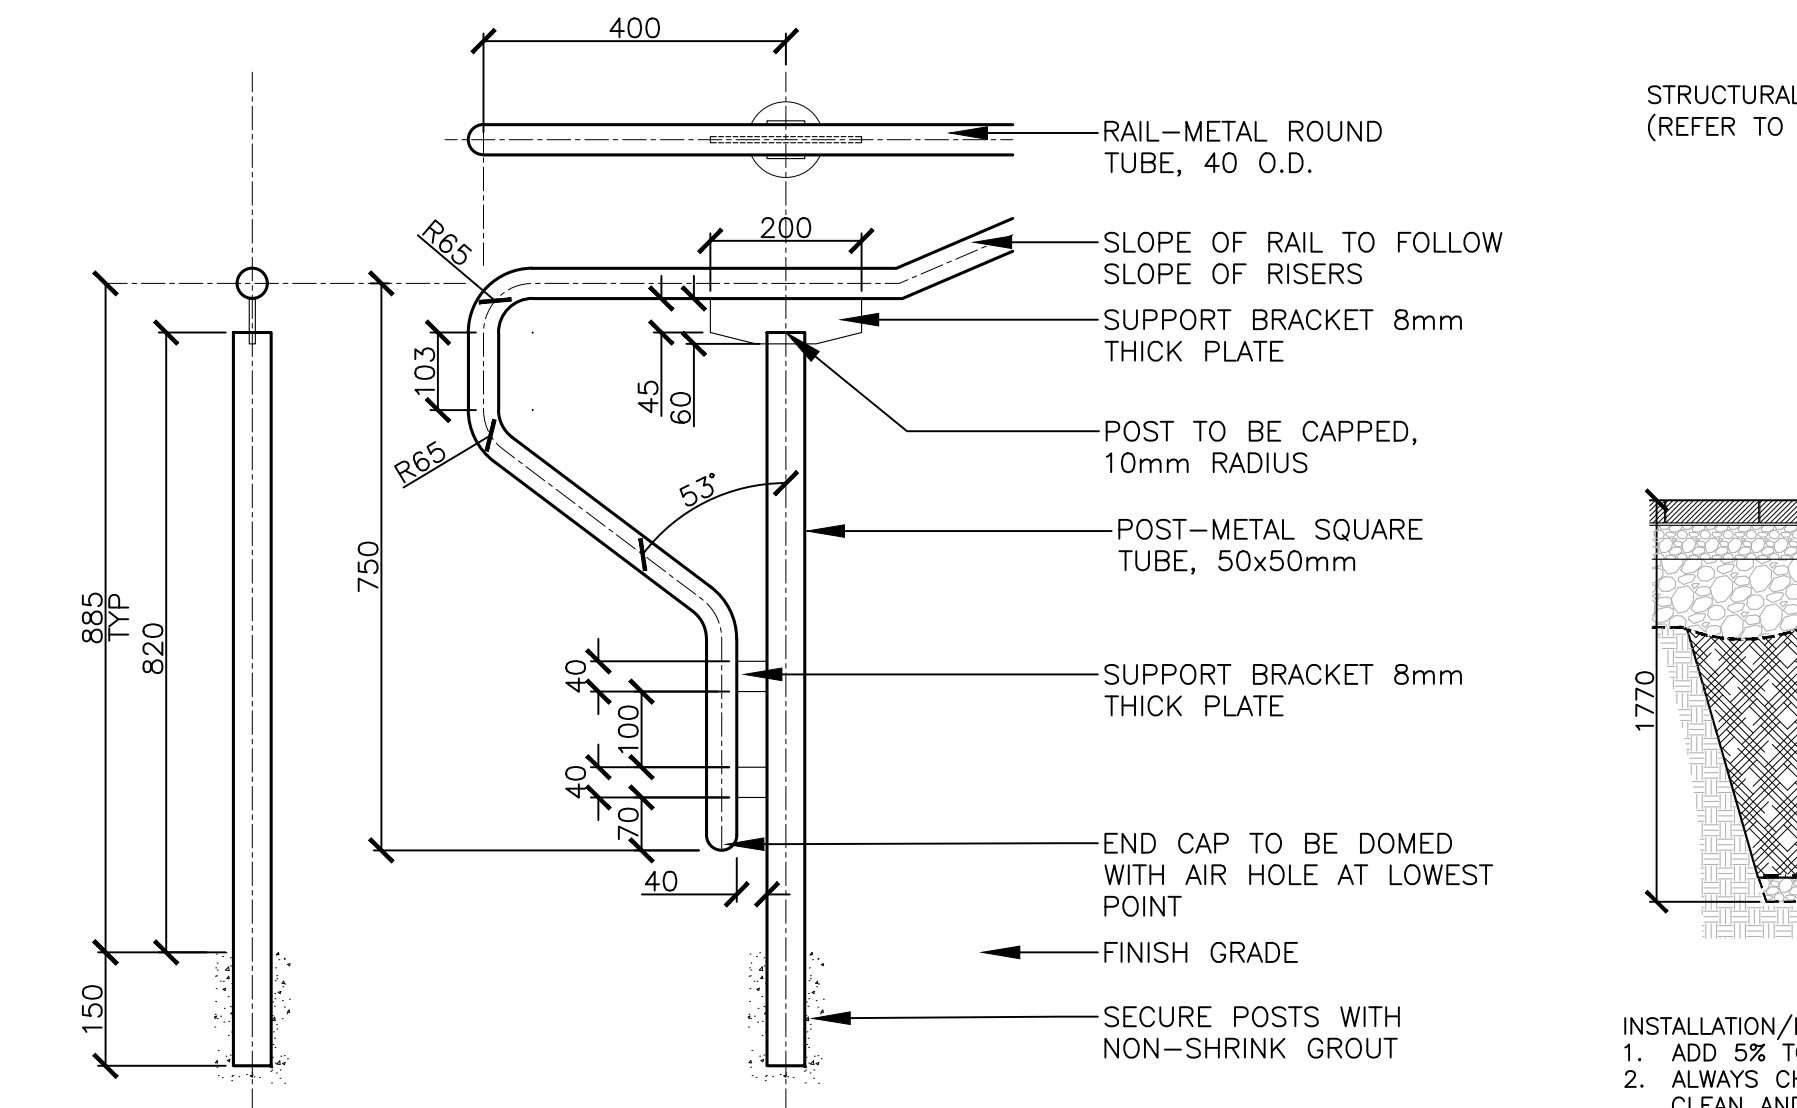


NOTES:
 1. HANDRAIL TO BE MARINE GRADE, SAE 316, STAINLESS STEEL
 2. ALL WELDS TO BE FULL LENGTH AND BOTH SIDES OF ALL METAL SURFACES
 3. GRIND SMOOTH ALL JOINTS AND EDGES
 4. CONTRACTOR TO SUBMIT SHOP DRAWINGS FOR REVIEW PRIOR TO FABRICATION

8 HANDRAIL Scale: 1:10

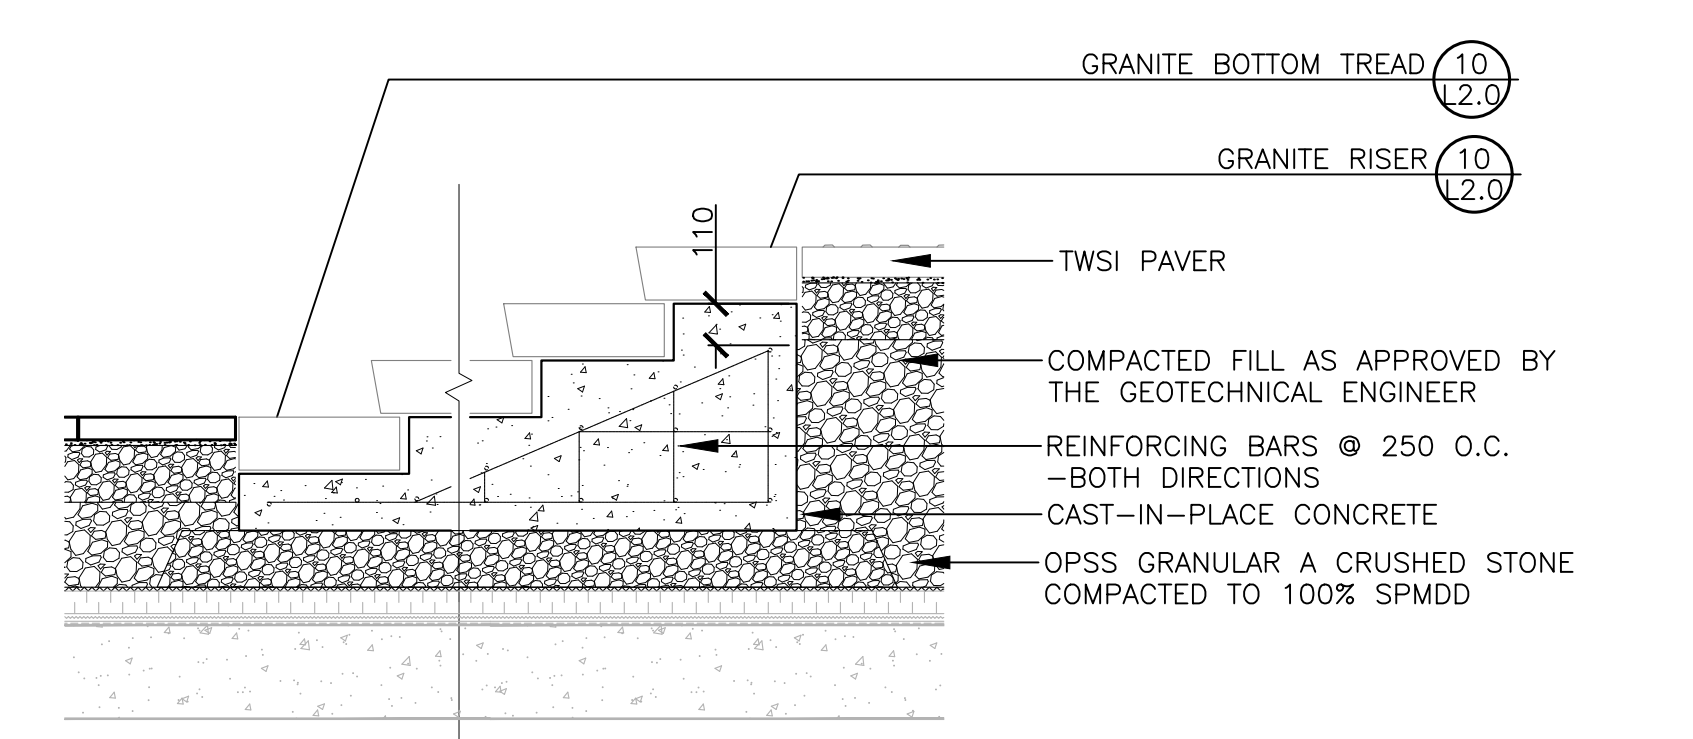


NOTES:
 - GRANULAR BASE TO BE INSPECTED AND APPROVED BY GEOTECHNICAL ENGINEER
 - ALL REINFORCING IN STAIRS TO BE 15M EPOXY-COATED
 - MAINTAIN 75mm COVER OVER REINFORCING IN CONCRETE.

9 GRANITE STEPS Scale: 1:20

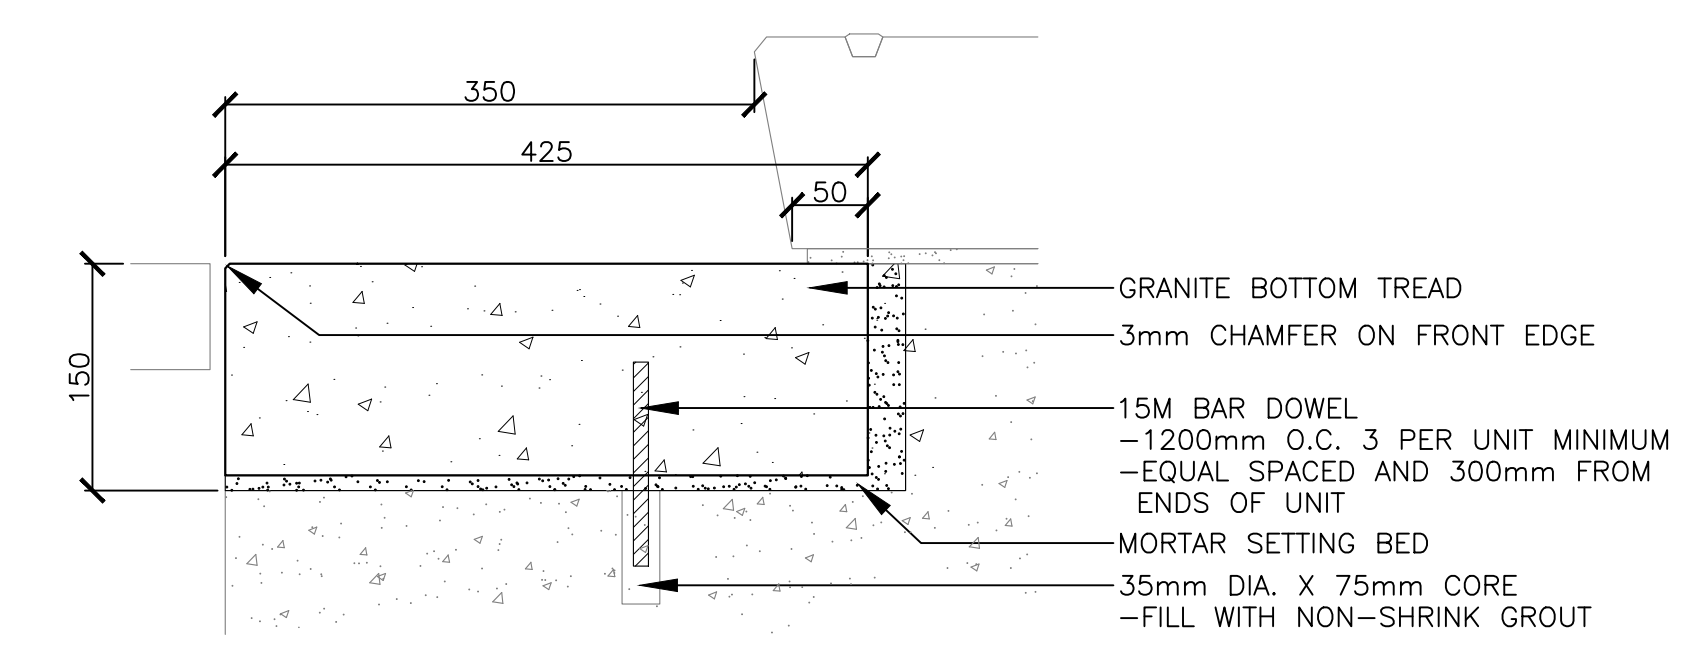


BOTTOM TREAD

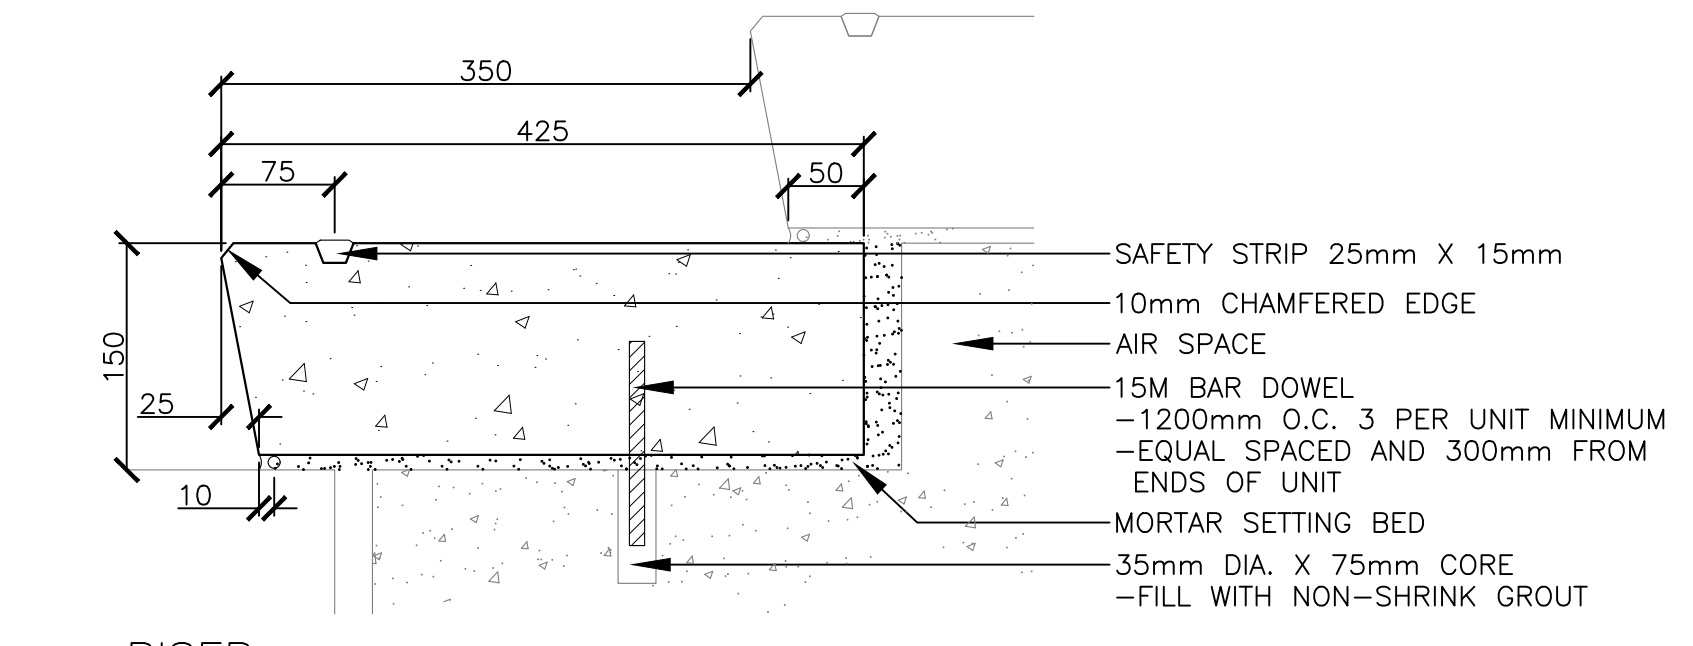

RISER

NOTES:
 • ALL RISERS AS PART OF SET OF STAIRS SHALL HAVE THE SAME HEIGHT AND WIDTH OF TREAD
 • SAFETY STRIP
 - CARBORUNDUM / EPOXY MIX
 - RAISED TEXTURE (MAX. 2mm) SET INTO EACH STAIR TREAD
 - TERMINATE SAFETY STRIP 50mm FROM EDGE OF TREAD
 • SLOPE TREADS TO DRAIN AT 1% (ENSURE POSITIVE DRAINAGE ON ALL TREADS)
 • COLOUR AND FINISH: TO BE DETERMINED AT TIME OF SHOP DRAWINGS REVIEW
 • ALL JOINTS TO BE FILLED WITH BACKER ROD AND CAULKED.
 • CONTRACTOR TO SUBMIT SHOP DRAWINGS FOR REVIEW PRIOR TO FABRICATION

10 STEP TREADS Scale: 1:10

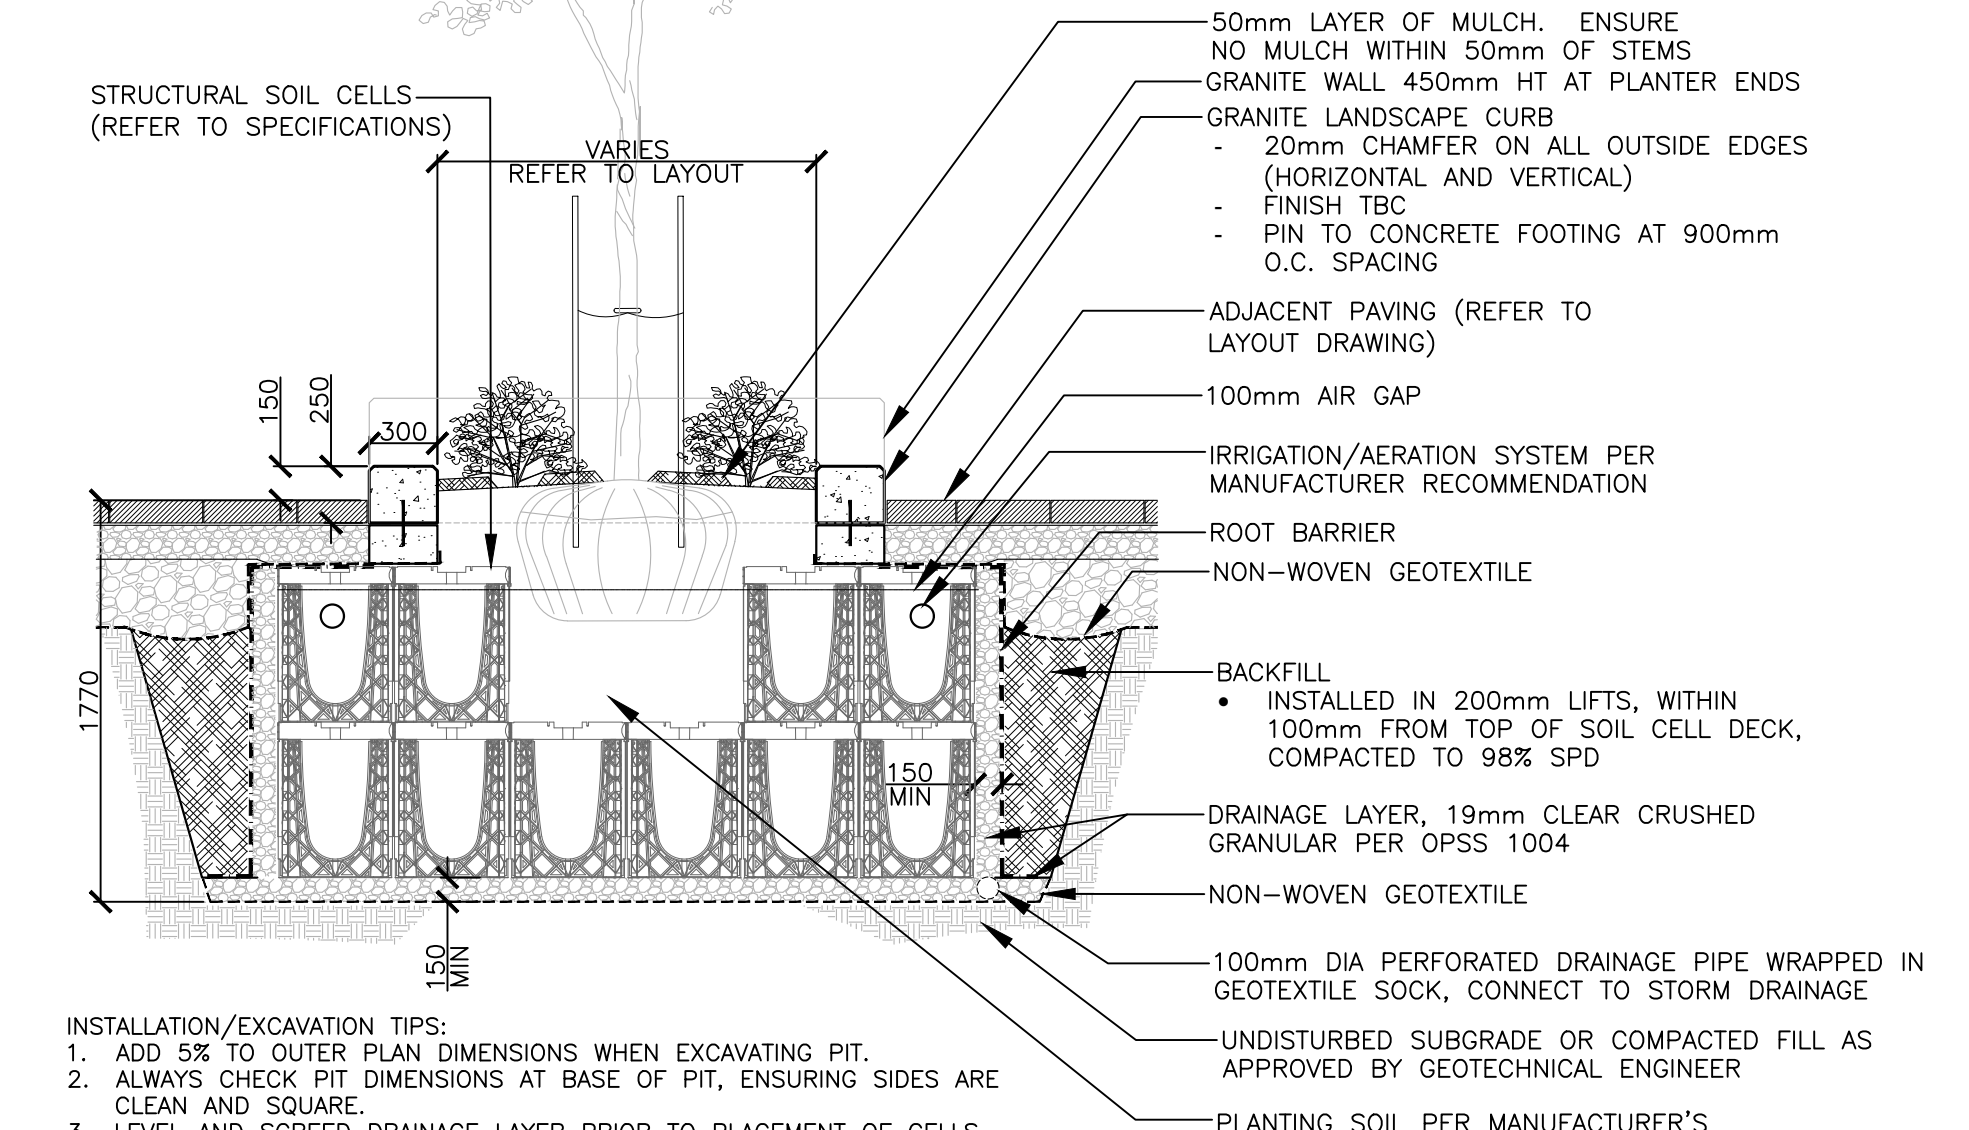

INSTALLATION/EXCAVATION TIPS:
 1. ADD 5% TO OUTER PLAN DIMENSIONS WHEN EXCAVATING PIT.
 2. ALWAYS CHECK PIT DIMENSIONS AT BASE OF PIT, ENSURING SIDES ARE CLEAN AND SQUARE.
 3. LEVEL AND SCREED DRAINAGE LAYER PRIOR TO PLACEMENT OF CELLS.

NOTES:
 1. REFER TO CIVIL FOR DRAINAGE CONNECTIONS
 2. CONTRACTOR IS RESPONSIBLE TO REVIEW ALL SITE CONDITIONS PRIOR TO INSTALLATION INCLUDING FIELD CONDITIONS OF UNDERGROUND SERVICES
 3. CONTRACTOR TO COORDINATE AND SUBMIT SHOP DRAWINGS FOR REVIEW PRIOR TO INSTALLATION. SHOP DRAWINGS SHALL INCLUDE DETAILS FOR TRANSITIONING AROUND UTILITIES.

11 STREET TREE PLANTER Scale: 1:30

ANDREW MCCREIGHT
 MANAGER (A), DEVELOPMENT REVIEW CENTRAL
 PLANNING, REAL ESTATE & ECONOMIC DEVELOPMENT
 DEPARTMENT, CITY OF OTTAWA

APPROVED
 By Andrew McCreight at 3:04 pm, May 23, 2023