



1 FLOOR PLAN: INTERIOR LAYOUT  
SCALE: 1 : 100

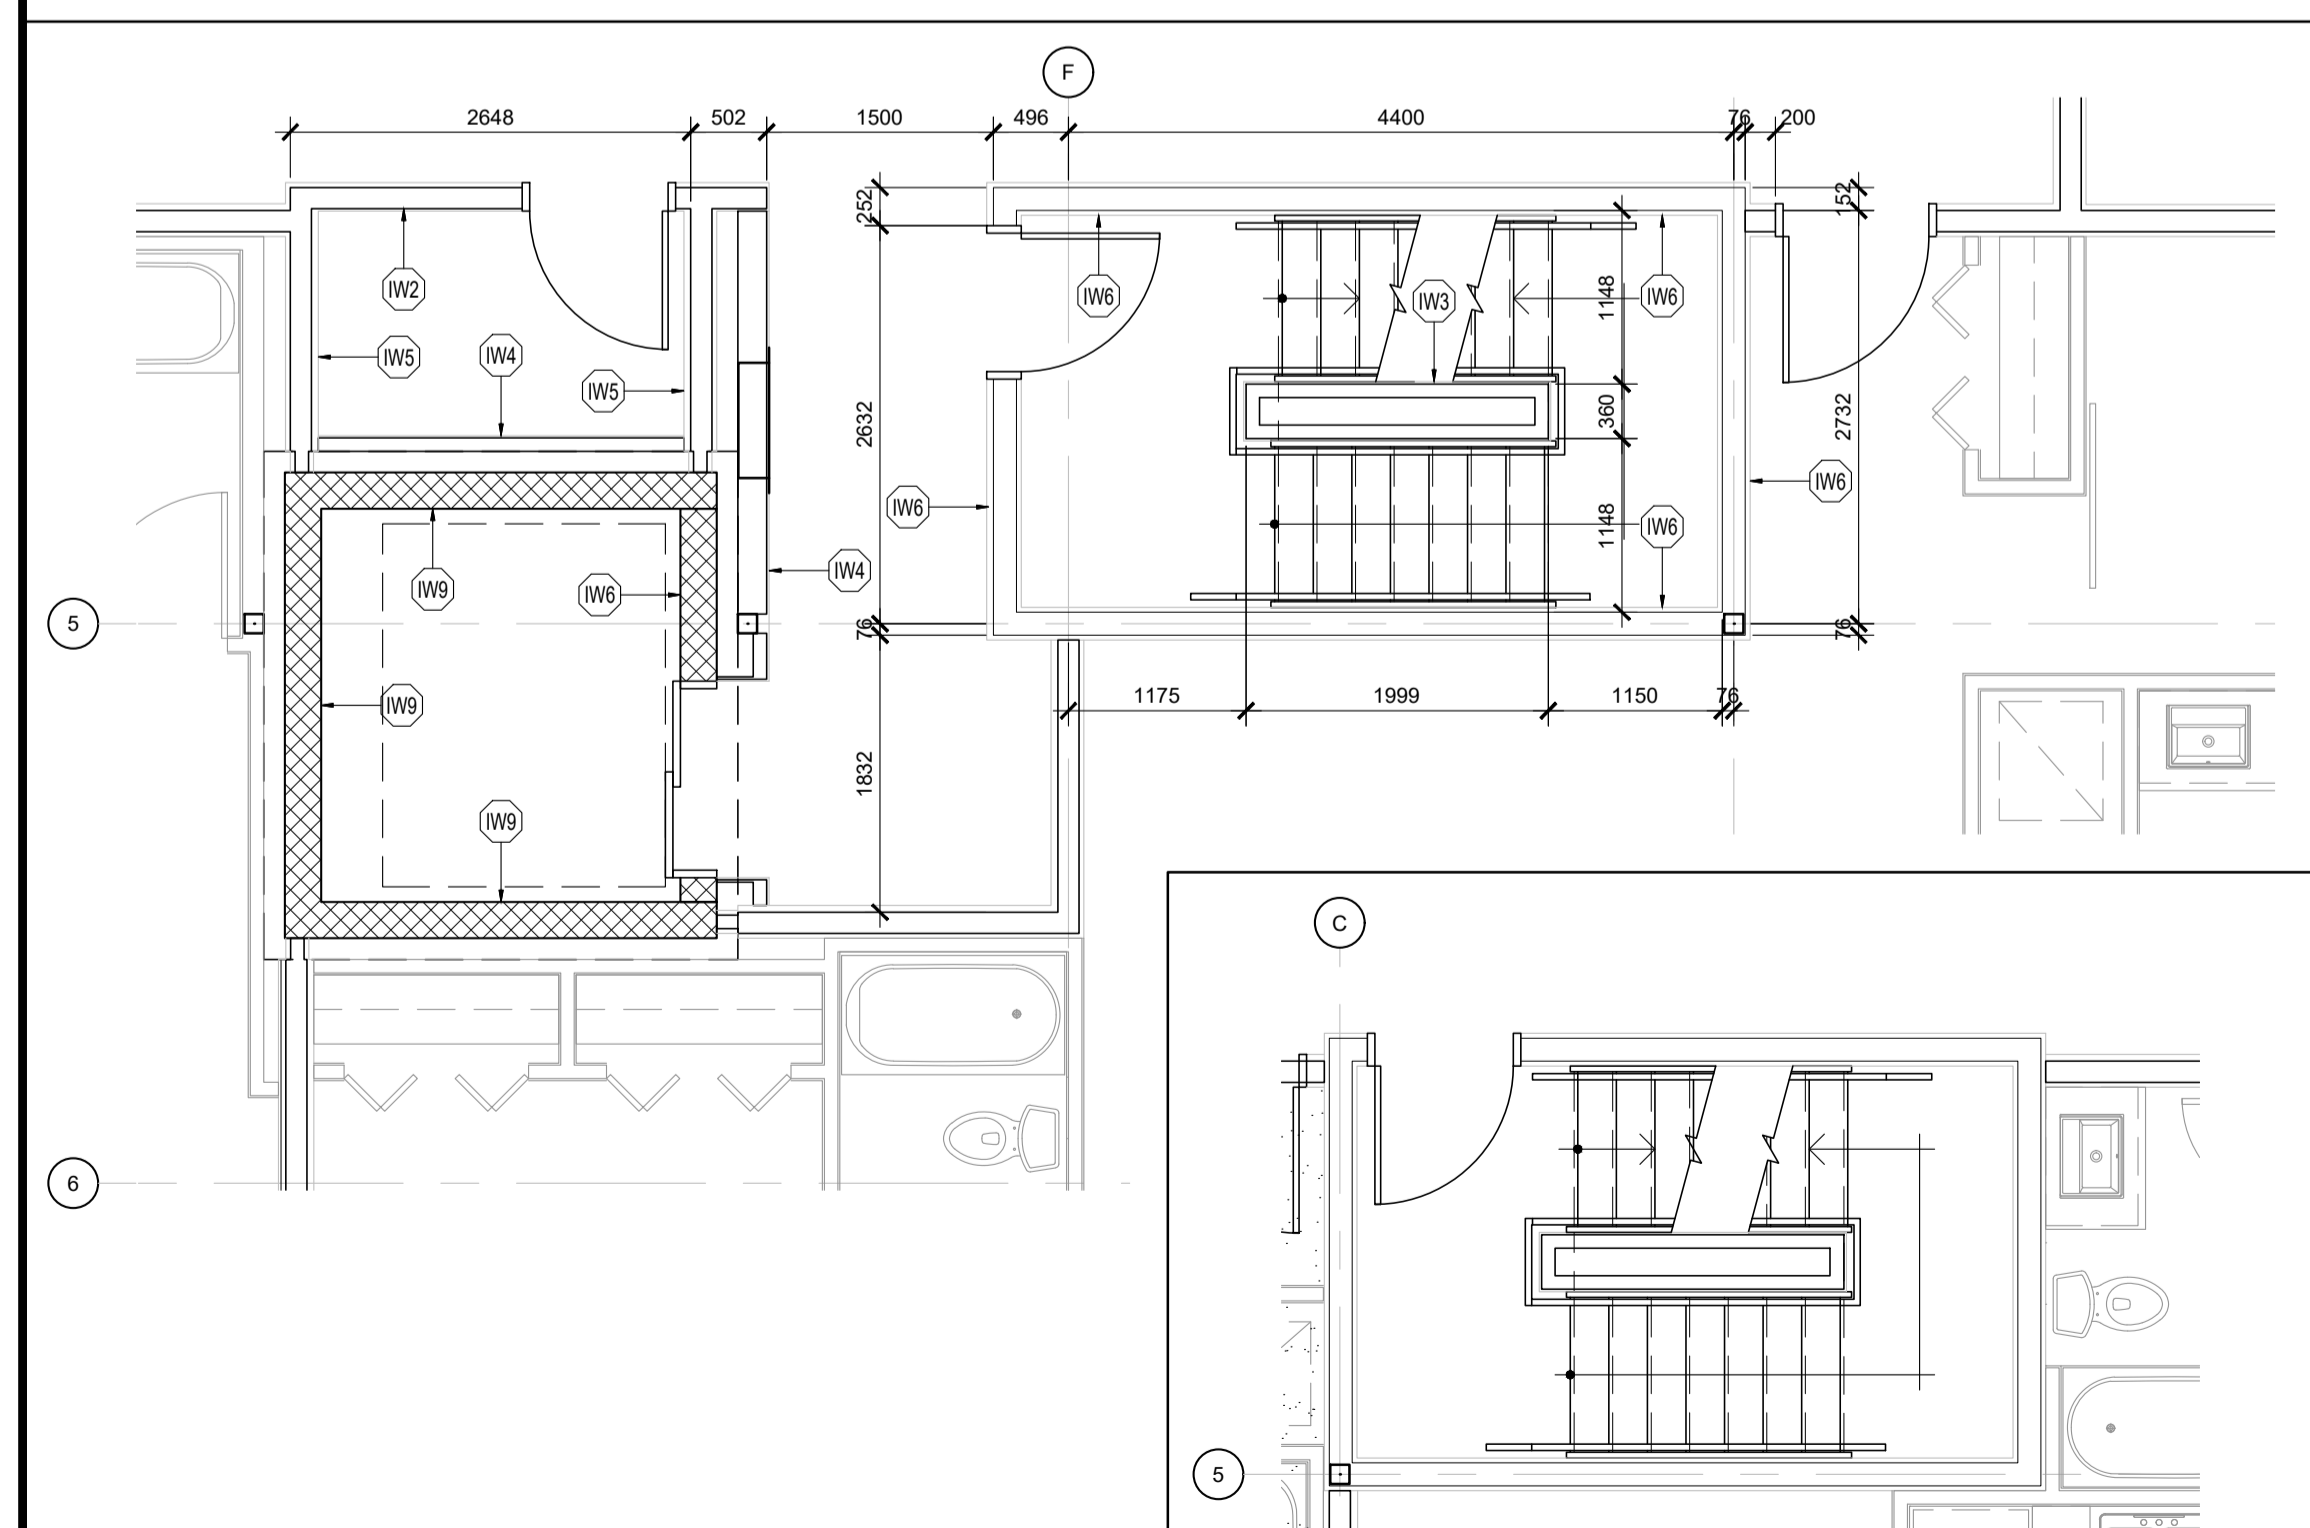

2 FLOOR PLAN: INTERIOR LAYOUT  
SCALE: 1 : 50

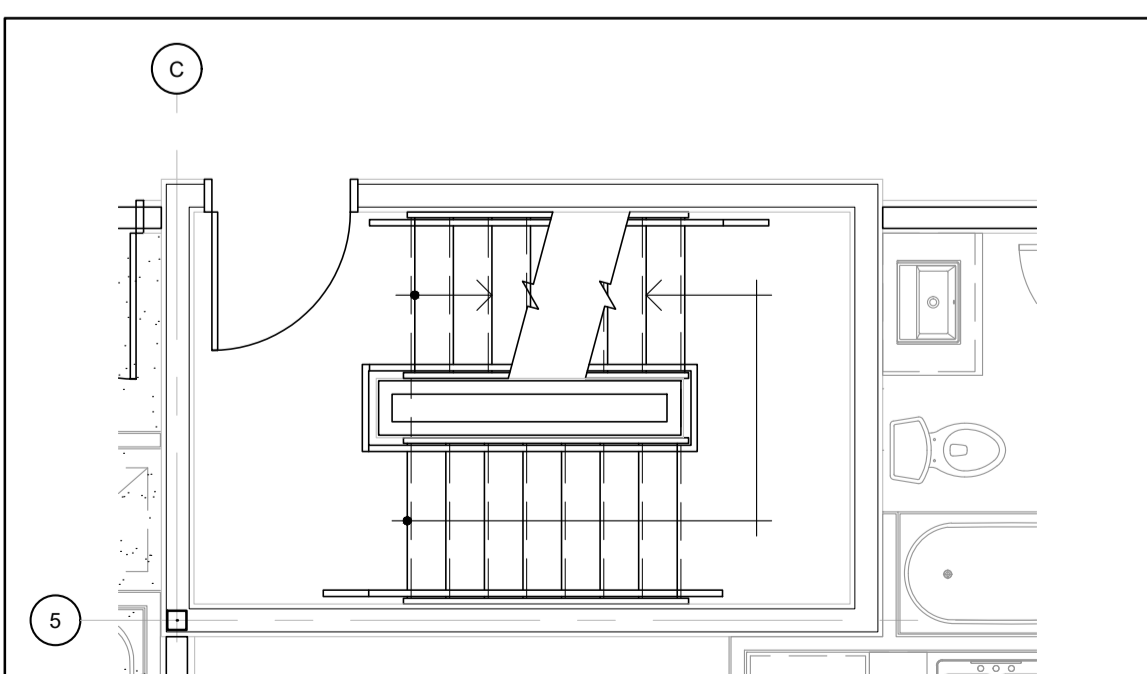

3 FLOOR PLAN: INTERIOR LAYOUT  
SCALE: 1 : 50

**WALL ASSEMBLY FRR LEGEND:**

- 1.5 HOUR FIRE RESISTANCE RATING, REFER TO ASSEMBLY SCHEDULE
- 1 HOUR FIRE RESISTANCE RATING, REFER TO ASSEMBLY SCHEDULE
- WHERE OBC SB-2 IS REFERENCED TO ACHIEVE THE REQUIRED MINIMUM FRR, THE FOLLOWING COMPONENT RATINGS WERE USED VIA THE ADDITIVE METHOD:
  - 2x13mm TYPE 'X' GYPSUM BOARD: 80 min (TABLE 2.3.4 A)
  - 16mm TYPE 'X' GYPSUM BOARD: 40 min (TABLE 2.3.4 A)
  - 13mm TYPE 'X' GYPSUM BOARD: 25 min (TABLE 2.3.4 A)
  - WOOD STUDS: 20 min (TABLE 2.3.4 E)
  - FULL DEPTH INSULATION: 15 min (TABLE 2.3.4 G)

**INTERIOR WALL ASSEMBLIES:**

**(W1) PARTY WALL**

- 2 LAYERS 13mm TYPE 'X' GYPSUM BOARD
- 13mm RESILIENT FURRING CHANNEL
- 38x140 WOOD STUD FRAMING @ 400mm o/c w/ FULL DEPTH INSULATION
- 2 LAYERS 16mm TYPE 'X' GYPSUM BOARD

1 HOUR FRR ACHIEVED THROUGH OBC SB-2. STC RATING: 53, OBC SB-3, W6c

**\*NOTE: MAKE THE FOLLOWING SUBSTITUTION AT SHEAR-WALLS (REFER TO STRUCTURAL)**

- 2 LAYERS STRUCTURAL SHEATHING
- 16mm TYPE 'X' GYPSUM BOARD

**(W2) INTERIOR WALL: 1HR FRR**

- 16mm TYPE 'X' GYPSUM BOARD
- 38x89 or 140 WOOD STUD FRAMING @ 400mm o/c w/ FULL DEPTH INSULATION
- 16mm TYPE 'X' GYPSUM BOARD

1 HOUR FRR ACHIEVED THROUGH OBC SB-2.

**(W3) INTERIOR WALL**

- 16mm GYPSUM BOARD
- 38x89, 140 or 184 WOOD STUD FRAMING @ 400mm o/c
- 16mm GYPSUM BOARD

**(W4) INTERIOR WALL, ONE-SIDED FINISH**

- 16mm GYPSUM BOARD
- 38x89, 140 or 184 WOOD STUD FRAMING @ 400mm o/c

**(W5) CORRIDOR WALL**

- 2 LAYERS 16mm TYPE 'X' GYPSUM BOARD
- 13mm RESILIENT FURRING CHANNEL @ 600mm o/c
- 140mm WOOD STUDS (REFER TO STRUCTURAL) c/w FULL DEPTH INSULATION
- 2 LAYERS 16mm TYPE 'X' GYPSUM BOARD

1 HOUR FRR ACHIEVED THROUGH ULC U334 STC RATING: 62

**\*NOTE: 16mm TYPE 'X' GYPSUM BOARD PERMITTED TO BE SUBSTITUTED w/ 13mm TYPE 'X' GYPSUM BOARD UNDER OBC SB-2, c/w STC RATING: min 55, OBC SB-3, W6d**

**(W6) STAIR ENCLOSURE WALL**

- 2 LAYERS 16mm TYPE 'X' GYPSUM BOARD
- 92mm or 152mm STEEL STUDS @ 400mm o/c, c/w FULL DEPTH MINERAL FIBRE INSULATION
- 2 LAYERS 16mm TYPE 'X' GYPSUM BOARD

1.5 HOUR FRR ACHIEVED THROUGH ULC W453 STC RATING: 59, OBC SB-3, 59a

**\*NOTE: 16mm TYPE 'X' GYPSUM BOARD PERMITTED TO BE SUBSTITUTED w/ 13mm TYPE 'X' GYPSUM BOARD UNDER OBC SB-2, c/w STC RATING: 57, OBC SB-3, 59b**

**(W7) SHAFT WALL**

- 2 LAYERS 16mm TYPE 'X' GYPSUM BOARD
- 64mm C-H STUDS @ 600mm o/c c/w 25mm GYPSUM LINER PANEL

2 HOUR FRR ACHIEVED THROUGH ULC W446 SYSTEM F

**EXTERIOR WALL ASSEMBLY NOTES & LEGEND:**

- 2x LAYER OF 13mm TYPE 'X' GYPSUM BOARD c/w 13mm RESILIENT FURRING CHANNELS @ 600mm o/c
- 2x LAYER OF 13mm TYPE 'X' GYPSUM BOARD

1 HOUR FRR ACHIEVED THROUGH OBC SB-2.

**EXTERIOR WALL ASSEMBLIES:**

**(EW1) EXTERIOR WALL (MASONRY)**

- 90mm MASONRY VENEER (REFER TO ELEVATIONS AND SPECIFICATIONS FOR TYPE)
- 25mm - 41mm AIR SPACE (SEE ASSEMBLY LEGEND)
- 50mm RIGID INSULATION (Rsi 1.8 / R10c)
- AIR BARRIER
- SHEATHING (REFER TO ELEVATIONS + STRUCTURAL FOR SHEAR-WALL LOCATIONS & REQUIREMENTS)
- 38x140 WOOD STUDS (REFER TO STRUCTURAL) c/w FULL DEPTH INSULATION (Rsi 3.5 / R20)
- VAPOUR BARRIER
- 16mm TYPE 'X' GYPSUM BOARD

**(EW2) EXTERIOR WALL (METAL SIDING)**

- METAL SIDING
- 75mm Z-BARS (ORIENTED PERPENDICULAR TO SIDING) @ 600mm o/c c/w 50mm RIGID INSULATION (Rsi 1.8 / R10c)
- AIR BARRIER
- SHEATHING (REFER TO ELEVATIONS + STRUCTURAL FOR SHEAR-WALL LOCATIONS & REQUIREMENTS)
- 38x140 WOOD STUDS (REFER TO STRUCTURAL) c/w FULL DEPTH INSULATION (Rsi 3.5 / R20)
- VAPOUR BARRIER
- 13mm RESILIENT FURRING CHANNEL @ 600mm o/c (WHERE INDICATED ON FLOOR PLANS)
- 13mm TYPE 'X' GYPSUM BOARD (2x LAYER WHERE INDICATED ON FLOOR PLANS)

**(EW3) BALCONY WING WALL**

- CLADDING\*
- AIR BARRIER
- SHEATHING (REFER TO STRUCTURAL FOR SHEAR-WALL LOCATIONS & REQUIREMENTS)
- 38x140 WOOD STUDS (REFER TO STRUCTURAL) c/w FULL DEPTH INSULATION
- 2x16mm ORIENTED STRAND BOARD SHEATHING
- AIR BARRIER
- CLADDING\*

**\*NOTE: CLADDING TO BE THE ONE OF THE FOLLOWING (REFER TO PLANS AND ELEVATIONS FOR LOCATIONS):**

- 90mm MASONRY VENEER (REFER TO ELEVATIONS AND SPECIFICATIONS FOR TYPE)
- 25mm AIR SPACE
- ALUMINUM COMPOSITE PANEL
- 16mm EXTERIOR GRADE GYPSUM BOARD SHEATHING
- 38x184 WOOD STUDS @ 400mm o/c
- 75mm Z-BARS @ 600mm o/c

**(EW4) EXTERIOR WALL (PODIUM, NORTH)**

- VERTICAL METAL SIDING
- 135mm HORIZONTAL Z-BARS @ 600mm o/c c/w 100mm RIGID INSULATION (Rsi 3.6 / R20c)
- AIR / VAPOUR BARRIER
- 16mm EXTERIOR GRADE GYPSUM BOARD SHEATHING
- 38x184 WOOD STUDS @ 400mm o/c
- 16mm TYPE 'X' GYPSUM BOARD

**GENERAL NOTES**

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- IT IS THE RESPONSIBILITY OF THE GENERAL CONTRACTOR TO VERIFY DIMENSIONS ON SITE; REPORT DISCREPANCIES TO THE ARCHITECT PROMPTLY.
- GENERAL CONTRACTOR TO TAKE INTO ACCOUNT CONSTRUCTION TOLERANCE; GENERAL CONTRACTOR TO COORDINATE THE WORK OF DIFFERENT TRADES TO COMPLY WITH DESIGN INTENT.
- ALL WORK DESCRIBED IN THESE DRAWINGS AND SPECIFICATIONS ARE TO COMPLY WITH THE CURRENT EDITION OF THE ONTARIO BUILDING CODE (2012) OR NATIONAL BUILDING CODE (2010) INCLUDING MOST RECENT AMENDMENTS.
- DRAWINGS AND SPECIFICATIONS ARE COMPLEMENTARY AND ARE TO BE READ TOGETHER.

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3	ISSUED FOR CONSULTANT COORD.	2020-03-30
4	ISSUED FOR COORDINATION	2020-06-12
5	ISSUED FOR SITE PLAN APPLICATION	2020-06-29
6	ISSUED FOR 50% COORDINATION	2020-10-06
7	REISSUED FOR SITE PLAN APPLICATION	2020-10-15
8	ISSUED FOR PERMIT	2020-11-06
9	ISSUED FOR COORDINATION	2020-11-26
10	ISSUED FOR COORDINATION	2021-01-29

**KEY PLAN**

**CLIENT**

**LANDRIC HOMES**  
TEL: 819-593-4895  
1173 CYRVILLE RD, SUITE 202  
OTTAWA, ON, K1J 7S6

**DCA**  
A GROUP OF ARCHITECTS  
201-1339 WELLINGTON ST. WEST OTTAWA ON K1J 3B8  
WWW.ARCHITECTSDCA.COM 613.725.2294


**PROJECT TITLE**  
HILLPARK APARTMENTS  
70 & 80 SILO STREET  
OTTAWA (ORLEANS), ON

**DRAWING TITLE**  
THIRD FLOOR PLAN:  
WEST BUILDING

DATE	DRAWN	JOB NO.	DRAWING NO.
OCT. 2019	IC   DR	3206	A206

SCALE AS NOTED REVIEWED TO

**ARCHITECTURAL**

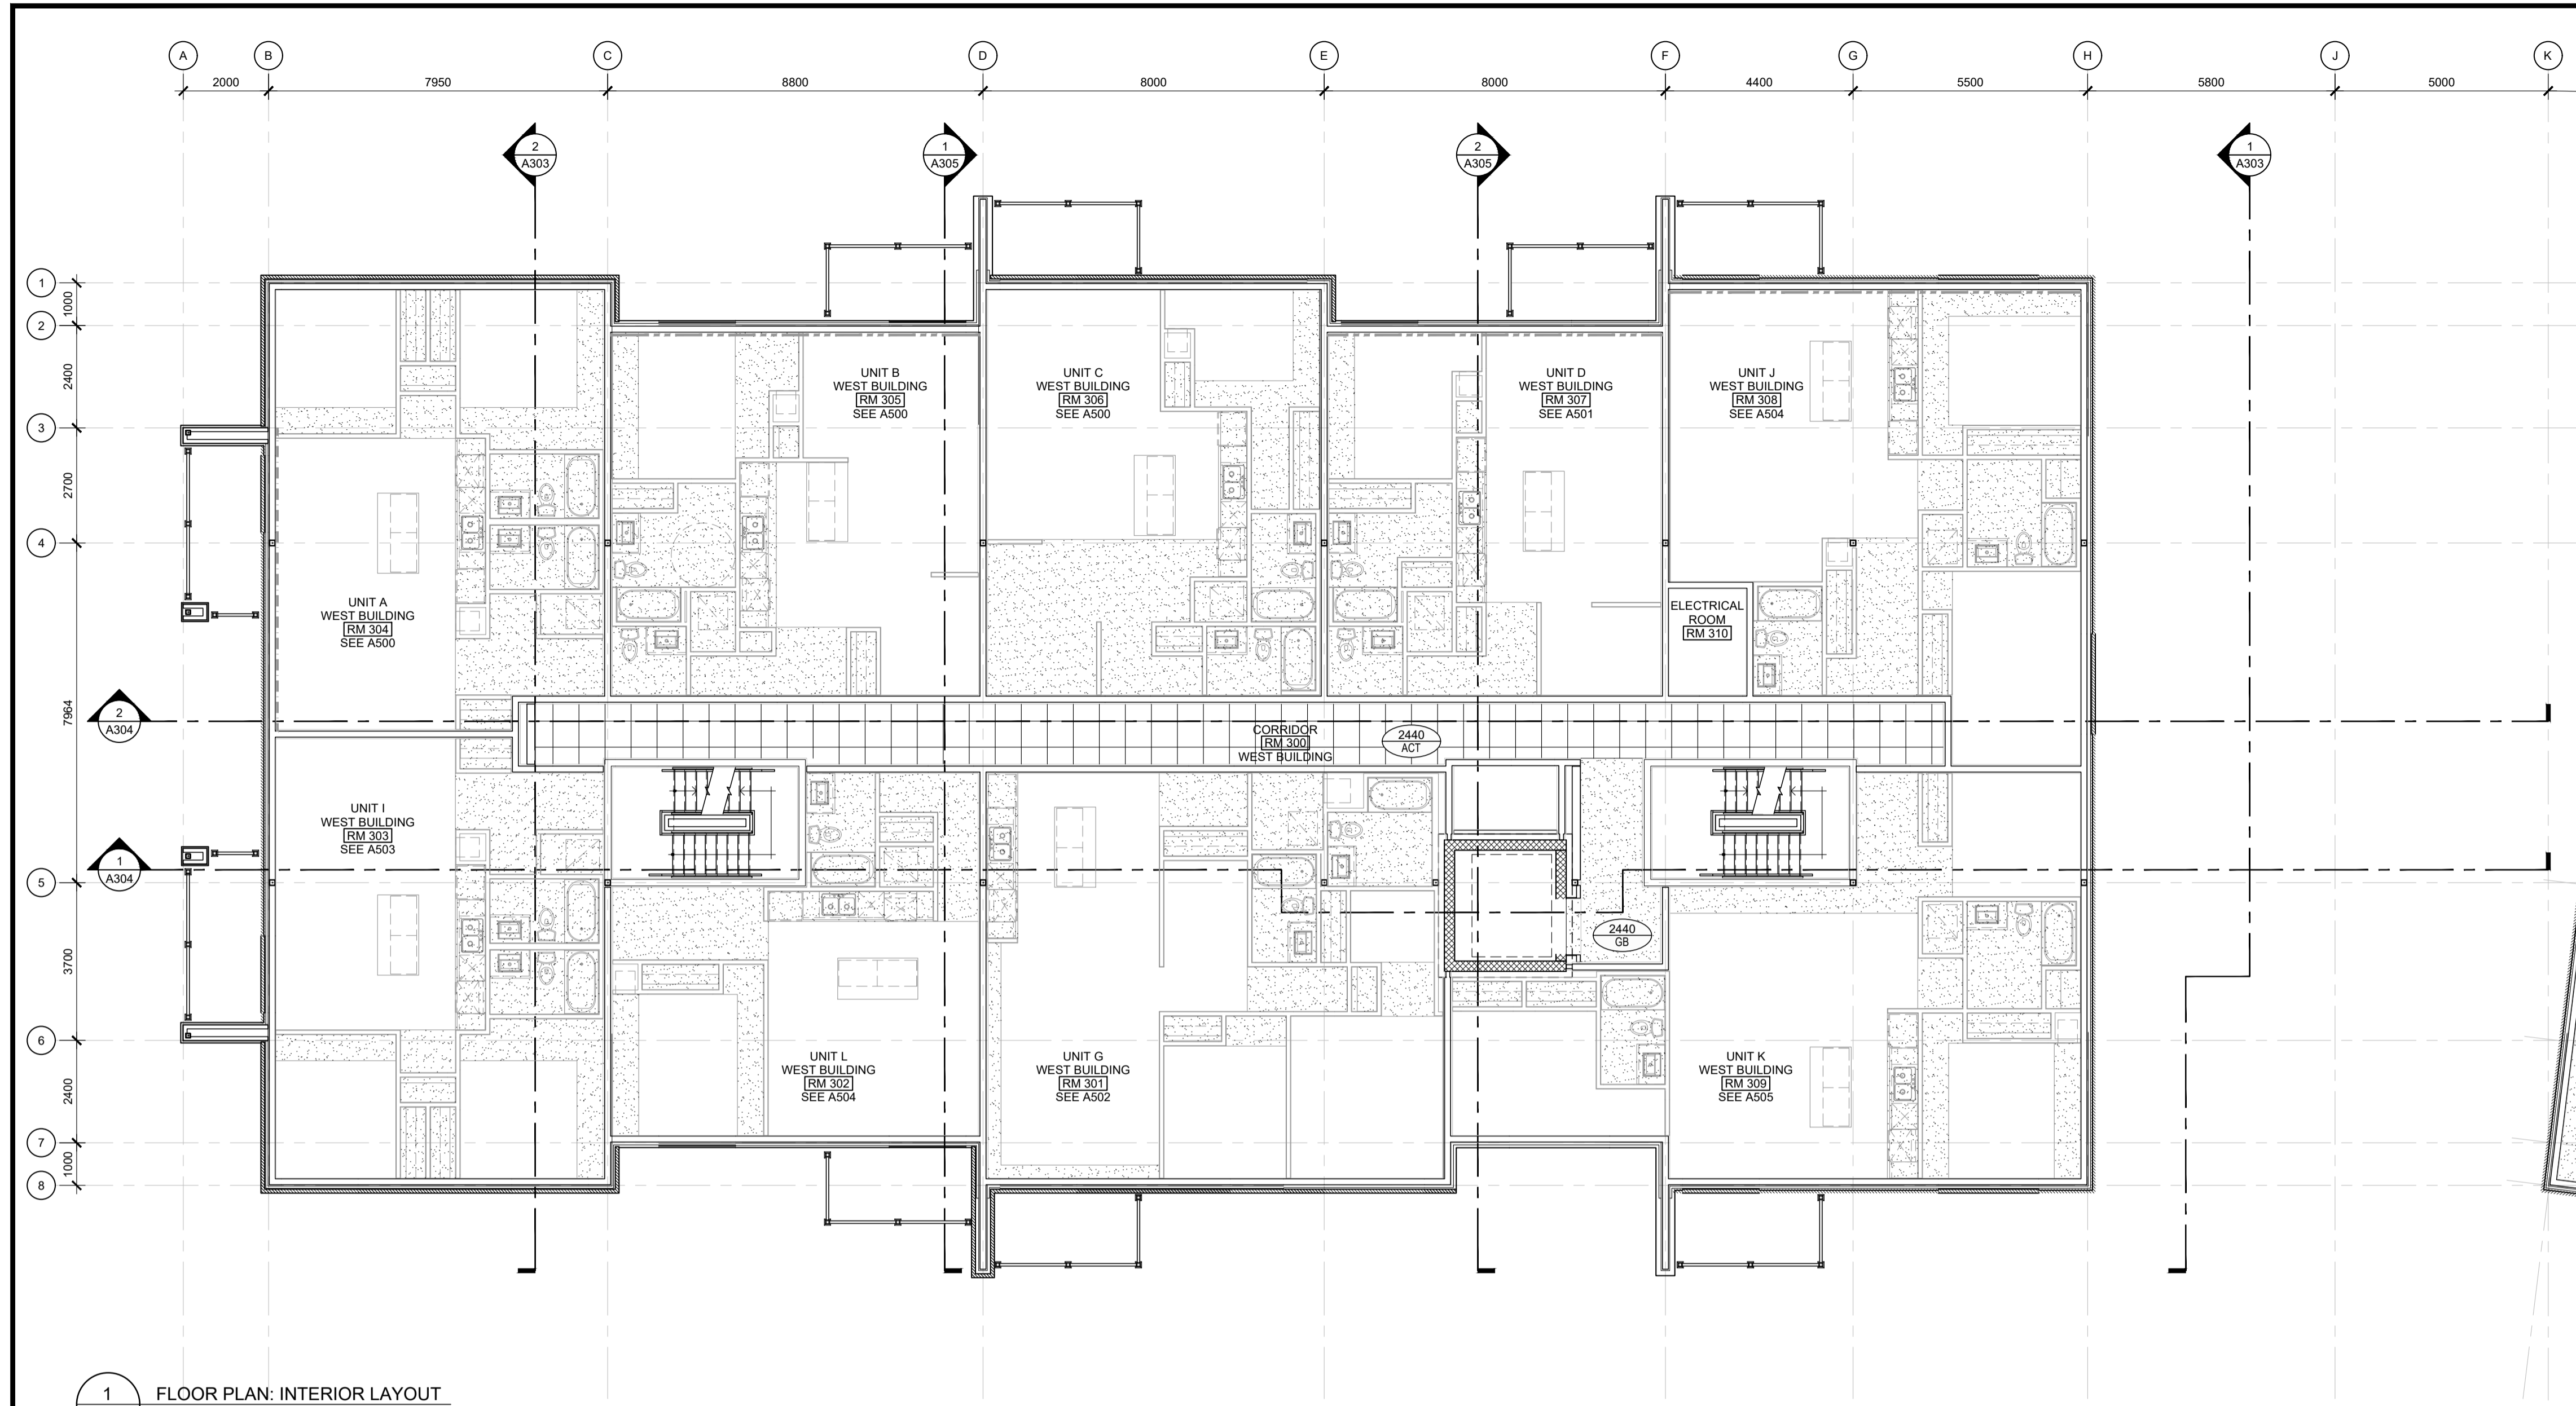


1 FLOOR PLAN: INTERIOR LAYOUT  
A256 SCALE: 1 : 100

- UNIT FLOOR PLAN NOTES & LEGEND:**
1. SWING DOORS TO BE FRAMED 75mm FROM CORNER, UNLESS NOTED OTHERWISE.
  2. FOLDING DOORS TO BE CENTERED IN CLOSET / OPENING, UNLESS NOTED OTHERWISE.
  3. LINEN CLOSETS TO INCLUDE 5x SHELVES.
  4. CLOSETS TO INCLUDE 1x SHELF, 1x HANGING ROD.


- UNIT REFLECTED CEILING PLAN NOTES & LEGEND:**
1. TYPICAL CEILINGS TO BE u/s OF FLOOR / ROOF ASSEMBLY ABOVE, UNLESS NOTED OTHERWISE.
- 
- BULKHEAD TO CONCEAL MECHANICAL ROUTING TO BE CONSTRUCTED OF 38x64 WOOD STUDS @ 600mm o/c c/w 13mm GYPSUM AT 2440mm ABOVE FLOOR, UNLESS NOTED OTHERWISE.
  - FINISHED CEILING HEIGHT
  - FINISHED CEILING MATERIAL
  - 610mm x 610mm ACOUSTIC CEILING TILE

- GENERAL NOTES**
1. DO NOT SCALE DRAWINGS; ONLY FIGURED DIMENSIONS ARE TO BE USED. WHERE DOUBT EXISTS, FILE REQUEST FOR INTERPRETATION AND REQUEST CLARITY.
  2. IT IS THE RESPONSIBILITY OF THE GENERAL CONTRACTOR TO VERIFY DIMENSIONS ON SITE; REPORT DISCREPANCIES TO THE ARCHITECT PROMPTLY.
  3. GENERAL CONTRACTOR TO TAKE INTO ACCOUNT CONSTRUCTION TOLERANCE; GENERAL CONTRACTOR TO COORDINATE THE WORK OF DIFFERENT TRADES TO COMPLY WITH DESIGN INTENT.
  4. ALL WORK DESCRIBED IN THESE DRAWINGS AND SPECIFICATIONS ARE TO COMPLY WITH THE CURRENT EDITION OF THE ONTARIO BUILDING CODE (2012) OR NATIONAL BUILDING CODE (2010) INCLUDING MOST RECENT AMENDMENTS.
  5. DRAWINGS AND SPECIFICATIONS ARE COMPLEMENTARY AND ARE TO BE READ TOGETHER.
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6	ISSUED FOR 50% COORDINATION	2020-10-06
7	REISSUED FOR SITE PLAN APPLICATION	2020-10-15
8	ISSUED FOR PERMIT	2020-11-06
9	ISSUED FOR COORDINATION	2020-11-26
10	ISSUED FOR COORDINATION	2021-01-29

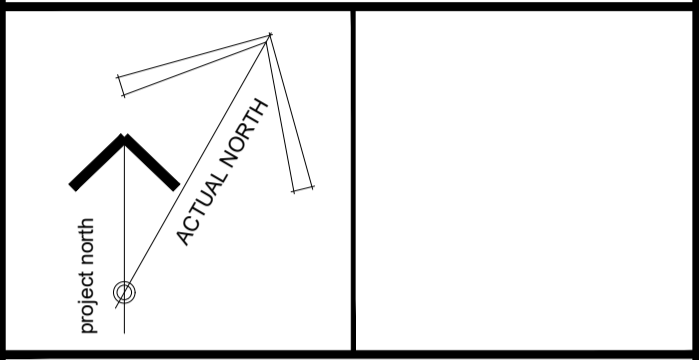

**CLIENT**

**LANDRIC HOMES**  
TEL: 819-593-4895  
1173 CYRVILLE RD, SUITE 202  
OTTAWA, ON, K1J 7S6

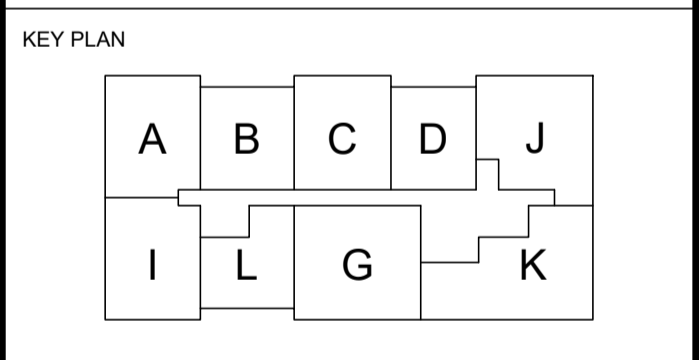201-1339 WELLINGTON ST. WEST OTTAWA ON K1Y 3B8  
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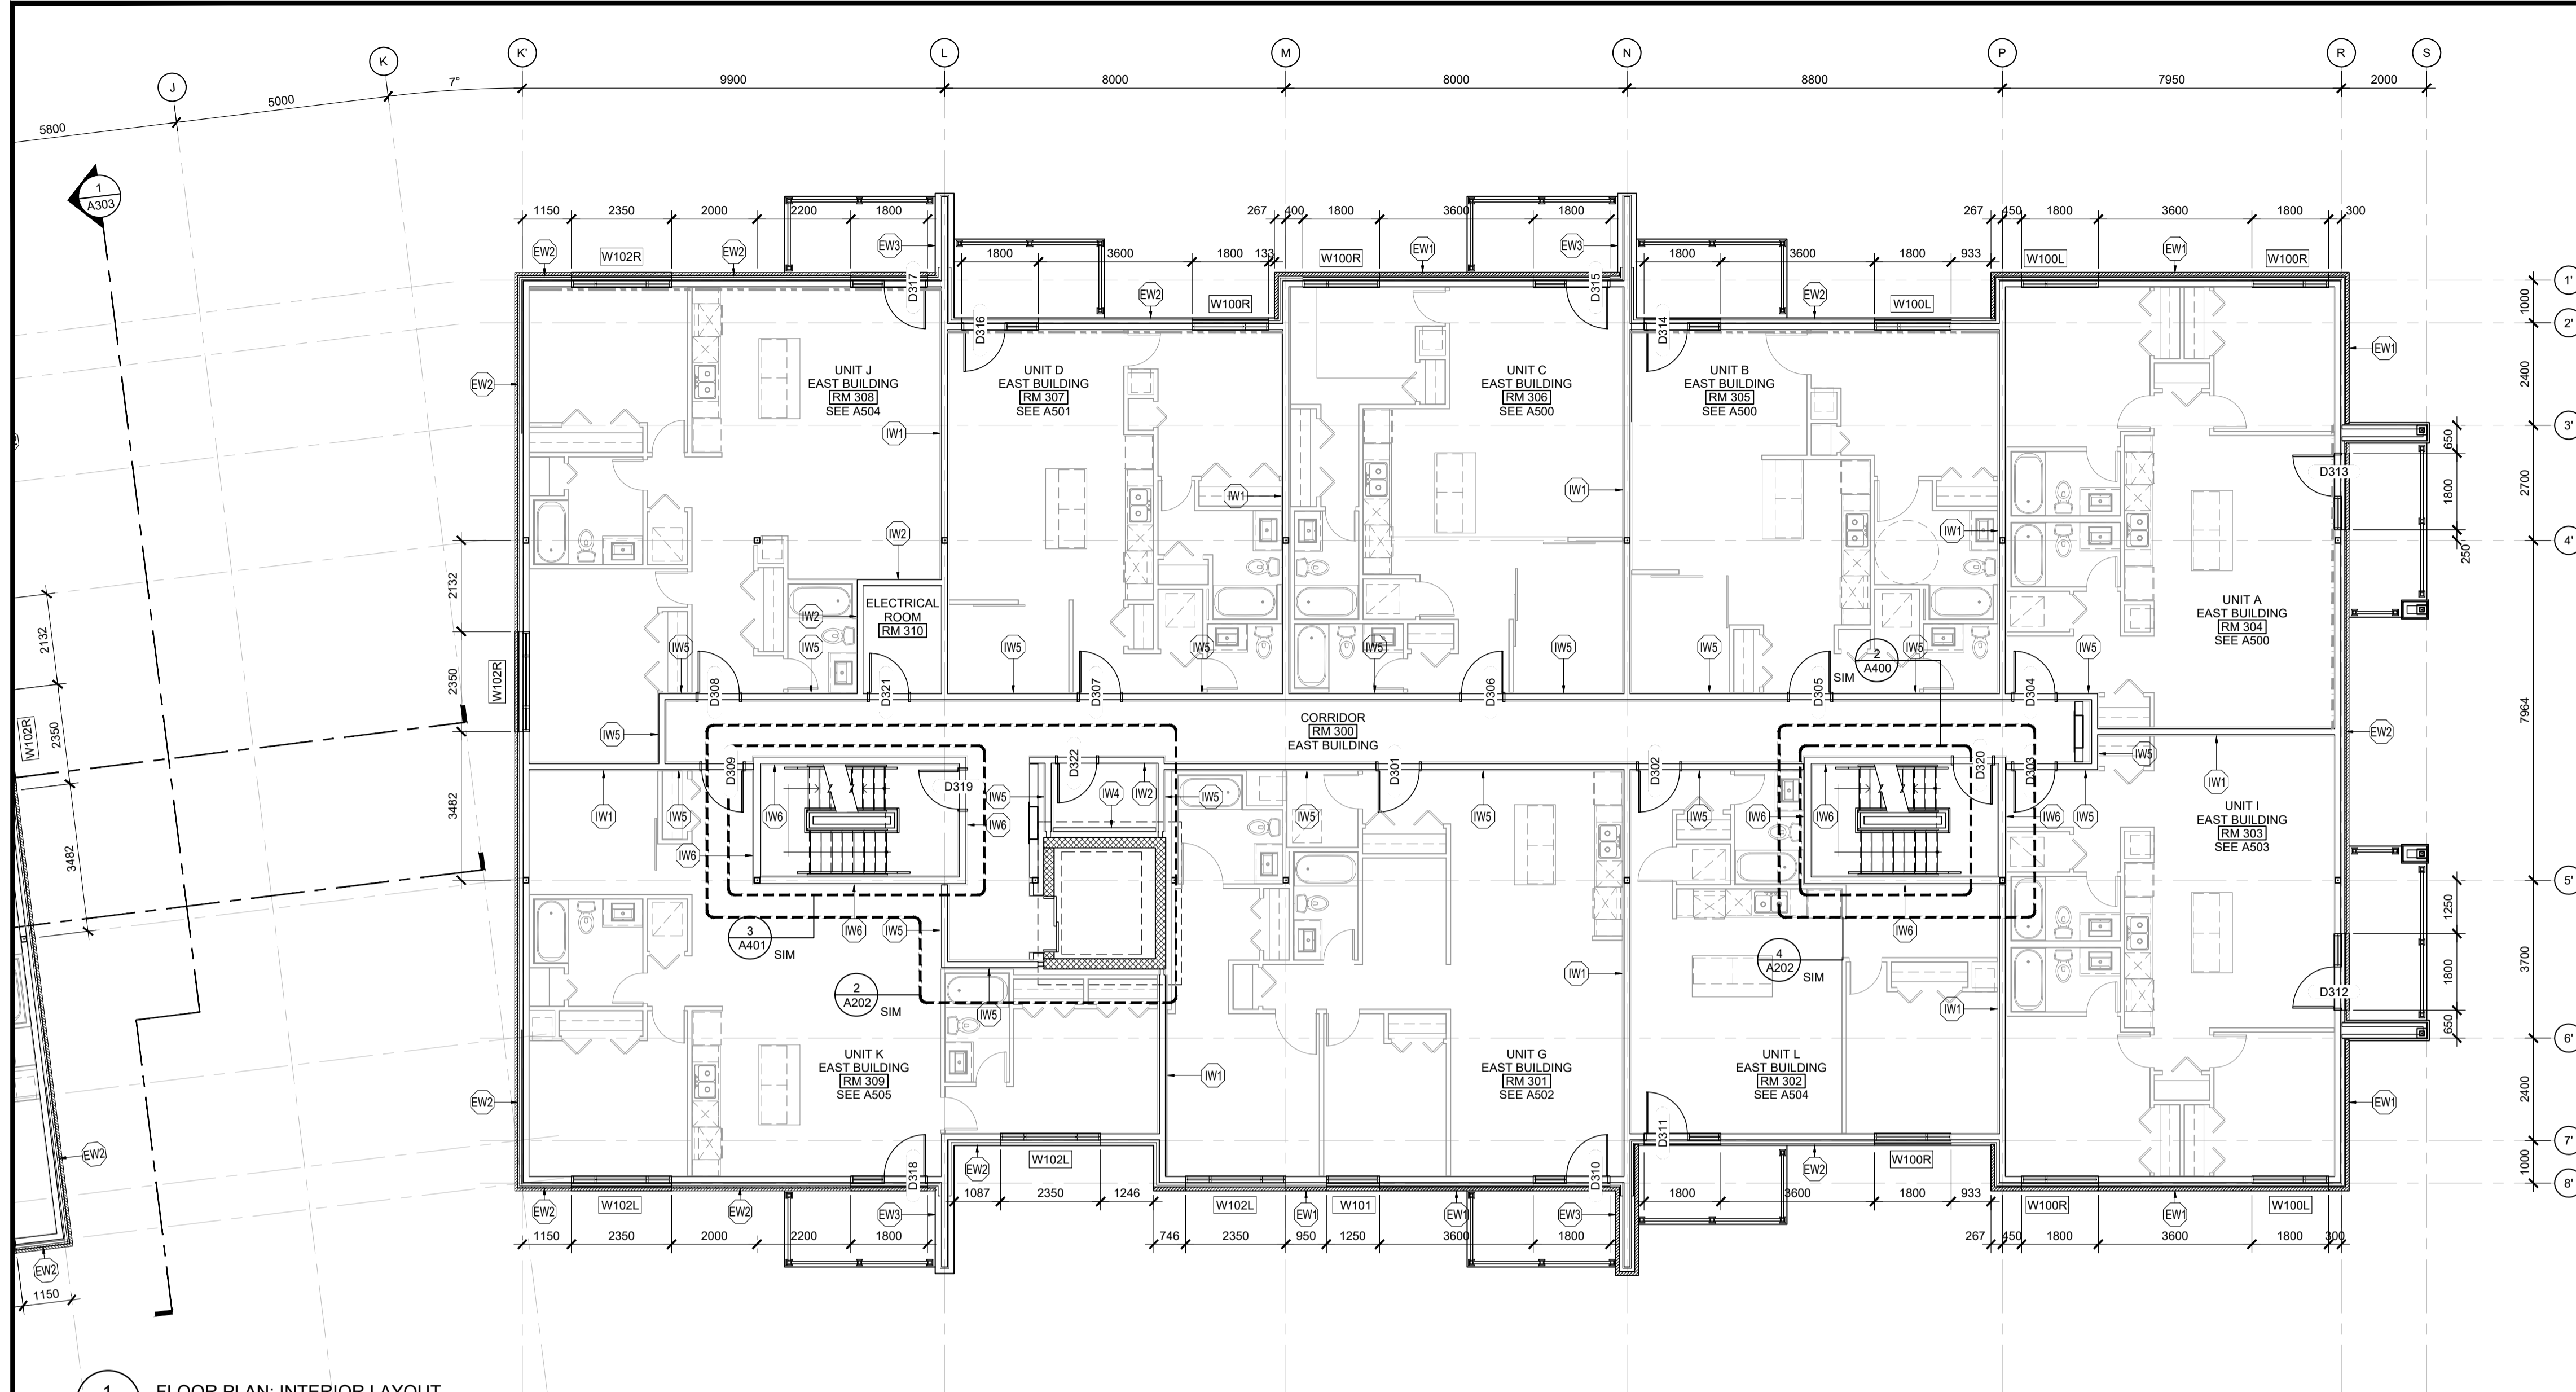
**PROJECT TITLE**  
HILLPARK APARTMENTS  
70 & 80 SILO STREET  
OTTAWA (ORLEANS), ON

**DRAWING TITLE**  
THIRD FLOOR REFLECTED CEILING  
PLAN: WEST BUILDING

DATE	DRAWN	JOB NO.	DRAWING NO.
OCT. 2019	IC   DR	3206	A256
SCALE AS NOTED	REVIEWED TO		

**ARCHITECTURAL**

D07-12-20-0104



1 FLOOR PLAN: INTERIOR LAYOUT  
SCALE: 1 : 100

**WALL ASSEMBLY FRR LEGEND:**

----- 1.5 HOUR FIRE RESISTANCE RATING, REFER TO ASSEMBLY SCHEDULE

----- 1 HOUR FIRE RESISTANCE RATING, REFER TO ASSEMBLY SCHEDULE

- WHERE OBC SB-2 IS REFERENCED TO ACHIEVE THE REQUIRED MINIMUM FRR, THE FOLLOWING COMPONENT RATINGS WERE USED VIA THE ADDITIVE METHOD:

2x13mm TYPE 'X' GYPSUM BOARD: 80 min (TABLE 2.3.4 A)  
 16mm TYPE 'X' GYPSUM BOARD: 40 min (TABLE 2.3.4 A)  
 13mm TYPE 'X' GYPSUM BOARD: 25 min (TABLE 2.3.4 A)  
 WOOD STUDS: 20 min (TABLE 2.3.4 E)  
 FULL DEPTH INSULATION: 15 min (TABLE 2.3.4 G)

**INTERIOR WALL ASSEMBLIES:**

(W1) PARTY WALL

- 2 LAYERS 13mm TYPE 'X' GYPSUM BOARD
- 13mm RESILIENT FURRING CHANNEL
- 38x140 WOOD STUD FRAMING @ 400mm o/c c/w FULL DEPTH INSULATION
- 2 LAYERS 16mm TYPE 'X' GYPSUM BOARD

1 HOUR FRR ACHIEVED THROUGH OBC SB-2, STC RATING: 53, OBC SB-3, W6c

\*NOTE: MAKE THE FOLLOWING SUBSTITUTION AT SHEAR-WALLS (REFER TO STRUCTURAL)

- 2 LAYERS STRUCTURAL SHEATHING
- 16mm TYPE 'X' GYPSUM BOARD

(W2) INTERIOR WALL: 1HR FRR

- 16mm TYPE 'X' GYPSUM BOARD
- 38x89 or 140 WOOD STUD FRAMING @ 400mm o/c c/w FULL DEPTH INSULATION
- 16mm TYPE 'X' GYPSUM BOARD

1 HOUR FRR ACHIEVED THROUGH OBC SB-2.

(W3) INTERIOR WALL

- 16mm GYPSUM BOARD
- 38x89 or 140 WOOD STUD FRAMING @ 400mm o/c
- 16mm GYPSUM BOARD

INTERIOR WALL, ONE-SIDED FINISH

- 16mm GYPSUM BOARD
- 38x89, 140 or 184 WOOD STUD FRAMING @ 400mm o/c

(W5) CORRIDOR WALL

- 2 LAYERS 16mm TYPE 'X' GYPSUM BOARD
- 13mm RESILIENT FURRING CHANNEL @ 600mm o/c
- 140mm WOOD STUDS (REFER TO STRUCTURAL) c/w FULL DEPTH INSULATION
- 2 LAYERS 16mm TYPE 'X' GYPSUM BOARD

1 HOUR FRR ACHIEVED THROUGH ULC U334  
STC RATING: 62

NOTE: 16mm TYPE 'X' GYPSUM BOARD PERMITTED TO BE SUBSTITUTED w/ 13mm TYPE 'X' GYPSUM BOARD UNDER OBC SB-2, c/w STC RATING: min 55, OBC SB-3, W6d

(W6) STAIR ENCLOSURE WALL

- 2 LAYERS 16mm TYPE 'X' GYPSUM BOARD
- 92mm or 152mm STEEL STUDS @ 400mm o/c, c/w FULL DEPTH MINERAL FIBRE INSULATION
- 2 LAYERS 16mm TYPE 'X' GYPSUM BOARD

1.5 HOUR FRR ACHIEVED THROUGH ULC W453  
STC RATING: 59, OBC SB-3, 59a

NOTE: 16mm TYPE 'X' GYPSUM BOARD PERMITTED TO BE SUBSTITUTED w/ 13mm TYPE 'X' GYPSUM BOARD UNDER OBC SB-2, c/w STC RATING: 57, OBC SB-3, 59b

(W7) SHAFT WALL

- 2 LAYERS 16mm TYPE 'X' GYPSUM BOARD
- 64mm C-H STUDS @ 600mm o/c c/w 25mm GYPSUM LINER PANEL

2 HOUR FRR ACHIEVED THROUGH ULC W446 SYSTEM F

**EXTERIOR WALL ASSEMBLY NOTES & LEGEND:**

----- 2x LAYER OF 13mm TYPE 'X' GYPSUM BOARD c/w 13mm RESILIENT FURRING CHANNELS @ 600mm o/c

----- 2x LAYER OF 13mm TYPE 'X' GYPSUM BOARD

1 HOUR FRR ACHIEVED THROUGH OBC SB-2.

**EXTERIOR WALL ASSEMBLIES:**

(EW1) EXTERIOR WALL (MASONRY)

- 90mm MASONRY VENEER (REFER TO ELEVATIONS AND SPECIFICATIONS FOR TYPE)
- 25mm - 41mm AIR SPACE (SEE ASSEMBLY LEGEND)
- 50mm RIGID INSULATION (Rsi 1.8 / R10c)
- AIR BARRIER
- SHEATHING (REFER TO ELEVATIONS + STRUCTURAL FOR SHEAR-WALL LOCATIONS & REQUIREMENTS)
- 38x140 WOOD STUDS (REFER TO STRUCTURAL) c/w FULL DEPTH INSULATION (Rsi 3.5 / R20)
- VAPOUR BARRIER
- 16mm TYPE 'X' GYPSUM BOARD

(EW2) EXTERIOR WALL (METAL SIDING)

- METAL SIDING
- 75mm Z-BARS (ORIENTED PERPENDICULAR TO SIDING) @ 600mm o/c c/w 50mm RIGID INSULATION (Rsi 1.8 / R10c)
- AIR BARRIER
- SHEATHING (REFER TO ELEVATIONS + STRUCTURAL FOR SHEAR-WALL LOCATIONS & REQUIREMENTS)
- 38x140 WOOD STUDS (REFER TO STRUCTURAL) c/w FULL DEPTH INSULATION (Rsi 3.5 / R20)
- VAPOUR BARRIER
- 13mm RESILIENT FURRING CHANNEL @ 600mm o/c (WHERE INDICATED ON FLOOR PLANS)
- 13mm TYPE 'X' GYPSUM BOARD (2x LAYER WHERE INDICATED ON FLOOR PLANS)

(EW3) BALCONY WING WALL

- CLADDING\*
- AIR BARRIER
- SHEATHING (REFER TO STRUCTURAL FOR SHEAR-WALL LOCATIONS & REQUIREMENTS)
- 38x140 WOOD STUDS (REFER TO STRUCTURAL) c/w FULL DEPTH INSULATION
- 2x16mm ORIENTED STRAND BOARD SHEATHING
- AIR BARRIER
- CLADDING\*

\*NOTE: CLADDING TO BE THE ONE OF THE FOLLOWING (REFER TO PLANS AND ELEVATIONS FOR LOCATIONS):

- 90mm MASONRY VENEER (REFER TO ELEVATIONS AND SPECIFICATIONS FOR TYPE)
- 25mm AIR SPACE
- ALUMINUM COMPOSITE PANEL
- 19x64 VERTICAL FURRING @ 600mm o/c & TO SUIT PANEL MOUNTING REQUIREMENTS
- 75mm Z-BARS @ 600mm o/c

(EW4) EXTERIOR WALL (PODIUM, NORTH)


- VERTICAL METAL SIDING
- 135mm HORIZONTAL Z-BARS @ 600mm o/c c/w 100mm RIGID INSULATION (Rsi 3.6 / R20c)
- AIR / VAPOUR BARRIER
- 16mm EXTERIOR GRADE GYPSUM BOARD SHEATHING
- 38x184 WOOD STUDS @ 400mm o/c
- 16mm TYPE 'X' GYPSUM BOARD

**GENERAL NOTES**

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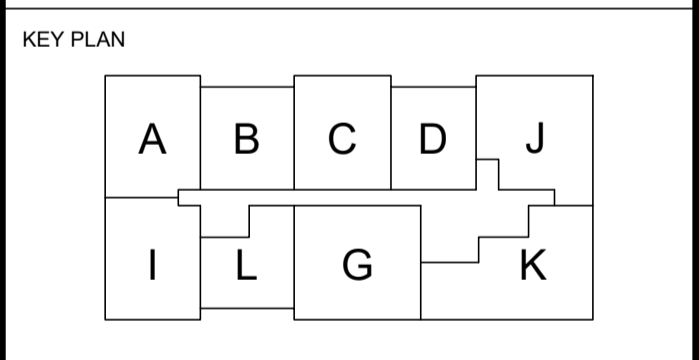
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6	ISSUED FOR 50% COORDINATION	2020-10-06
7	REISSUED FOR SITE PLAN APPLICATION	2020-10-15
8	ISSUED FOR PERMIT	2020-11-06
9	ISSUED FOR COORDINATION	2020-11-26
10	ISSUED FOR COORDINATION	2021-01-29



**CLIENT**

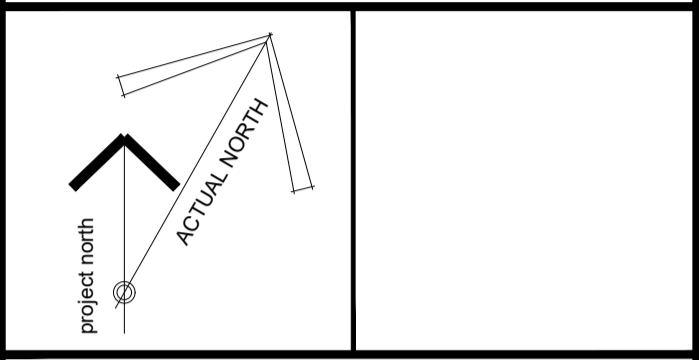**LANDRIC HOMES**  
 TEL: 819-593-8895  
 1173 CYRVILLE RD, SUITE 202  
 OTTAWA, ON, K1J 7S6



**PROJECT TITLE**


**HILLPARK APARTMENTS**  
 70 & 80 SILO STREET  
 OTTAWA (ORLEANS), ON

**DRAWING TITLE**

**THIRD FLOOR PLAN:  
EAST BUILDING**

DATE	DRAWN	JOB NO.	DRAWING NO.
OCT. 2019	IC   DR	3206	A207
SCALE AS NOTED	REVIEWED TO		

**ARCHITECTURAL**

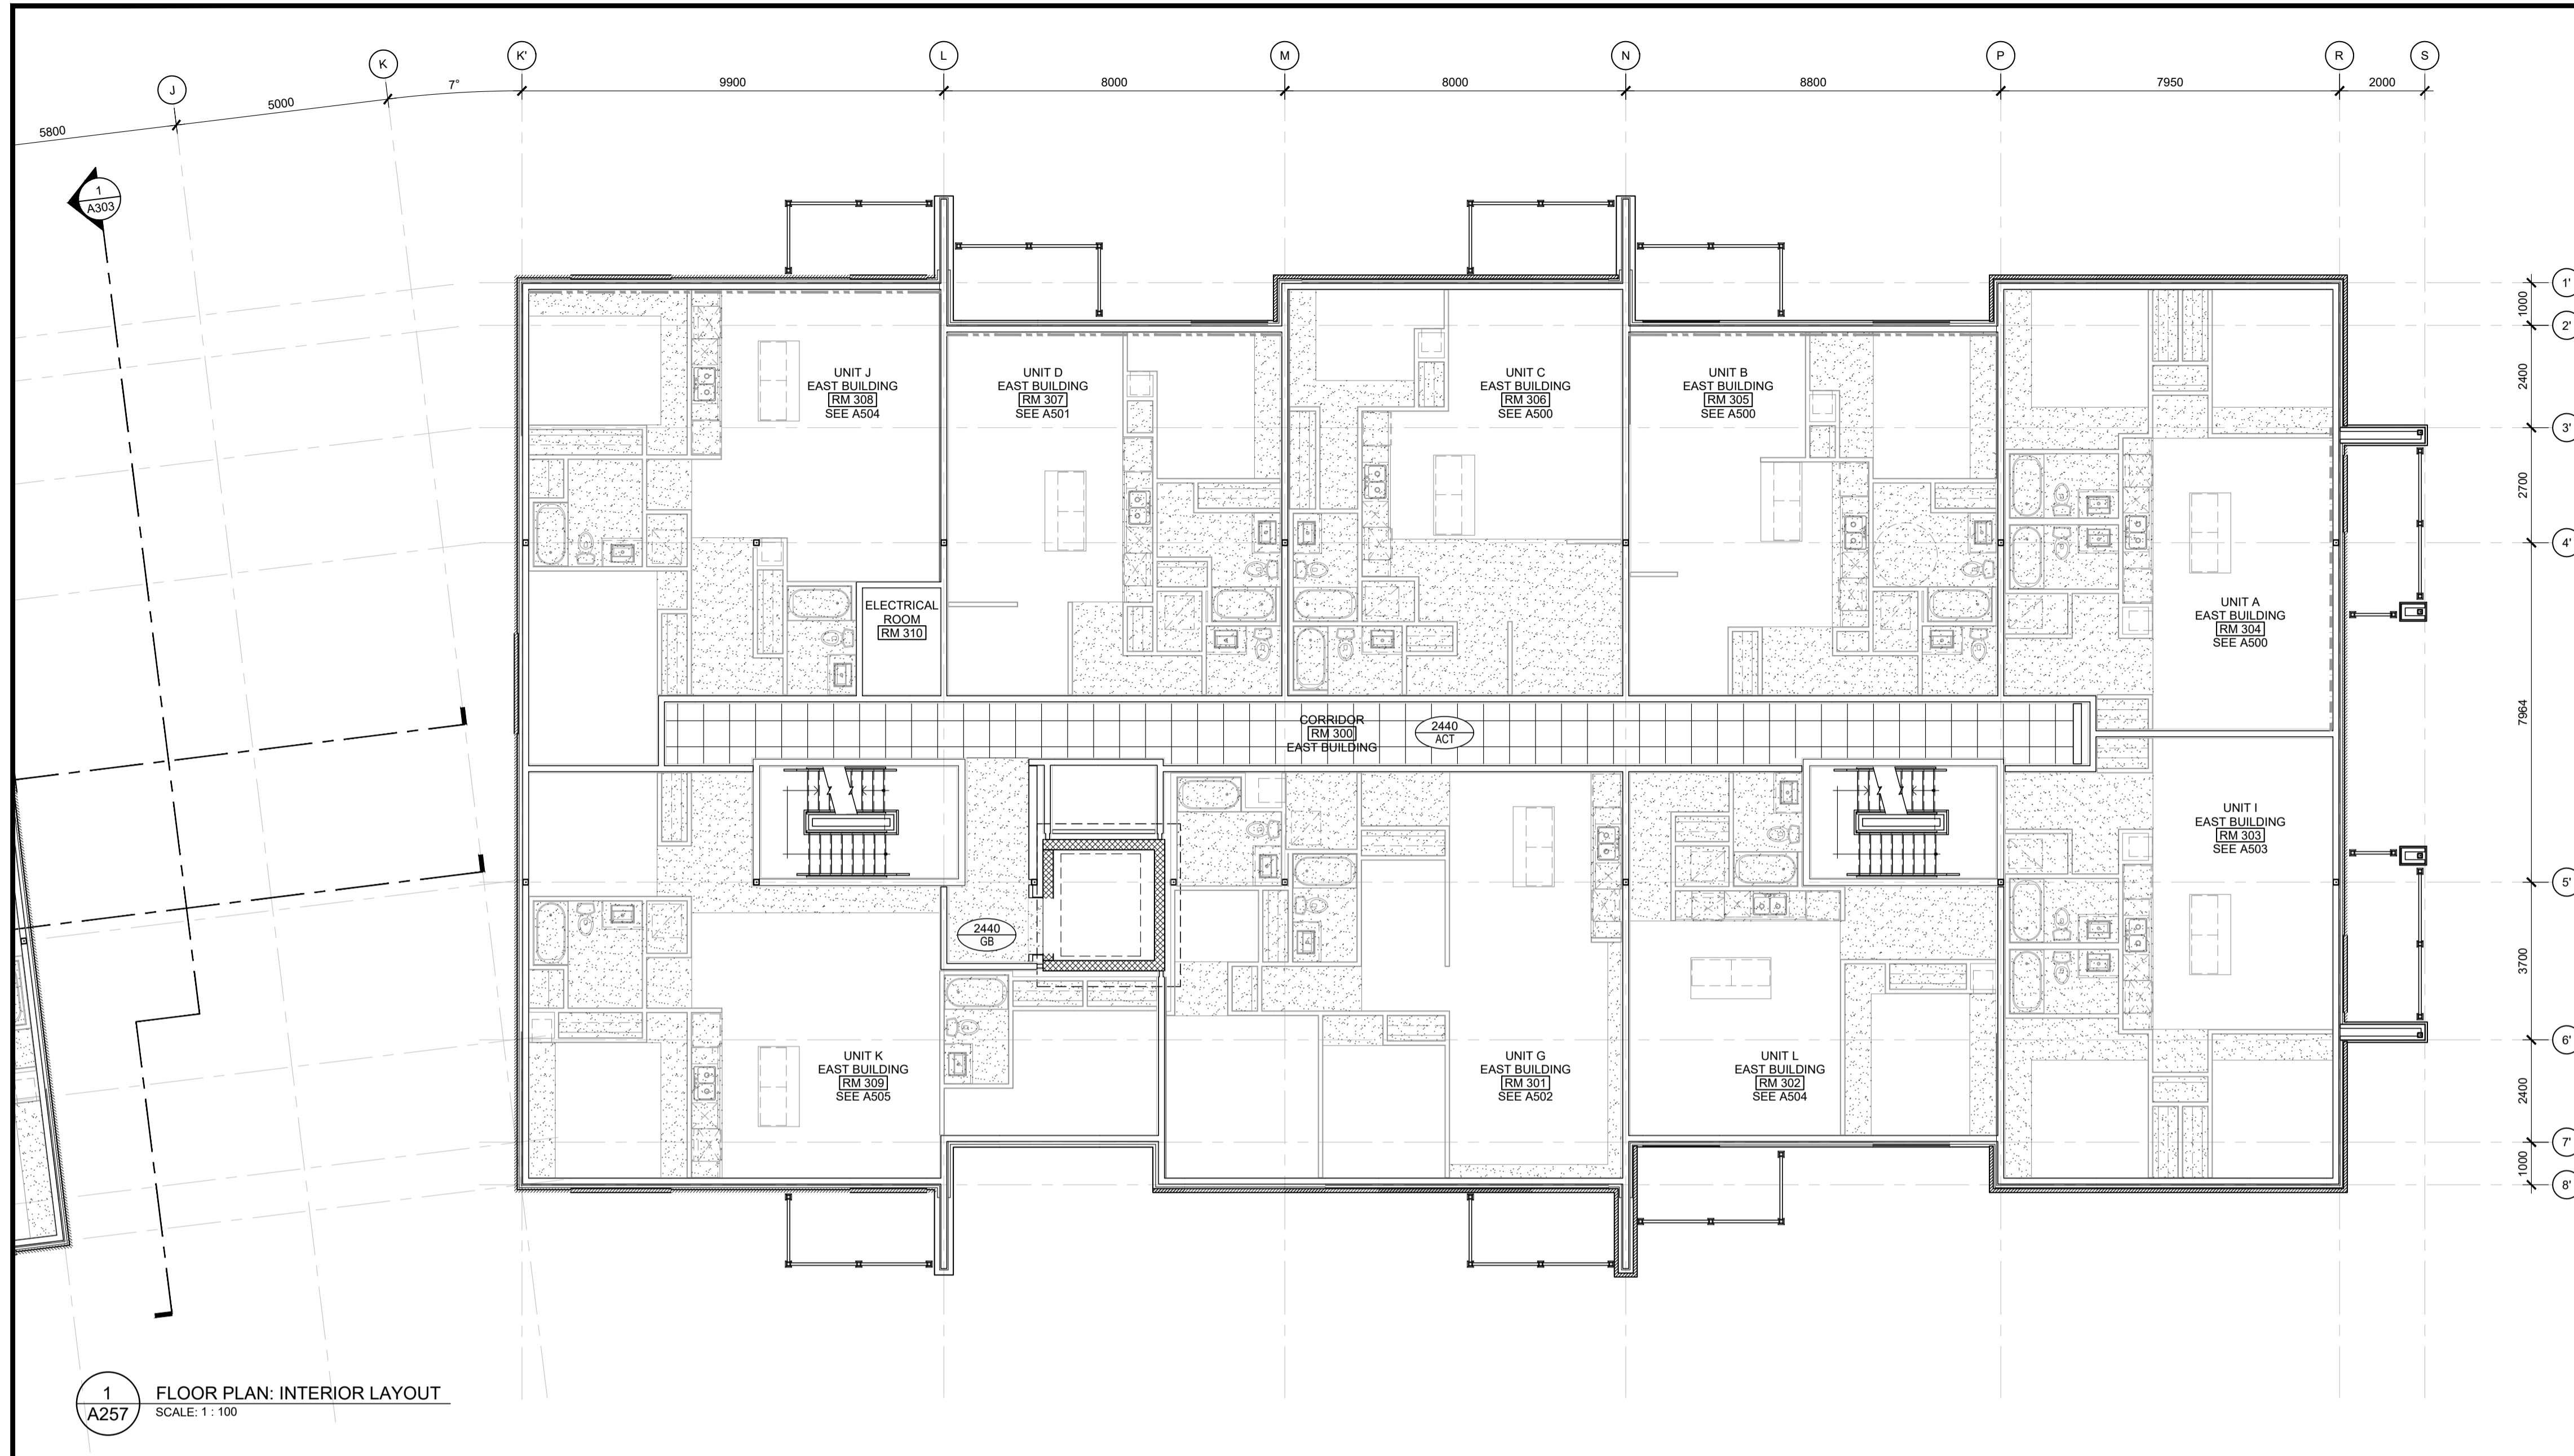

1 FLOOR PLAN: INTERIOR LAYOUT  
SCALE: 1 : 100

UNIT FLOOR PLAN NOTES & LEGEND:

1. SWING DOORS TO BE FRAMED 75mm FROM CORNER, UNLESS NOTED OTHERWISE.
2. FOLDING DOORS TO BE CENTERED IN CLOSET / OPENING, UNLESS NOTED OTHERWISE.
3. LINEN CLOSETS TO INCLUDE 5x SHELVES.
4. CLOSETS TO INCLUDE 1x SHELF, 1x HANGING ROD.


UNIT REFLECTED CEILING PLAN NOTES & LEGEND:

1. TYPICAL CEILINGS TO BE u/s OF FLOOR / ROOF ASSEMBLY ABOVE, UNLESS NOTED OTHERWISE.
- BULKHEAD TO CONCEAL MECHANICAL ROUTING TO BE CONSTRUCTED OF 38x64 WOOD STUDS @ 600mm o/c c/w 13mm GYPSUM AT 2440mm ABOVE FLOOR, UNLESS NOTED OTHERWISE.
  - FINISHED CEILING HEIGHT
  - FINISHED CEILING MATERIAL
  - 610mm x 610mm ACOUSTIC CEILING TILE

GENERAL NOTES


1. DO NOT SCALE DRAWINGS; ONLY FIGURED DIMENSIONS ARE TO BE USED. WHERE DOUBT EXISTS, FILE REQUEST FOR INTERPRETATION AND REQUEST CLARITY.
2. IT IS THE RESPONSIBILITY OF THE GENERAL CONTRACTOR TO VERIFY DIMENSIONS ON SITE; REPORT DISCREPANCIES TO THE ARCHITECT PROMPTLY.
3. GENERAL CONTRACTOR TO TAKE INTO ACCOUNT CONSTRUCTION TOLERANCE; GENERAL CONTRACTOR TO COORDINATE THE WORK OF DIFFERENT TRADES TO COMPLY WITH DESIGN INTENT.
4. ALL WORK DESCRIBED IN THESE DRAWINGS AND SPECIFICATIONS ARE TO COMPLY WITH THE CURRENT EDITION OF THE ONTARIO BUILDING CODE (2012) OR NATIONAL BUILDING CODE (2010) INCLUDING MOST RECENT AMENDMENTS.
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ISSUE RECORD:

NO.	DESCRIPTION	DATE
1	ISSUED FOR PRECONSULTATION	2020-02-07
2	ISSUED FOR CLIENT REVIEW	2020-03-17
3	ISSUED FOR CONSULTANT COORD.	2020-03-30
4	ISSUED FOR COORDINATION	2020-06-12
5	ISSUED FOR SITE PLAN APPLICATION	2020-06-29
6	ISSUED FOR 50% COORDINATION	2020-10-06
7	REISSUED FOR SITE PLAN APPLICATION	2020-10-15
8	ISSUED FOR PERMIT	2020-11-06
9	ISSUED FOR COORDINATION	2020-11-26
10	ISSUED FOR COORDINATION	2021-01-29

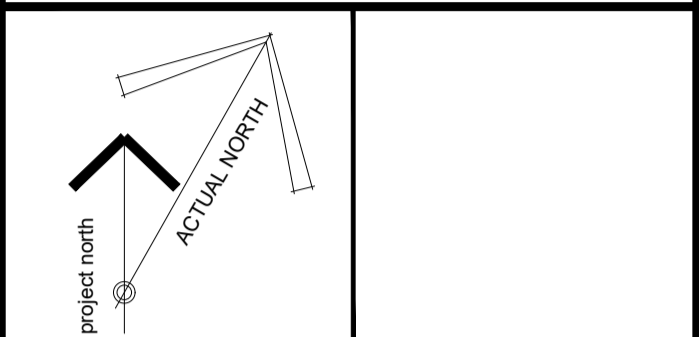

**CLIENT**  
**LANDRIC HOMES**  
TEL: 819-593-4895  
1173 CYRVILLE RD, SUITE 202  
OTTAWA, ON, K1J 7S6

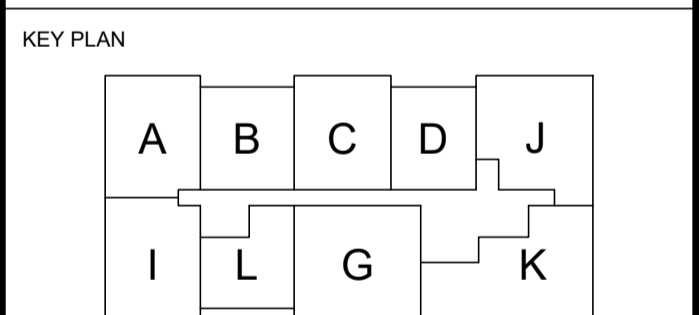

**PROJECT TITLE**  
**HILLPARK APARTMENTS**  
70 & 80 SILO STREET  
OTTAWA (ORLEANS), ON

**DRAWING TITLE**  
**THIRD FLOOR REFLECTED CEILING PLAN: EAST BUILDING**

DATE	DRAWN	JOB NO.	DRAWING NO.
OCT. 2019	IC   DR	3206	A257
SCALE	REVIEWED		
AS NOTED	TO		

**ARCHITECTURAL**

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