



SAN STRUCTURE TABLE				
NAME	RIM ELEV.	INVERT IN	INVERT OUT	DESCRIPTION
MH2A	75.79	S673.520	N73.278	STRUC. OPSD 701.011 COVER CITY 524 FRAME CITY 525
MH2B	75.25	S73.111	N71.194	STRUC. OPSD 701.011 COVER CITY 524 FRAME CITY 525 CW EXTERNAL DITCH STRUCTURE PER OPSD 1003.010
MH2C	71.16	S68.710	N68.650	STRUC. OPSD 701.011 COVER CITY 524 FRAME CITY 525
MH2D	70.11	S67.200	N66.440	STRUC. OPSD 701.011 COVER CITY 524 FRAME CITY 525 CW EXTERNAL DITCH STRUCTURE PER OPSD 1003.010
MH2E	69.45	N65.500	N65.000	STRUC. OPSD 701.011 COVER CITY 524 FRAME CITY 525

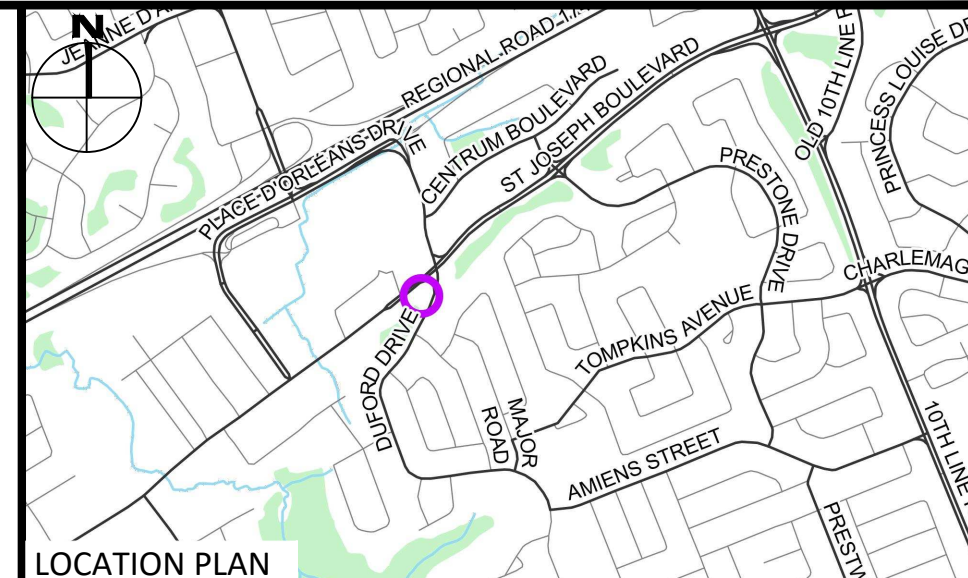


LEGEND	
DC	BARRIER CURB & CURB DEPRESSION
PC	PROPOSED CONCRETE PAVERS
CB	STORM MANHOLE
CB	CATCH-BASIN, CURB INLET OR DITCH INLET
MH2A	SANITARY MANHOLE
PL	PROPERTY LINE
WV	EX. WATER VALVE/CHAMBER
WV	PROP. VALVE PER CITY W24
FD	FIRE HYDRANT
W	PROPOSED WALL
SC	PROPOSED SIAMASE CONNECTION
WM	PROPOSED WATER METER AND REMOTE METER
PC	PROPOSED CONCRETE SIDEWALK
PR	PROP AND EX. REDUCER
P	U/G HYDRO DUCT PER ELEC.
ST	EX. STM SEWER
SAN	EX. SAN SEWER
95.94	SLOPING AT 3:1 UNLESS SPECIFIED
93.20	PROPOSED ELEVATION
95.94	EXISTING ELEVATION
X/W100.50	SWALE ELEVATION
X/W90.50	TOP/BOTTOM WALL FACE ELEVATIONS
→	PROPOSED EMERGENCY OVERLAND FLOW ROUTE
→	PRE AND POST-DEVELOPMENT DRAINAGE DIRECTIONS
~	HEAVY DUTY SILT FENCE BARRIER PER OPSD 219.130
□	BUILDING ENTRANCE
■	PROPOSED GRASS
---	CENTRELINE OF SWALE
▨	PROPOSED ROADCUT AND REINSTATEMENT PER CITY R10
⊗	CB SILT SACK PER C101 DETAIL
⊙	SERVICE/SEWER CROSSING
L	EX. UG STREET LIGHT
TF	EX. TRAFFIC LINE
W	EX. WATERMAIN
GAS	EX. GAS
OHW	EX. OHW
BELL	EX. BELL
ROG	EX. ROGERS

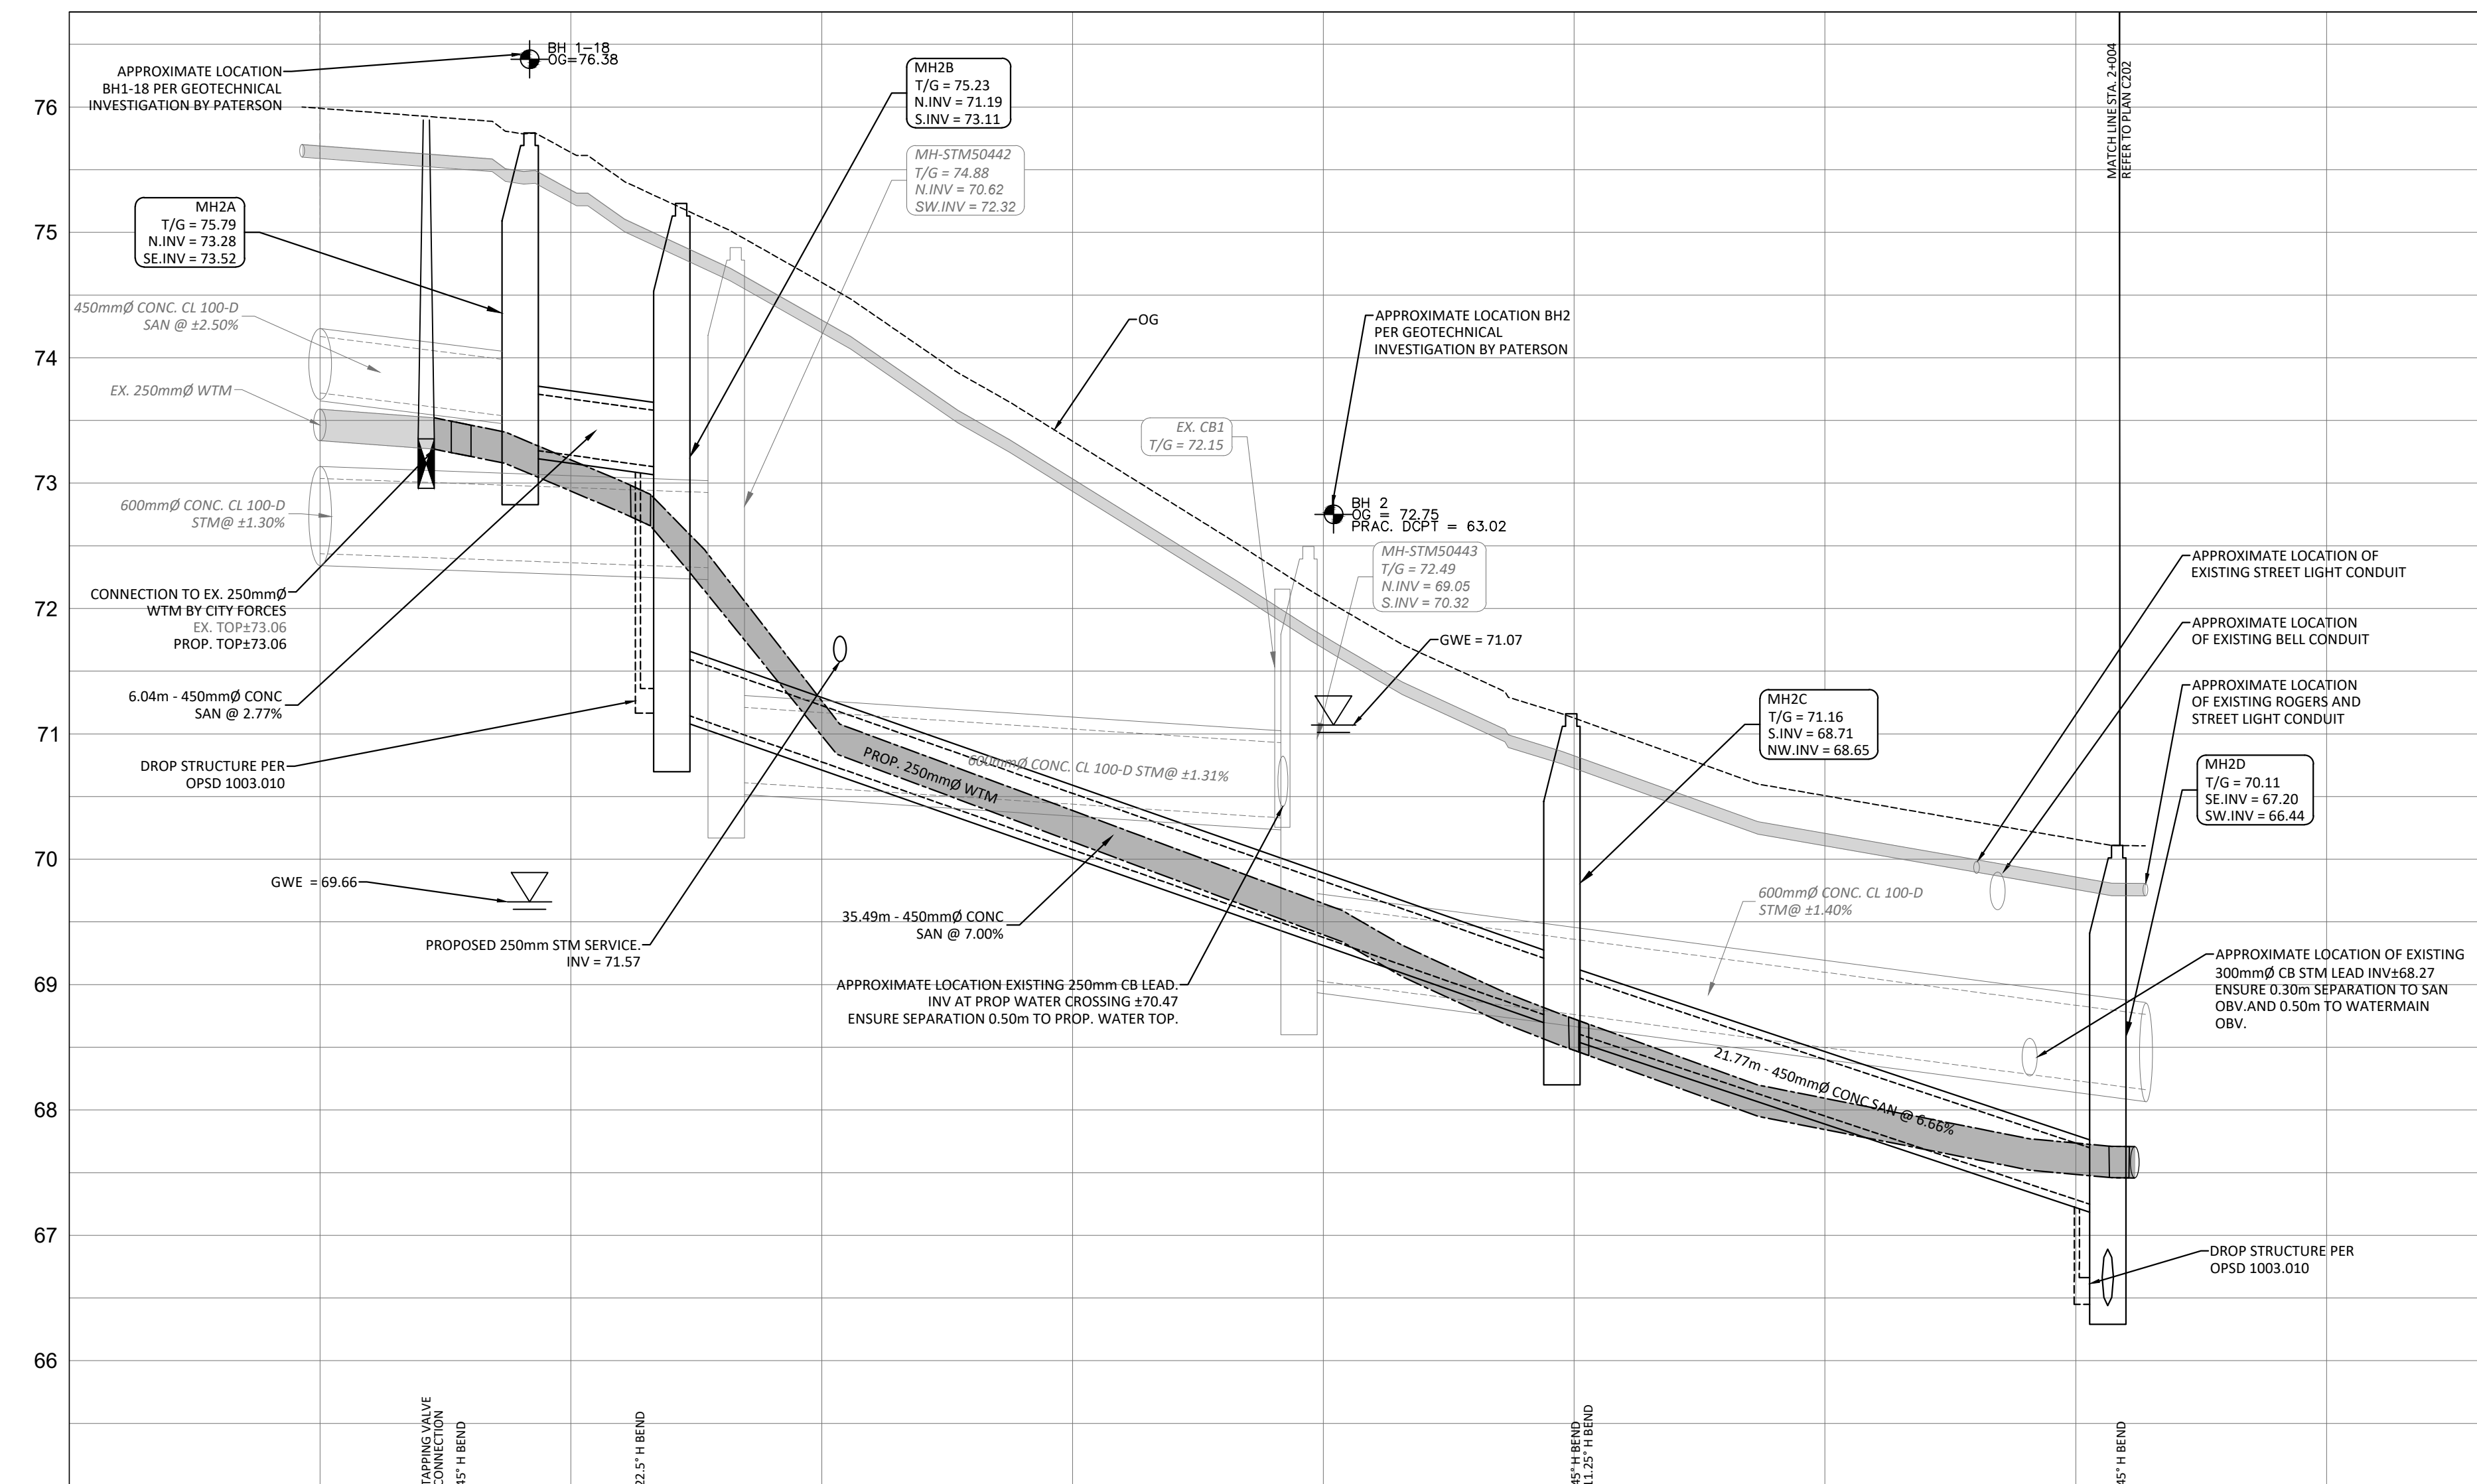

ELEVATIONS PROPOSED		NOTE: CONTRACTOR IS TO PREPARE A SEWER FLOW MANAGEMENT PLAN TO THE SATISFACTION OF THE CITY PRIOR TO CONSTRUCTION.														
TOP OF WATERMAIN	SANITARY SEWER	STATION	1+000	1+004	1+006	1+013	1+020	1+021	1+038	1+040	1+050	1+050	1+060	1+062	1+072	1+080
73.53	73.86	1+000	73.53	73.48	73.38	72.95	71.05	69.75	68.71	68.70	67.71	67.71	67.20	67.20	67.71	67.71
73.48	73.86	1+004	73.53	73.48	73.38	72.95	71.05	69.75	68.71	68.70	67.71	67.71	67.20	67.20	67.71	67.71
73.48	73.86	1+006	73.53	73.48	73.38	72.95	71.05	69.75	68.71	68.70	67.71	67.71	67.20	67.20	67.71	67.71
73.38	73.86	1+013	73.53	73.48	73.38	72.95	71.05	69.75	68.71	68.70	67.71	67.71	67.20	67.20	67.71	67.71
71.05	73.86	1+020	73.53	73.48	73.38	72.95	71.05	69.75	68.71	68.70	67.71	67.71	67.20	67.20	67.71	67.71
71.05	73.86	1+021	73.53	73.48	73.38	72.95	71.05	69.75	68.71	68.70	67.71	67.71	67.20	67.20	67.71	67.71
69.75	73.86	1+038	73.53	73.48	73.38	72.95	71.05	69.75	68.71	68.70	67.71	67.71	67.20	67.20	67.71	67.71
69.75	73.86	1+040	73.53	73.48	73.38	72.95	71.05	69.75	68.71	68.70	67.71	67.71	67.20	67.20	67.71	67.71
68.71	73.86	1+050	73.53	73.48	73.38	72.95	71.05	69.75	68.71	68.70	67.71	67.71	67.20	67.20	67.71	67.71
68.71	73.86	1+050	73.53	73.48	73.38	72.95	71.05	69.75	68.71	68.70	67.71	67.71	67.20	67.20	67.71	67.71
67.71	73.86	1+060	73.53	73.48	73.38	72.95	71.05	69.75	68.71	68.70	67.71	67.71	67.20	67.20	67.71	67.71
67.71	73.86	1+062	73.53	73.48	73.38	72.95	71.05	69.75	68.71	68.70	67.71	67.71	67.20	67.20	67.71	67.71
67.20	73.86	1+072	73.53	73.48	73.38	72.95	71.05	69.75	68.71	68.70	67.71	67.71	67.20	67.20	67.71	67.71
67.20	73.86	1+080	73.53	73.48	73.38	72.95	71.05	69.75	68.71	68.70	67.71	67.71	67.20	67.20	67.71	67.71

SUBJECT TO APPROVAL		
2	ISSUED FOR REVIEW	JUL 31, 2024
1	ISSUED FOR SITE PLAN CONTROL	MAR 07, 2024
No.	Revisions	Date
Check and verify all dimensions before proceeding with the work. Do not scale drawings.		

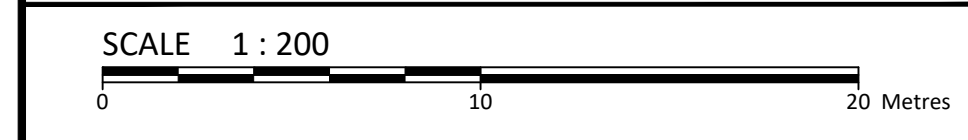

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www.egis-group.com

C. A. MACLEOD
LICENSED PROFESSIONAL ENGINEER
100159100
JULY 31/2024
PROVINCE OF ONTARIO

Client: **THEBERGE DEVELOPMENTS LTD**
1600 LAPERRIERE AVE
OTTAWA, ON K1Z 8P5

Project: **3030 ST. JOSEPH BOULEVARD**
OTTAWA ON

Drawing Title: **PLAN & PROFILE STA. 1+000 TO 1+063**

Scale: 1:200	Project Number: CCO-24-0142
Drawn By: RRR	Checked By: AM
Designed By: RRR	Drawing Number: C201

FILENAME: I:\Information\2024\CCO-24-0142\Theberge - 2024\9 Joseph Blvd\12 - Drawing\CCO-24-0142 - PRESENTATION.dwg
 LAST SAVED: Wednesday, July 31, 2024, 10:51:51 AM
 LAST SAVER: J. Macleod
 LAST PLOTTED: Wednesday, July 31, 2024, 10:51:51 AM
 PLOT DEVICE: HP-CVT1000MHD.ctb

D07-12-23-0090