

DRAWING INDEX

# DEVELOPMENT PERMIT DRAWING INDEX

SHEET NO. SHEET NAME

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- A.2 BLOCK PLAN & STREETSCAPE
- A.3 LOWER & MAIN FLOOR PLAN
- A.4 FRONT & RIGHT ELEVATION
- A.5 REAR & LEFT ELEVATION
- A.6 DRIVEWAY SECTION



## 3420 LANE CRESCENT SW

ZOOLOGICAL CONSTRUCTION



403-984-1513

BUILDER

PROJECT NAME  
**3420 LANE CRESCENT SW**

PROJECT INFO  
ADDRESS  
**3420 LANE CRESCENT SW CALGARY, AB**

ADDRESS LEGAL  
**LOT 126 PLAN 895JK BLOCK 6**

COMPANY  
**LAKEVIEW**

ZONING  
**R-CG**

AREAS	
MAIN FLOOR AREA	1860 SF
ABOVE GRADE DEVELOPED TOTAL	1860 SF
LOWER FLOOR AREA	1572 SF
BELOW GRADE DEVELOPED TOTAL	1572 SF
GARAGE	487 SF
GARAGE TOTAL	487 SF
MECHANICAL	111 SF
UNDEVELOPED TOTAL	111 SF
UNCOVERED DECK	272 SF
UNCOVERED FRONT PORCH	68 SF
DECKS & PATIOS UNCOVERED TOTAL	340 SF

### REVISIONS

NO	DATE	DESCRIPTION
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### GENERAL NOTES AND LIMITATIONS OF LIABILITY

**STANDARD OF CARE**  
PROFESSIONAL SERVICES HAVE BEEN PROVIDED CONSISTENT WITH THE STANDARD OF CARE ORDINARILY EXERCISED BY DESIGN PROFESSIONALS PRACTICING IN THE SAME LOCALITY UNDER SIMILAR CIRCUMSTANCES. NO OTHER WARRANTY OR GUARANTEE, EXPRESS OR IMPLIED, IS PROVIDED.  
DESIGN INTENT DOES NOT CONSTITUTE A GUARANTEE OF PERFORMANCE OUTCOMES INCLUDING BUT NOT LIMITED TO ENERGY EFFICIENCY, THERMAL COMFORT, ACOUSTIC PERFORMANCE, OR AESTHETIC UNIFORMITY.

**CONSTRUCTION MEANS, METHODS, AND COORDINATION**  
THE DESIGN PROFESSIONAL IS NOT RESPONSIBLE FOR CONSTRUCTION MEANS, METHODS, TECHNIQUES, SEQUENCING, PROCEDURES, TEMPORARY WORKS, OR SAFETY PRECAUTIONS, NOR FOR THE BUILDER/CONTRACTOR'S FAILURE TO PERFORM THE WORK IN ACCORDANCE WITH THE CONTRACT DOCUMENTS.  
TEMPORARY WORKS INCLUDING TEMPORARY BRACING, SHORING, EXCAVATION SUPPORT, HOARDING, SCAFFOLDING, WEATHER PROTECTION, AND SITE SAFETY ARE THE SOLE RESPONSIBILITY OF THE BUILDER/CONTRACTOR.  
THE BUILDER/CONTRACTOR IS RESPONSIBLE FOR COORDINATION BETWEEN TRADES AND FOR RESOLVING CONFLICTS ARISING FROM CONSTRUCTION SEQUENCING, INSTALLATION TOLERANCES, OR TRADE COORDINATION.  
THE DESIGN PROFESSIONAL IS NOT RESPONSIBLE FOR CONSTRUCTION SCHEDULES, SEQUENCING, PROCUREMENT, COST ESTIMATING, COST CONTROL, OR DELAYS.

**RESPONSIBILITY FOR CODE COMPLIANCE**  
THE CLIENT IS RESPONSIBLE FOR RETAINING QUALIFIED BUILDERS, CONTRACTORS, AND TRADES WHO ARE KNOWLEDGEABLE OF AND COMPLY WITH ALL APPLICABLE NATIONAL, PROVINCIAL, AND LOCAL CODES, STANDARDS, ZONING REQUIREMENTS, LEGISLATION, AND REGULATIONS.  
BUILDERS/CONTRACTORS AND TRADES ARE RESPONSIBLE FOR ENSURING THAT ALL WORK COMPLIES WITH CURRENT CODES, INDUSTRY STANDARDS, MANUFACTURERS' REQUIREMENTS, AND REGULATORY AUTHORITIES HAVING JURISDICTION, AND FOR COORDINATING SUCH WORK WITH ALL APPLICABLE CONSULTANT AND ENGINEERING DOCUMENTS.  
INTERPRETATION AND ACCEPTANCE OF CODES AND REGULATIONS BY AUTHORITIES HAVING JURISDICTION MAY VARY AND ARE BEYOND THE CONTROL OF THE DESIGN PROFESSIONAL.  
THE BUILDER/CONTRACTOR IS RESPONSIBLE FOR ARRANGING AND ENSURING THAT ALL REQUIRED INSPECTIONS ARE SCHEDULED AND COMPLETED TO GOOD STANDARDS IN ACCORDANCE WITH LOCAL REGULATIONS.  
THE BUILDER/CONTRACTOR IS RESPONSIBLE FOR ARRANGING AND COORDINATING ALL REQUIRED TESTING, FIELD REVIEWS BY ENGINEERS OF RECORD, THIRD PARTY INSPECTIONS, AND MUNICIPAL INSPECTIONS AND FOR PROVIDING ALL RESULTING REPORTS AND CERTIFICATES TO THE CLIENT AND DESIGN PROFESSIONAL UPON REQUEST.

**SITE VISITS AND FIELD REVIEWS**  
SITE VISITS OR FIELD REVIEWS ARE CONDUCTED FOR THE PURPOSE OF OBSERVING THE GENERAL PROGRESS OF THE WORK, AND DO NOT CONSTITUTE SUPERVISION, INSPECTION, OR QUALITY CONTROL. THE DESIGN PROFESSIONAL DOES NOT ASSUME RESPONSIBILITY FOR CONSTRUCTION COMPLIANCE, WORKMANSHIP, OR SAFETY.

**DRAWINGS, DIMENSIONS, AND EXISTING CONDITIONS**  
DRAWINGS ARE NOT TO BE SCALED. WRITTEN AND APPROVED SPECIFICATIONS GOVERN IN THE EVENT OF DISCREPANCIES.  
BUILDER/CONTRACTOR SHALL VERIFY ALL DIMENSIONS, SITE CONDITIONS, AND EXISTING CONDITIONS PRIOR TO CONSTRUCTION. THE DESIGN PROFESSIONAL IS NOT RESPONSIBLE FOR ERRORS OR OMISSIONS RESULTING FROM FAILURE TO VERIFY SUCH CONDITIONS.  
WHERE SITE MEASUREMENTS, SURVEYS, OR EXISTING CONDITION INFORMATION ARE PREPARED BY THIRD PARTIES, THE DESIGN PROFESSIONAL IS ENTITLED TO RELY ON THE ACCURACY AND COMPLETENESS OF SUCH INFORMATION AND IS NOT RESPONSIBLE FOR ERRORS, OMISSIONS, OR DISCREPANCIES ARISING FROM INFORMATION PREPARED BY OTHERS.

**DRAWINGS, DIMENSIONS, AND EXISTING CONDITIONS CONT...**  
IN RENOVATION AND ALTERATION PROJECTS, DRAWINGS ARE BASED ON VISIBLE AND REASONABLY ACCESSIBLE CONDITIONS ONLY. THE DESIGN PROFESSIONAL HAS NO RESPONSIBILITY FOR CONCEALED, UNDOCUMENTED, OR INACCESSIBLE CONDITIONS INCLUDING BUT NOT LIMITED TO STRUCTURAL ELEMENTS, SERVICES, FRAMING, INSULATION, VAPOUR BARRIERS, FIRE SEPARATIONS, HAZARDOUS MATERIALS, OR UNDERGROUND UTILITIES.  
THE DESIGN PROFESSIONAL DOES NOT WARRANT THAT EXISTING BUILDINGS OR STRUCTURES COMPLY WITH CURRENT CODES, STANDARDS, OR REGULATIONS.  
CONTRACT DOCUMENTS ASSUME EXISTING STRUCTURES AND SYSTEMS ARE SUBSTANTIALLY IN ACCORDANCE WITH APPLICABLE CODES AND STANDARDS IN EFFECT AT THE TIME OF ORIGINAL CONSTRUCTION UNLESS NOTED OTHERWISE. EXISTING DEREGIONS OR CONCEALED DETERIORATION ARE NOT THE RESPONSIBILITY OF THE DESIGN PROFESSIONAL AND WILL BE ADDRESSED IF AND WHEN DISCOVERED BY WRITTEN DIRECTION AND APPROVED CHANGE.  
**MANUFACTURER SYSTEMS, SHOP DRAWINGS, AND PROPRIETARY PRODUCTS**  
WHERE PROPRIETARY SYSTEMS OR ASSEMBLIES ARE SPECIFIED, THE DESIGN PROFESSIONAL RELIES ON MANUFACTURER PUBLISHED INFORMATION AND DOES NOT WARRANT THE PERFORMANCE, SUITABILITY, OR INSTALLATION OF SUCH SYSTEMS.  
SHOP DRAWINGS, PRODUCT DATA, AND SAMPLES ARE PREPARED BY OTHERS AND ARE REVIEWED BY THE DESIGN PROFESSIONAL SOLELY FOR GENERAL CONFORMANCE WITH THE DESIGN INTENT. SUCH REVIEW DOES NOT TRANSFER RESPONSIBILITY FOR ACCURACY, COMPLETENESS, COORDINATION, PERFORMANCE, OR COMPLIANCE WITH CODES, STANDARDS, OR MANUFACTURER REQUIREMENTS.  
**WINDOWS, GLAZING, AND SPECIALTY TRADE COORDINATION**  
IN ACCORDANCE WITH RAIC AND CONSTRUCTION SPECIFICATIONS CANADA STANDARD PRACTICE, ARCHITECTURAL DRAWINGS ESTABLISH DESIGN INTENT, VISUAL ALIGNMENT, AND GENERAL CONFIGURATION ONLY.  
FINAL UNIT SIZING, MULLION CONFIGURATION, TOLERANCES, ANCHORAGE, STRUCTURAL ADEQUACY, AND COORDINATION NECESSARY TO ACHIEVE THE DESIGN INTENT ARE THE RESPONSIBILITY OF THE WINDOW MANUFACTURER THROUGH THE PREPARATION OF SHOP DRAWINGS.  
THE WINDOW MANUFACTURER IS RESPONSIBLE FOR DETERMINING AND ADJUSTING ACTUAL UNIT SIZES, MULLION WIDTHS, AND VERTICAL AND HORIZONTAL OFFSETS, INCLUDING SUBFLOOR TO SUBFLOOR DIMENSIONS, TO ACHIEVE THE DESIGN INTENT AND TO COORDINATE WITH STRUCTURAL, ENVELOPE, AND CONSTRUCTION CONDITIONS.  
SIMILAR RESPONSIBILITY APPLIES TO ALL SPECIALTY TRADES AND SUPPLIERS PROVIDING PROPRIETARY OR PREFABRICATED SYSTEMS, INCLUDING BUT NOT LIMITED TO GLAZING, CLADDING, RAILINGS, STAIRS, AND MILLWORK.  
**CONSULTANTS AND ENGINEERING**  
STRUCTURAL SYSTEMS, BEAMS, COLUMNS, FOOTINGS, AND ENGINEERED COMPONENTS SHOWN ARE INDICATIVE ONLY. FINAL DESIGN, CERTIFICATION, AND FIELD REVIEW ARE THE RESPONSIBILITY OF THE PROFESSIONAL ENGINEER OF RECORD AND APPLICABLE MANUFACTURERS' ENGINEERS.  
SHOP DRAWINGS AND DELEGATED DESIGN SUBMISSIONS INCLUDING BUT NOT LIMITED TO TRUSSES, ENGINEERED WOOD PRODUCTS, GUARDRAILS, STAIRS, GLAZING SYSTEMS, AND SPECIALTY FABRICATIONS SHALL BE PREPARED AND SEALED WHERE REQUIRED BY THE APPROPRIATE LICENSED PROFESSIONAL RETAINED BY THE BUILDER/CONTRACTOR OR SUPPLIER AND ARE THE RESPONSIBILITY OF THAT PARTY.  
VERIFICATION OF SOIL CONDITIONS, BEARING CAPACITY, CONCRETE STRENGTH, COMPACTION, AND OTHER FIELD CONDITIONS IS THE RESPONSIBILITY OF THE CONTRACTOR AND APPLICABLE ENGINEERS OF RECORD AND NOT THE DESIGN PROFESSIONAL.  
THE DESIGN PROFESSIONAL MAY RELY ON INFORMATION PROVIDED BY CONSULTANTS AND IS NOT RESPONSIBLE FOR ERRORS OR OMISSIONS IN INFORMATION PREPARED BY OTHERS.  
**ENERGY CODE AND BUILDING ENVELOPE ENGINEERING**  
THERMAL CALCULATIONS AND ENERGY PERFORMANCE INFORMATION SHOWN ARE INDICATIVE ONLY. FINAL DESIGN, TESTING, AND CERTIFICATION ARE THE RESPONSIBILITY OF THE BUILDING ENVELOPE ENGINEER OF RECORD.  
THE BUILDER/CONTRACTOR IS RESPONSIBLE FOR COORDINATING REQUIRED TESTING, AIR TIGHTNESS VERIFICATION, AND CERTIFICATIONS.

**INTERIOR DESIGN AND THIRD-PARTY DRAWINGS**  
INTERIOR DESIGN DRAWINGS, MILLWORK SHOP DRAWINGS, LIGHTING LAYOUTS, AND CONSULTANT DOCUMENTS PREPARED BY THIRD PARTIES ARE SEPARATE INSTRUMENTS OF SERVICE. SUCH DOCUMENTS DO NOT OVERRIDE THE ARCHITECTURAL DRAWINGS UNLESS SPECIFICALLY REVIEWED, COORDINATED, AND ISSUED IN WRITING BY MKL DESIGN STUDIO INC.  
THE DESIGN PROFESSIONAL IS NOT RESPONSIBLE FOR CONFLICTS, DISCREPANCIES, OR COORDINATION ISSUES ARISING FROM THIRD-PARTY INTERIOR DESIGN DRAWINGS OR DOCUMENTS THAT HAVE NOT BEEN FORMALLY INCORPORATED INTO THE CONTRACT DOCUMENTS.

**MECHANICAL, ELECTRICAL, AND PLUMBING**  
LOCATIONS OF MECHANICAL, ELECTRICAL, AND PLUMBING SERVICES ARE SUBJECT TO CHANGE DUE TO SITE CONDITIONS. THE BUILDER/CONTRACTOR IS RESPONSIBLE FOR COORDINATION OF ALL INCOMING AND OUTGOING SERVICES UNLESS NOTED OTHERWISE.

**BUILDING ENVELOPE, MOISTURE, AND NOISE**  
THE DESIGN PROFESSIONAL DOES NOT WARRANT OR GUARANTEE THE PERFORMANCE OF BUILDING ENVELOPE ASSEMBLIES.  
THE DESIGN PROFESSIONAL MAKES NO REPRESENTATIONS REGARDING THE PRESENCE, PREVENTION, TESTING, MONITORING, OR REMEDIATION OF MOULD, MILDEW, FUNGI, OR INDOOR AIR QUALITY CONDITIONS. ENVIRONMENTAL EVALUATION, TESTING, AND REMEDIATION SERVICES ARE OUTSIDE THE SCOPE OF WORK.

**REPORTING OF ERRORS AND CLARIFICATIONS**  
ANY ERRORS, OMISSIONS, OR DISCREPANCIES IN THE DRAWINGS MUST BE REPORTED TO MKL DESIGN STUDIO INC. PRIOR TO CONSTRUCTION. FAILURE TO REPORT DISCREPANCIES PRIOR TO CONSTRUCTION TRANSFERS RESPONSIBILITY TO THE BUILDER/CONTRACTOR, AND/OR CLIENT.  
WHERE APPLICABLE, DISCREPANCIES SHALL ALSO BE REPORTED TO THE ENGINEER OF RECORD FOR CLARIFICATION.

**CHANGES AND DEVIATIONS**  
ALL CHANGES, SUBSTITUTIONS, OR DEVIATIONS FROM THE CONTRACT DOCUMENTS MUST BE REVIEWED AND APPROVED IN WRITING BY MKL DESIGN STUDIO INC. UNAUTHORIZED CHANGES ARE MADE AT THE BUILDER/CONTRACTOR'S AND/OR CLIENT'S SOLE RISK.  
ANY REVISIONS, SUBSTITUTIONS, OR INTERPRETATIONS MADE AFTER PERMIT ISSUANCE THAT ARE NOT DOCUMENTED AND ISSUED IN WRITING BY MKL DESIGN STUDIO INC. ARE NOT PART OF THE CONTRACT DOCUMENTS AND ARE UNDERTAKEN AT THE BUILDER/CONTRACTOR'S AND/OR CLIENT'S RISK.

**OWNER-PERFORMED WORK**  
MKL DESIGN STUDIO INC. ASSUMES NO RESPONSIBILITY OR LIABILITY FOR WORK PERFORMED BY THE CLIENT.

**FIREPLACES, ELEVATORS, AND SPECIALTY INSTALLATIONS**  
FIREPLACE LOCATIONS AND FRAMING SHOWN ARE FOR REFERENCE ONLY. BUILDERS/CONTRACTORS MUST VERIFY ALL CLEARANCES, FIRE PROTECTION, VENTING, COMBUSTION AIR, AND INSTALLATION REQUIREMENTS WITH THE SUPPLIER AND MANUFACTURER PRIOR TO CONSTRUCTION.  
WHERE ELEVATORS, LIFTS, OR VERTICAL TRANSPORTATION SYSTEMS ARE INCLUDED, EQUIPMENT SELECTION, DESIGN, SIZING, CLEARANCES, STRUCTURAL LOADS, INSTALLATION, CODE COMPLIANCE, INSPECTIONS, AND CERTIFICATION ARE THE RESPONSIBILITY OF THE ELEVATOR MANUFACTURER AND LICENSED INSTALLER. REVIEW BY THE DESIGN PROFESSIONAL IS LIMITED TO GENERAL CONFORMANCE WITH DESIGN INTENT AND DOES NOT TRANSFER RESPONSIBILITY FOR PERFORMANCE, SAFETY, OR REGULATORY APPROVAL.

**INTELLECTUAL PROPERTY AND LIMITED LICENSE**  
ALL DRAWINGS, SPECIFICATIONS, AND DESIGN MATERIALS REMAIN THE INTELLECTUAL PROPERTY OF MKL DESIGN STUDIO INC.  
THE CLIENT IS GRANTED A LIMITED, NON-TRANSFERABLE LICENSE TO USE THE DOCUMENTS FOR CONSTRUCTION OF ONE DWELLING ONLY AT THE LOCATION IDENTIFIED ON THE DRAWINGS. REUSE, REPRODUCTION, MODIFICATION, OR USE ON ANOTHER PROJECT WITHOUT WRITTEN AUTHORIZATION IS PROHIBITED AND RELEASES MKL DESIGN STUDIO INC.

PERMIT INFORMATION  
DEVELOPMENT PERMIT NUMBER  
**DP NUMBER**  
BUILDING PERMIT NUMBER  
**BP NUMBER**

### DEVELOPMENT PERMIT DRAWINGS

SET ISSUE DATE	
ISSUE	DATE
PDF	12 MAY 2026

### COVER PAGE

SHEET NO.  
**A.0**

SCALE  
N.T.S.

DRAWN BY  
F.A.

PL01 THE5AMP 5/12/2026 3:55:11 PM

MAN FLOOR AREA	1860 SF
ABOVE GRADE DEVELOPED TOTAL	1860 SF
LOWER FLOOR AREA	1572 SF
BELOW GRADE DEVELOPED TOTAL	1572 SF
GARAGE	487 SF
GARAGE TOTAL	487 SF
MECHANICAL	111 SF
UNDEVELOPED TOTAL	111 SF
UNCOVERED DECK	272 SF
UNCOVERED FRONT PORCH	68 SF
DECKS & PATIOS UNCOVERED TOTAL	340 SF


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MARK	DESCRIPTION
01	STANDING SEAM METAL ROOF
02	TIN STONE VENEER- CHU BRICK
03	ACH PANEL
04	VERTICAL COMPOSITE WALL PANEL
05	STUCCO AS PER SPEC (EXPANSION JOINTS AS INDICATED)
06	ACH PANEL FASCIA
07	6" SMART TRIM FASCIA (COLOUR TO MATCH ACH PANEL FASCIA)
08	6" SMARTBOARD TRIM
09	FARBING


EXPOSED BUILDING FACE SPATIAL CALCULATION	
TOTAL AREA OF EXPOSED BUILDING FACE	= 102.83 M <sup>2</sup>
AREA OF EXPOSED BUILDING FACE 2	= 102.83 M <sup>2</sup>
LIFTING DISTANCE	= 1.58 M
INTERPOLATED ALLOWABLE GLAZING (8)	= 1.16 M
ALLOWABLE GLAZING (11)	= 1.36 M
PROPOSED GLAZING (11)	= 1.32 M

FACE #2  
102.83 M<sup>2</sup>


OPENINGS #1  
1.32 M<sup>2</sup>

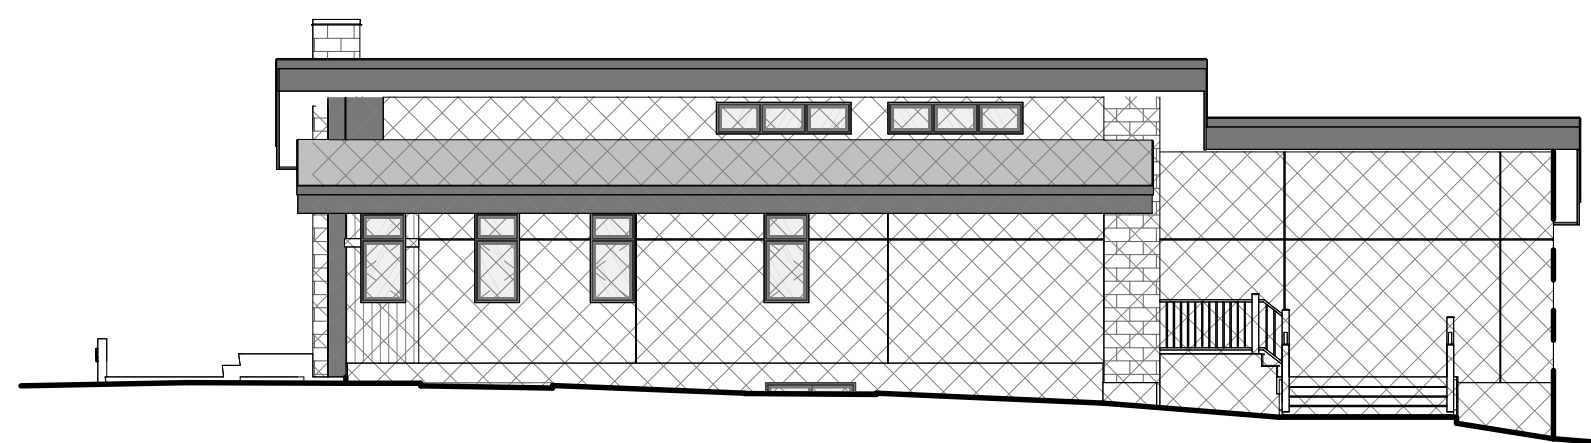

1  
A.4  
FRONT ELEVATION  
3/16" = 1'-0"

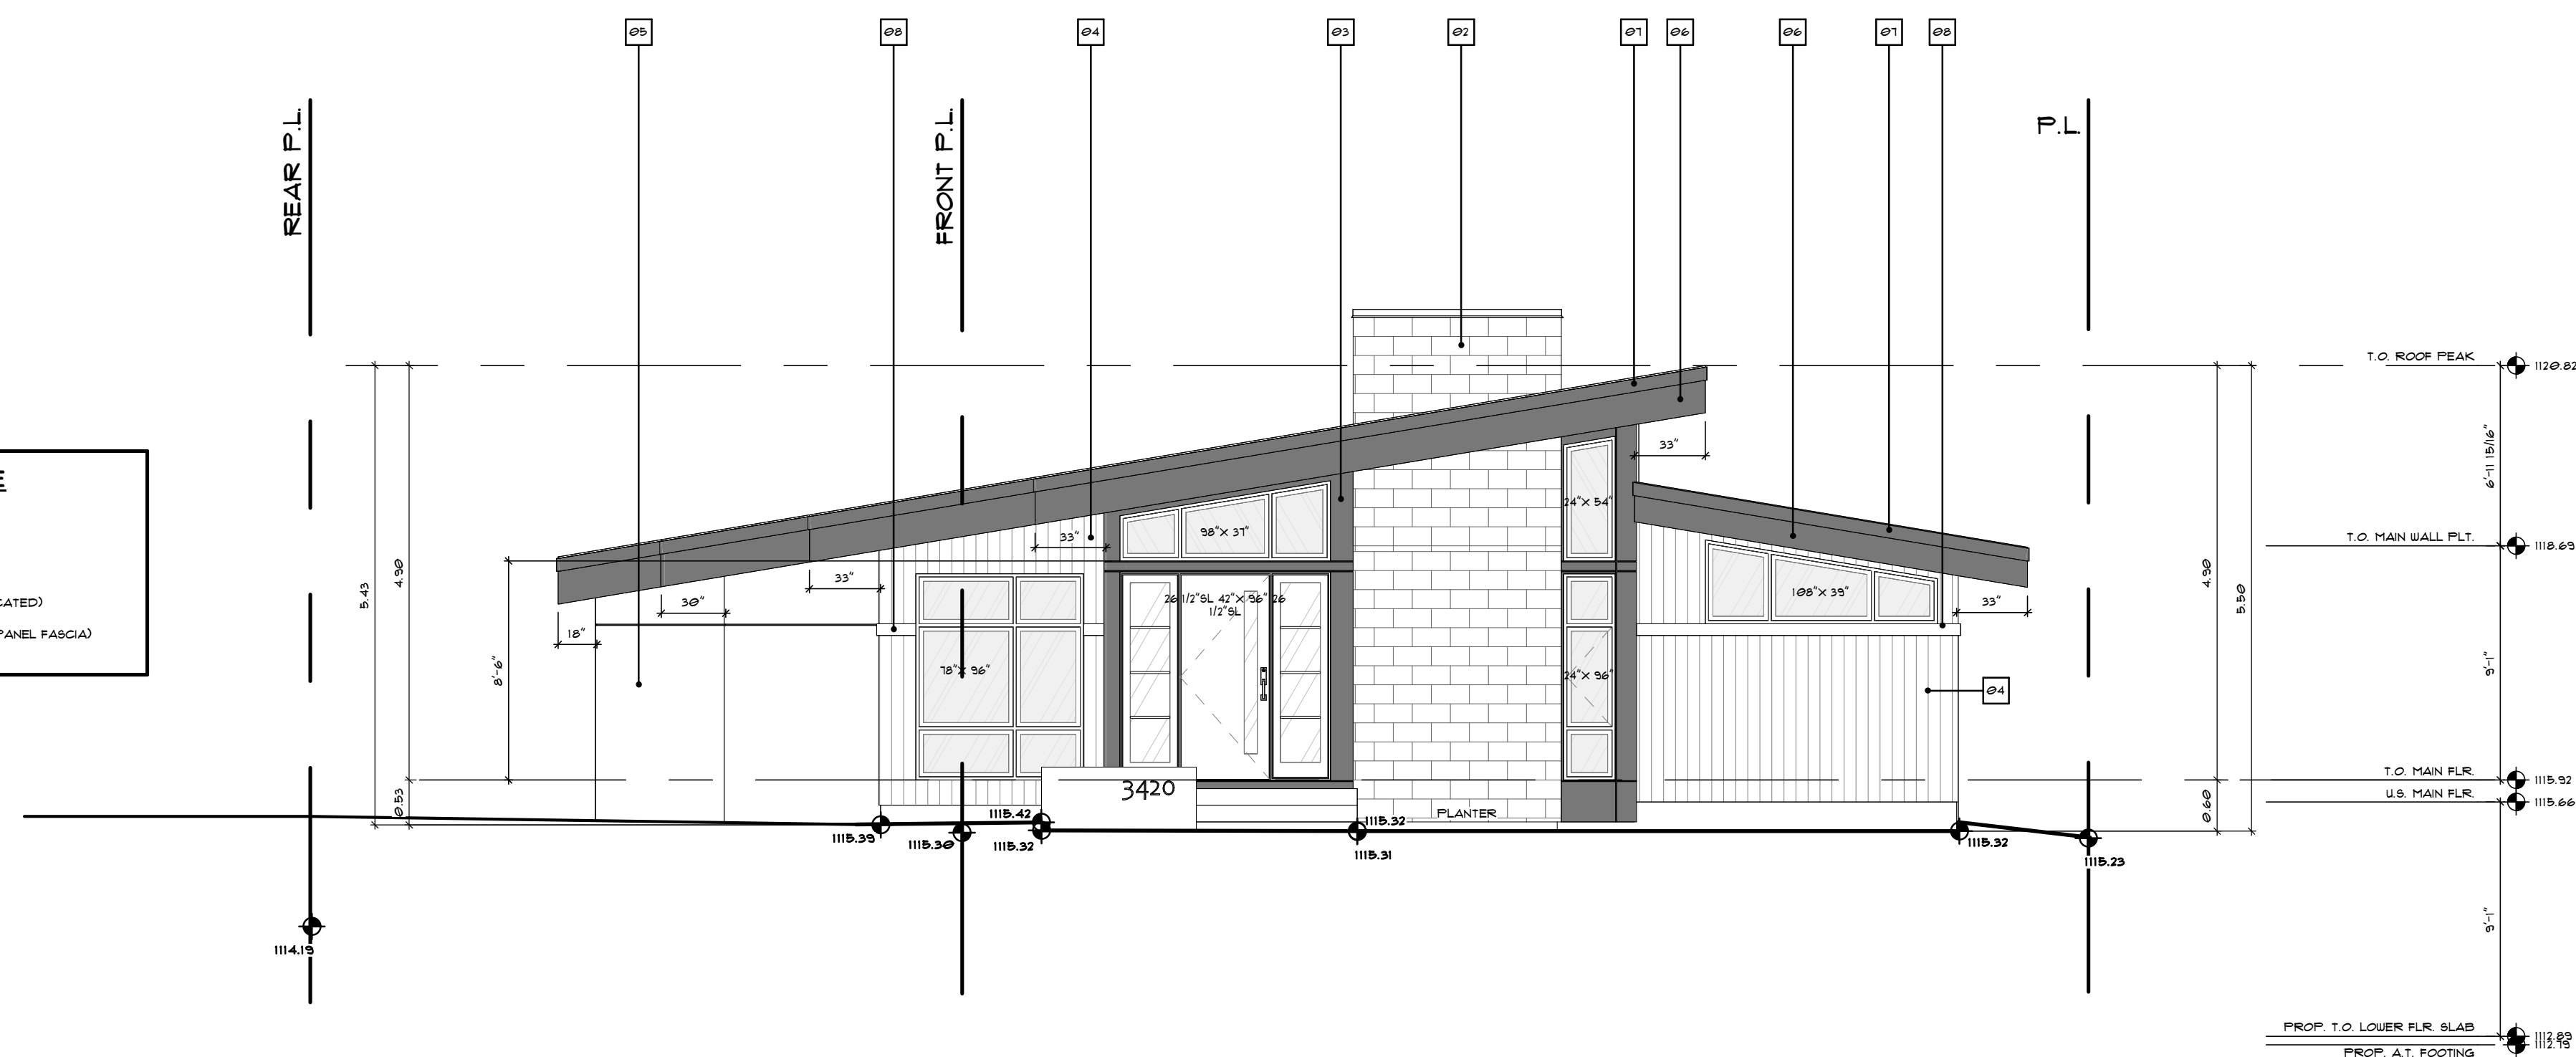

3  
A.4  
RIGHT ELEVATION- SPATIAL SEPARATION  
3/32" = 1'-0"

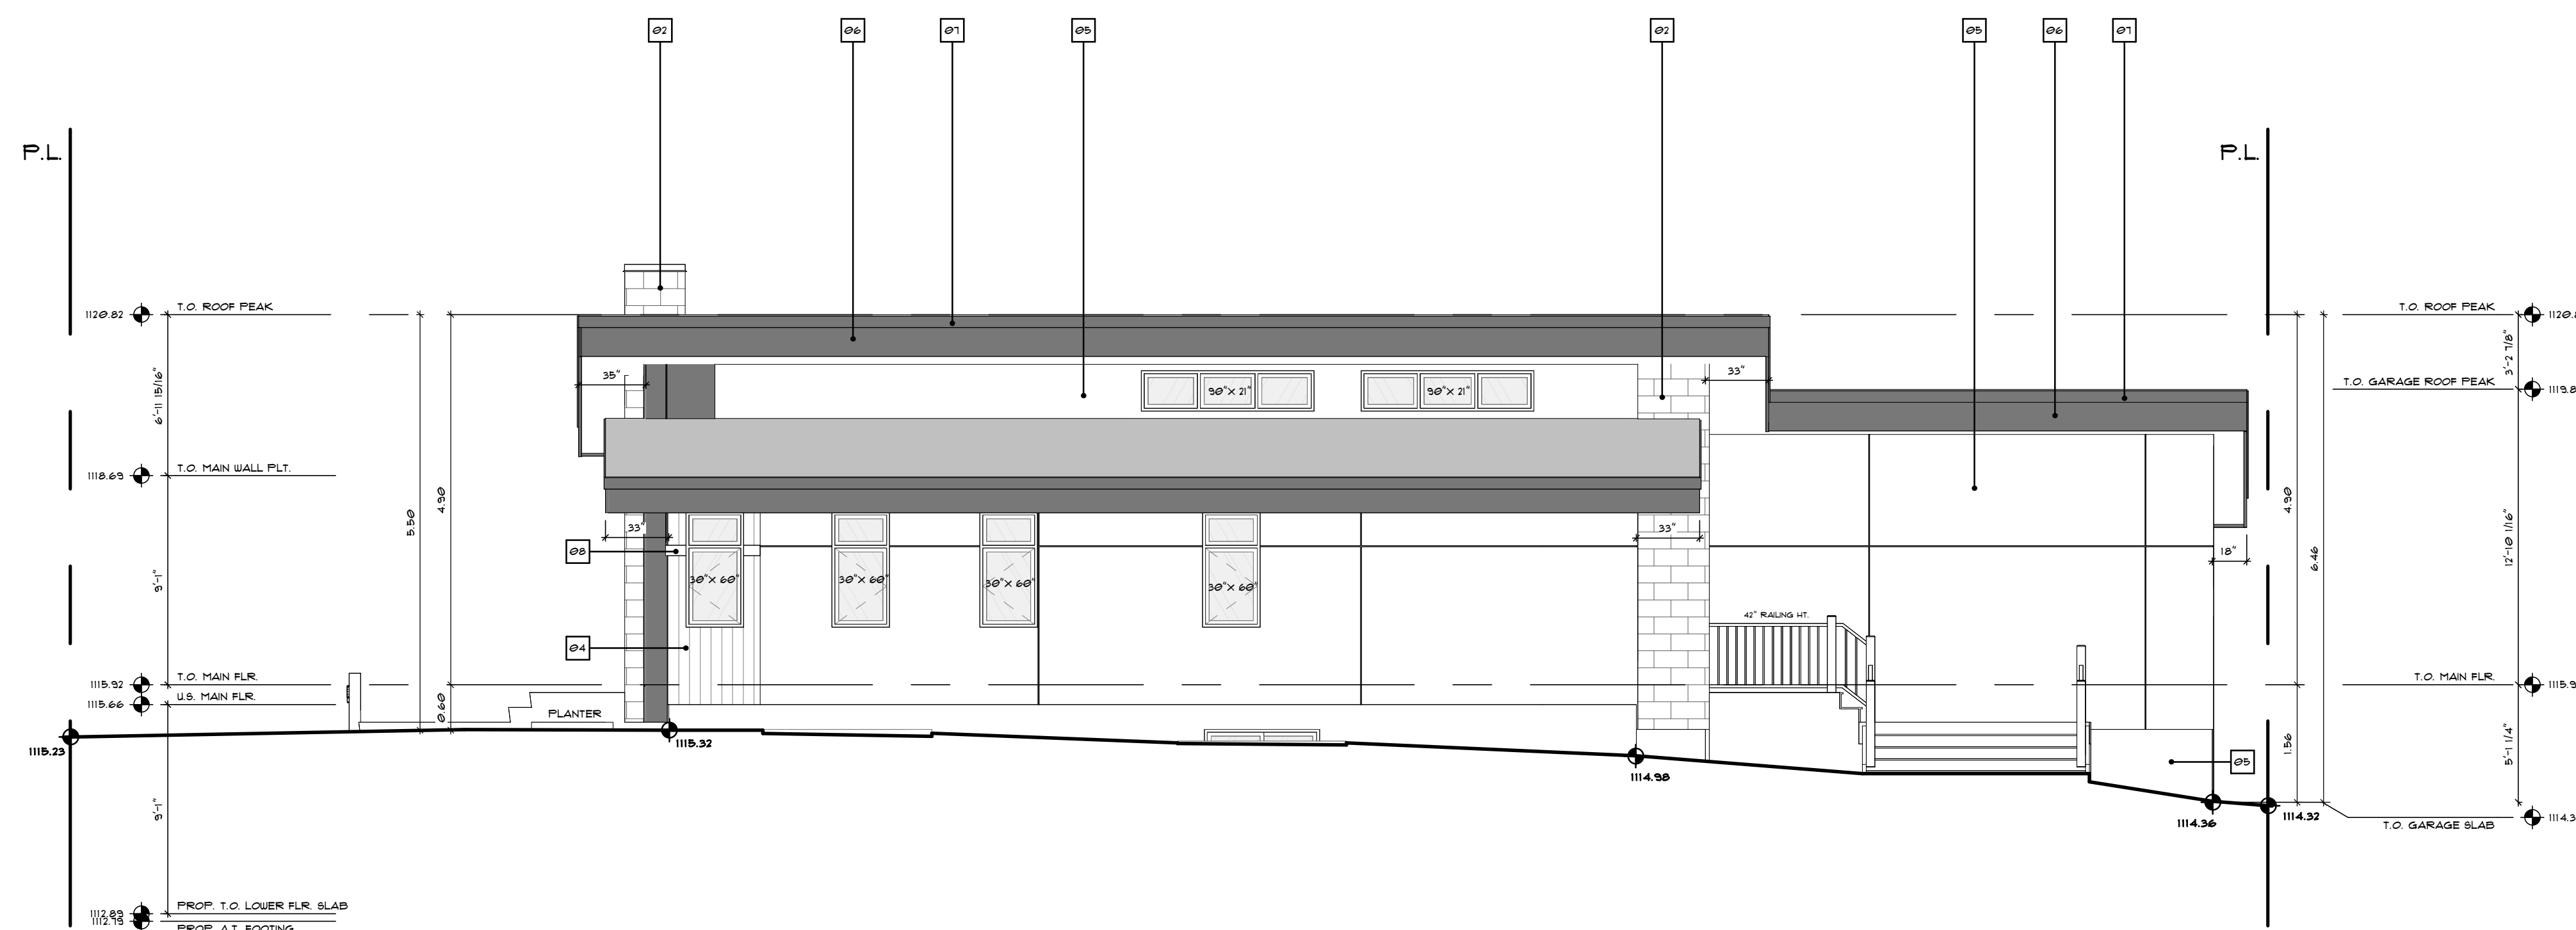


2  
A.4  
RIGHT ELEVATION  
3/16" = 1'-0"


EXPOSED BUILDING FACE SPATIAL CALCULATION	
TOTAL AREA OF EXPOSED BUILDING FACE	= 104.22 M <sup>2</sup>
AREA OF EXPOSED BUILDING FACE 1	= 104.22 M <sup>2</sup>
LIFTING DISTANCE	= 1.22 M
INTERPOLATED ALLOWABLE GLAZING (%)	= 1.00 %
ALLOWABLE GLAZING (M <sup>2</sup> )	= 1.30 M <sup>2</sup>
PROPOSED GLAZING (M <sup>2</sup> )	= 4.92 M <sup>2</sup>

FACE #3  
104.22 M<sup>2</sup>

OPENINGS #3  
4.92 M<sup>2</sup>

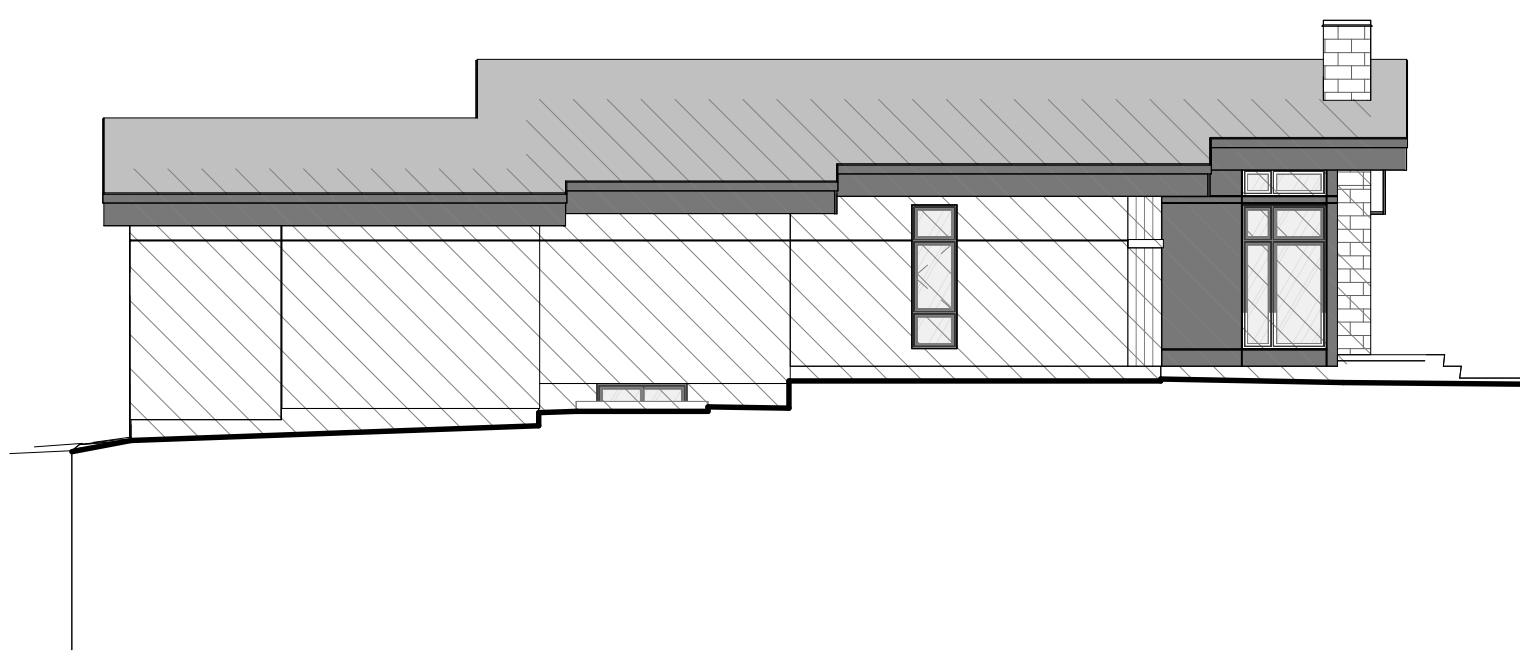


3 LEFT ELEVATION - SPATIAL SEPARATION  
A.5 3/32" = 1'-0"

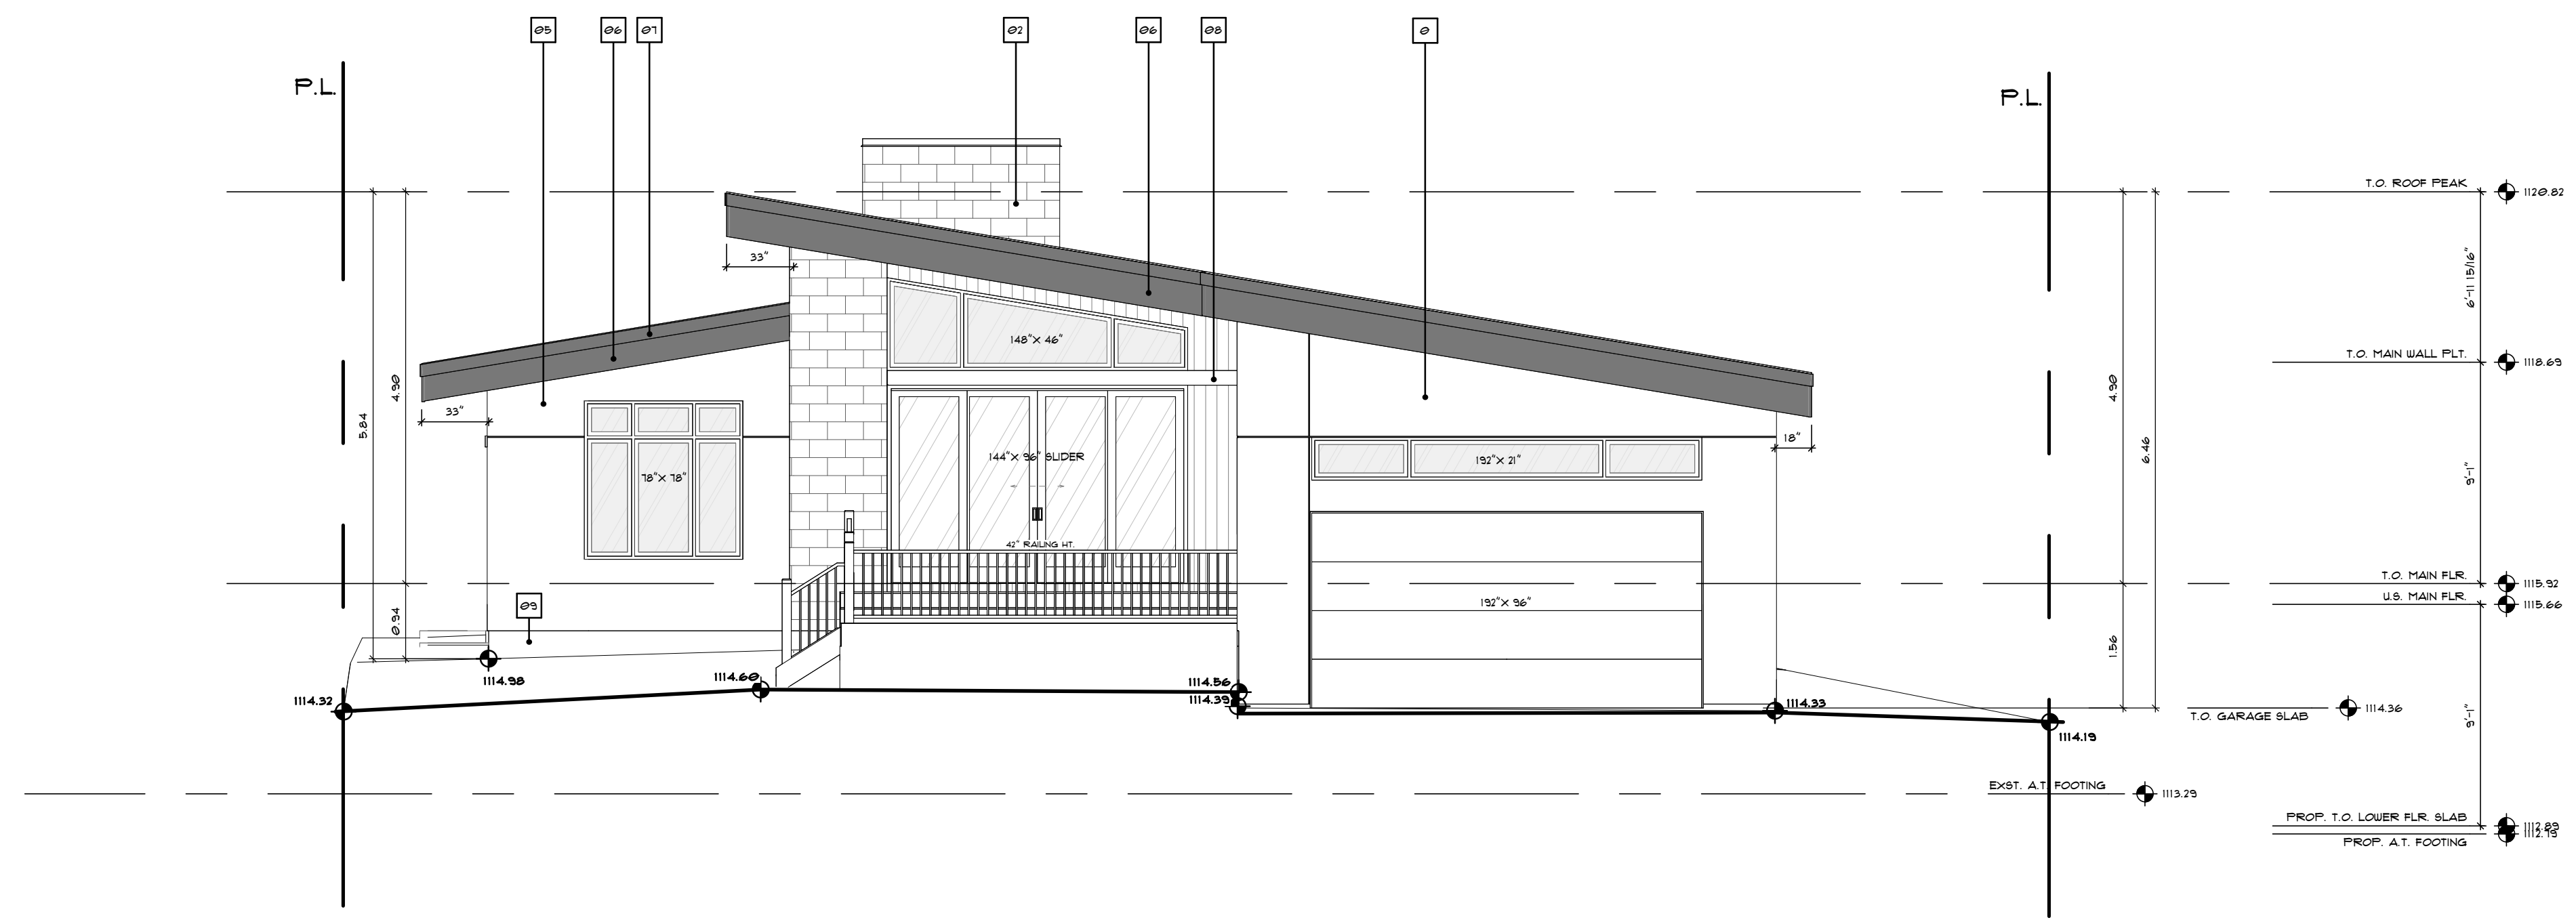

1 REAR ELEVATION  
A.5 3/16" = 1'-0"

MARK	DESCRIPTION
O1	STANDING BEAM METAL ROOF
O2	THIN STONE VENEER/ CRU BRICK
O3	ACH PANEL
O4	VERTICAL COMPOSITE WALL PANEL
O5	STUCCO AS PER SPEC (EXPANSION JOINTS AS INDICATED)
O6	ACH PANEL FASCIA
O7	6" SMART TRIM FASCIA (COLOUR TO MATCH ACH PANEL FASCIA)
O8	6" SMARTBOARD TRIM
O9	FARGING

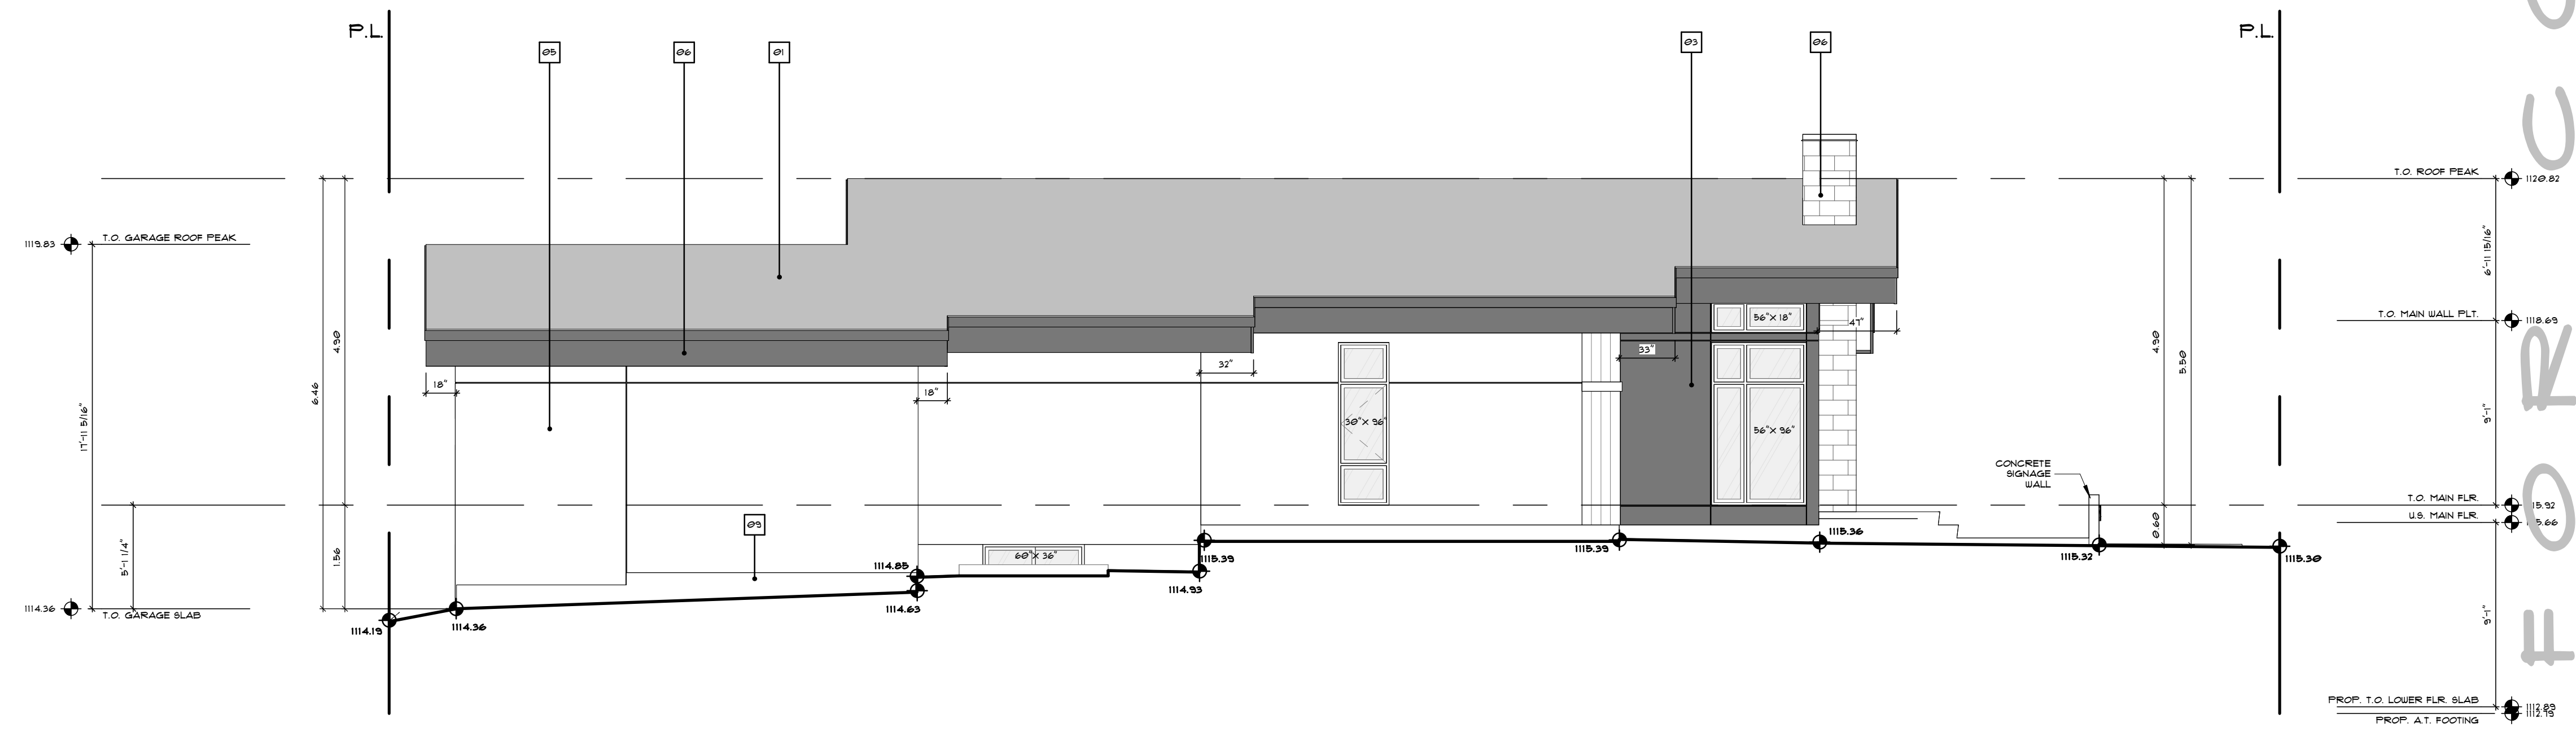

2 LEFT ELEVATION  
A.5 3/16" = 1'-0"

403-984-1513

BUILDER

PROJECT NAME  
**3420 LANE CRESCENT SW**

PROJECT INFO	
ADDRESS	3420 LANE CRESCENT SW CALGARY, AB
ADDRESS LEGAL	LOT 176 PLAN S05JK BLOCK 6
COMPANY	LAKEVIEW
DESIGN	R-CG
AREAS	
MAN FLOOR AREA	1860 SF
ABOVE GRADE DEVELOPED TOTAL	1860 SF
LOWER FLOOR AREA	1572 SF
BELOW GRADE DEVELOPED TOTAL	1572 SF
GARAGE	487 SF
GARAGE TOTAL	487 SF
MECHANICAL	111 SF
UNDEVELOPED TOTAL	111 SF
UNCOVERED DECK	272 SF
UNCOVERED FRONT PORCH	68 SF
DECKS & PATIOS UNCOVERED TOTAL	340 SF

PERMIT INFORMATION  
DEVELOPMENT PERMIT NUMBER  
DP NUMBER  
BUILDING PERMIT NUMBER  
BP NUMBER

DRAWING VERSION

**DEVELOPMENT PERMIT DRAWINGS**

SET ISSUE DATE  
ISSUE DATE  
12 MAY 2026

DRAWING TITLE

**REAR & LEFT ELEVATION**

SHEET NO.  
**A.5**

SCALE: AS INDICATED  
DRAWN BY: F.A.

Z O N I N G R E G U L A T I O N S



**PROJECT NAME**  
3420 LANE CRESCENT SW

**PROJECT INFO**  
ADDRESS  
3420 LANE CRESCENT SW  
CALGARY, AB  
ADDRESS LEGAL  
LOT 126  
PLAN 005JK  
BLOCK 6  
COMPANY  
LAKEVIEW  
ZONING  
R-CG

**AREAS**

MAIN FLOOR AREA	186.0 SF
ABOVE GRADE DEVELOPED TOTAL	186.0 SF
LOWER FLOOR AREA	157.2 SF
BELOW GRADE DEVELOPED TOTAL	157.2 SF
GARAGE	487.5 SF
GARAGE TOTAL	487.5 SF
MECHANICAL	111.5 SF
UNDEVELOPED TOTAL	111.5 SF
UNCOVERED DECK	27.2 SF
UNCOVERED FRONT PORCH	6.8 SF
DECKS & PATIOS UNCOVERED TOTAL	34.0 SF

**PERMIT INFORMATION**  
DEVELOPMENT PERMIT NUMBER  
DP NUMBER  
BUILDING PERMIT NUMBER  
BP NUMBER

**DRAWING VERSION**

**DEVELOPMENT PERMIT DRAWINGS**

SET ISSUE DATE  
ISSUE DATE  
DATE  
12 MAY 2026

IFDP 12 MAY 2026




**DRAWING TITLE**

**BLOCK PLAN & STREETSCAPE**

SHEET NO.

**A.2**

SCALE AS INDICATED  
DRAWN BY F.A.

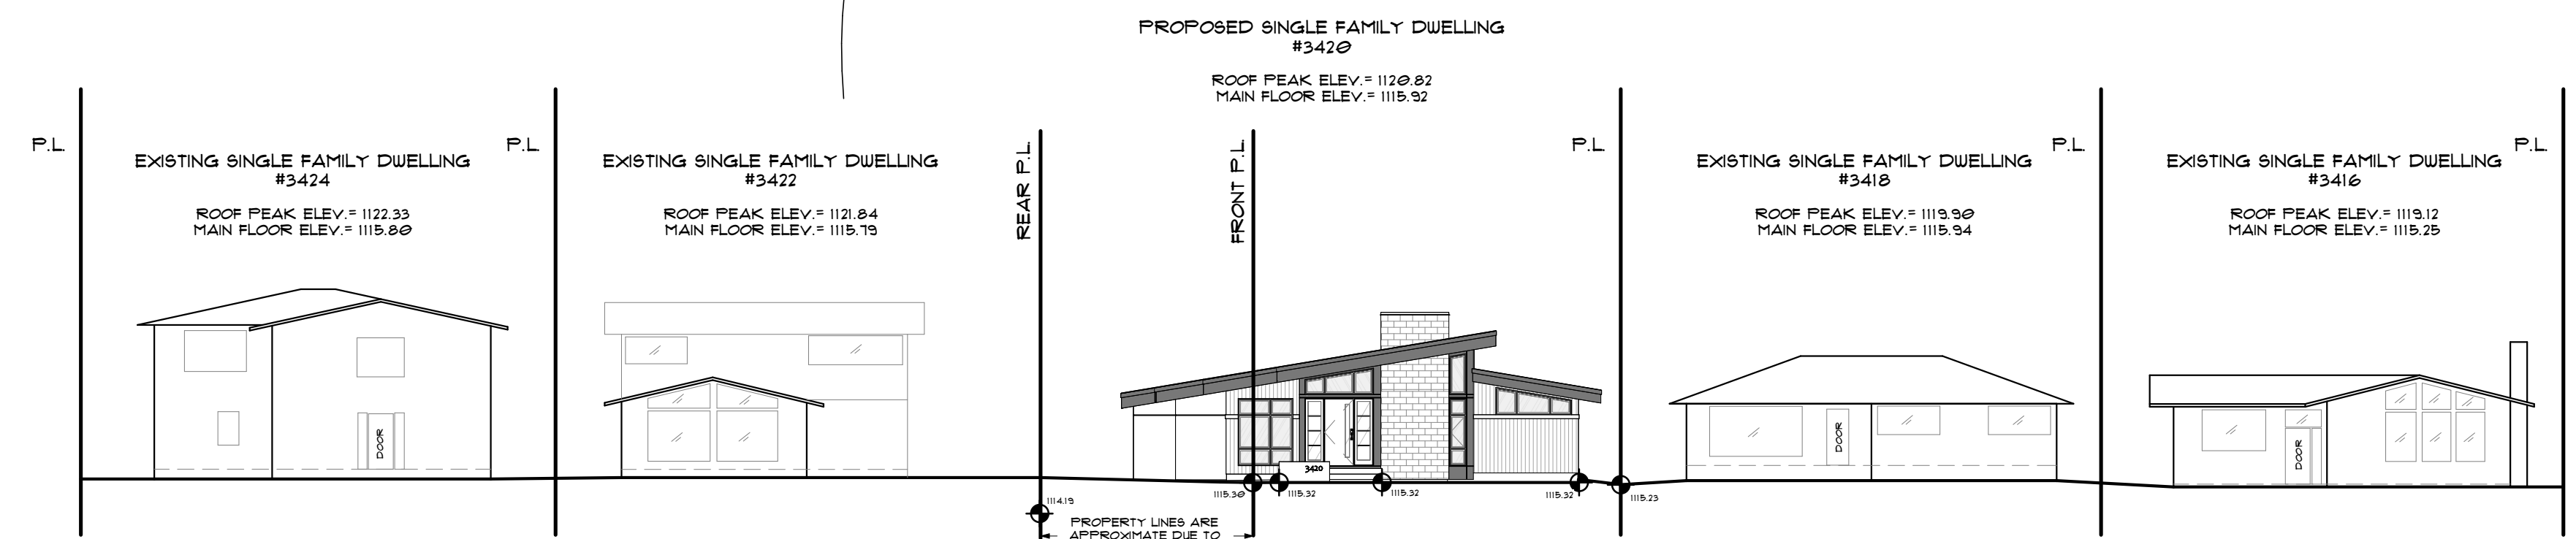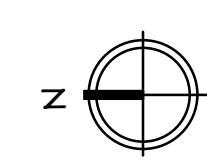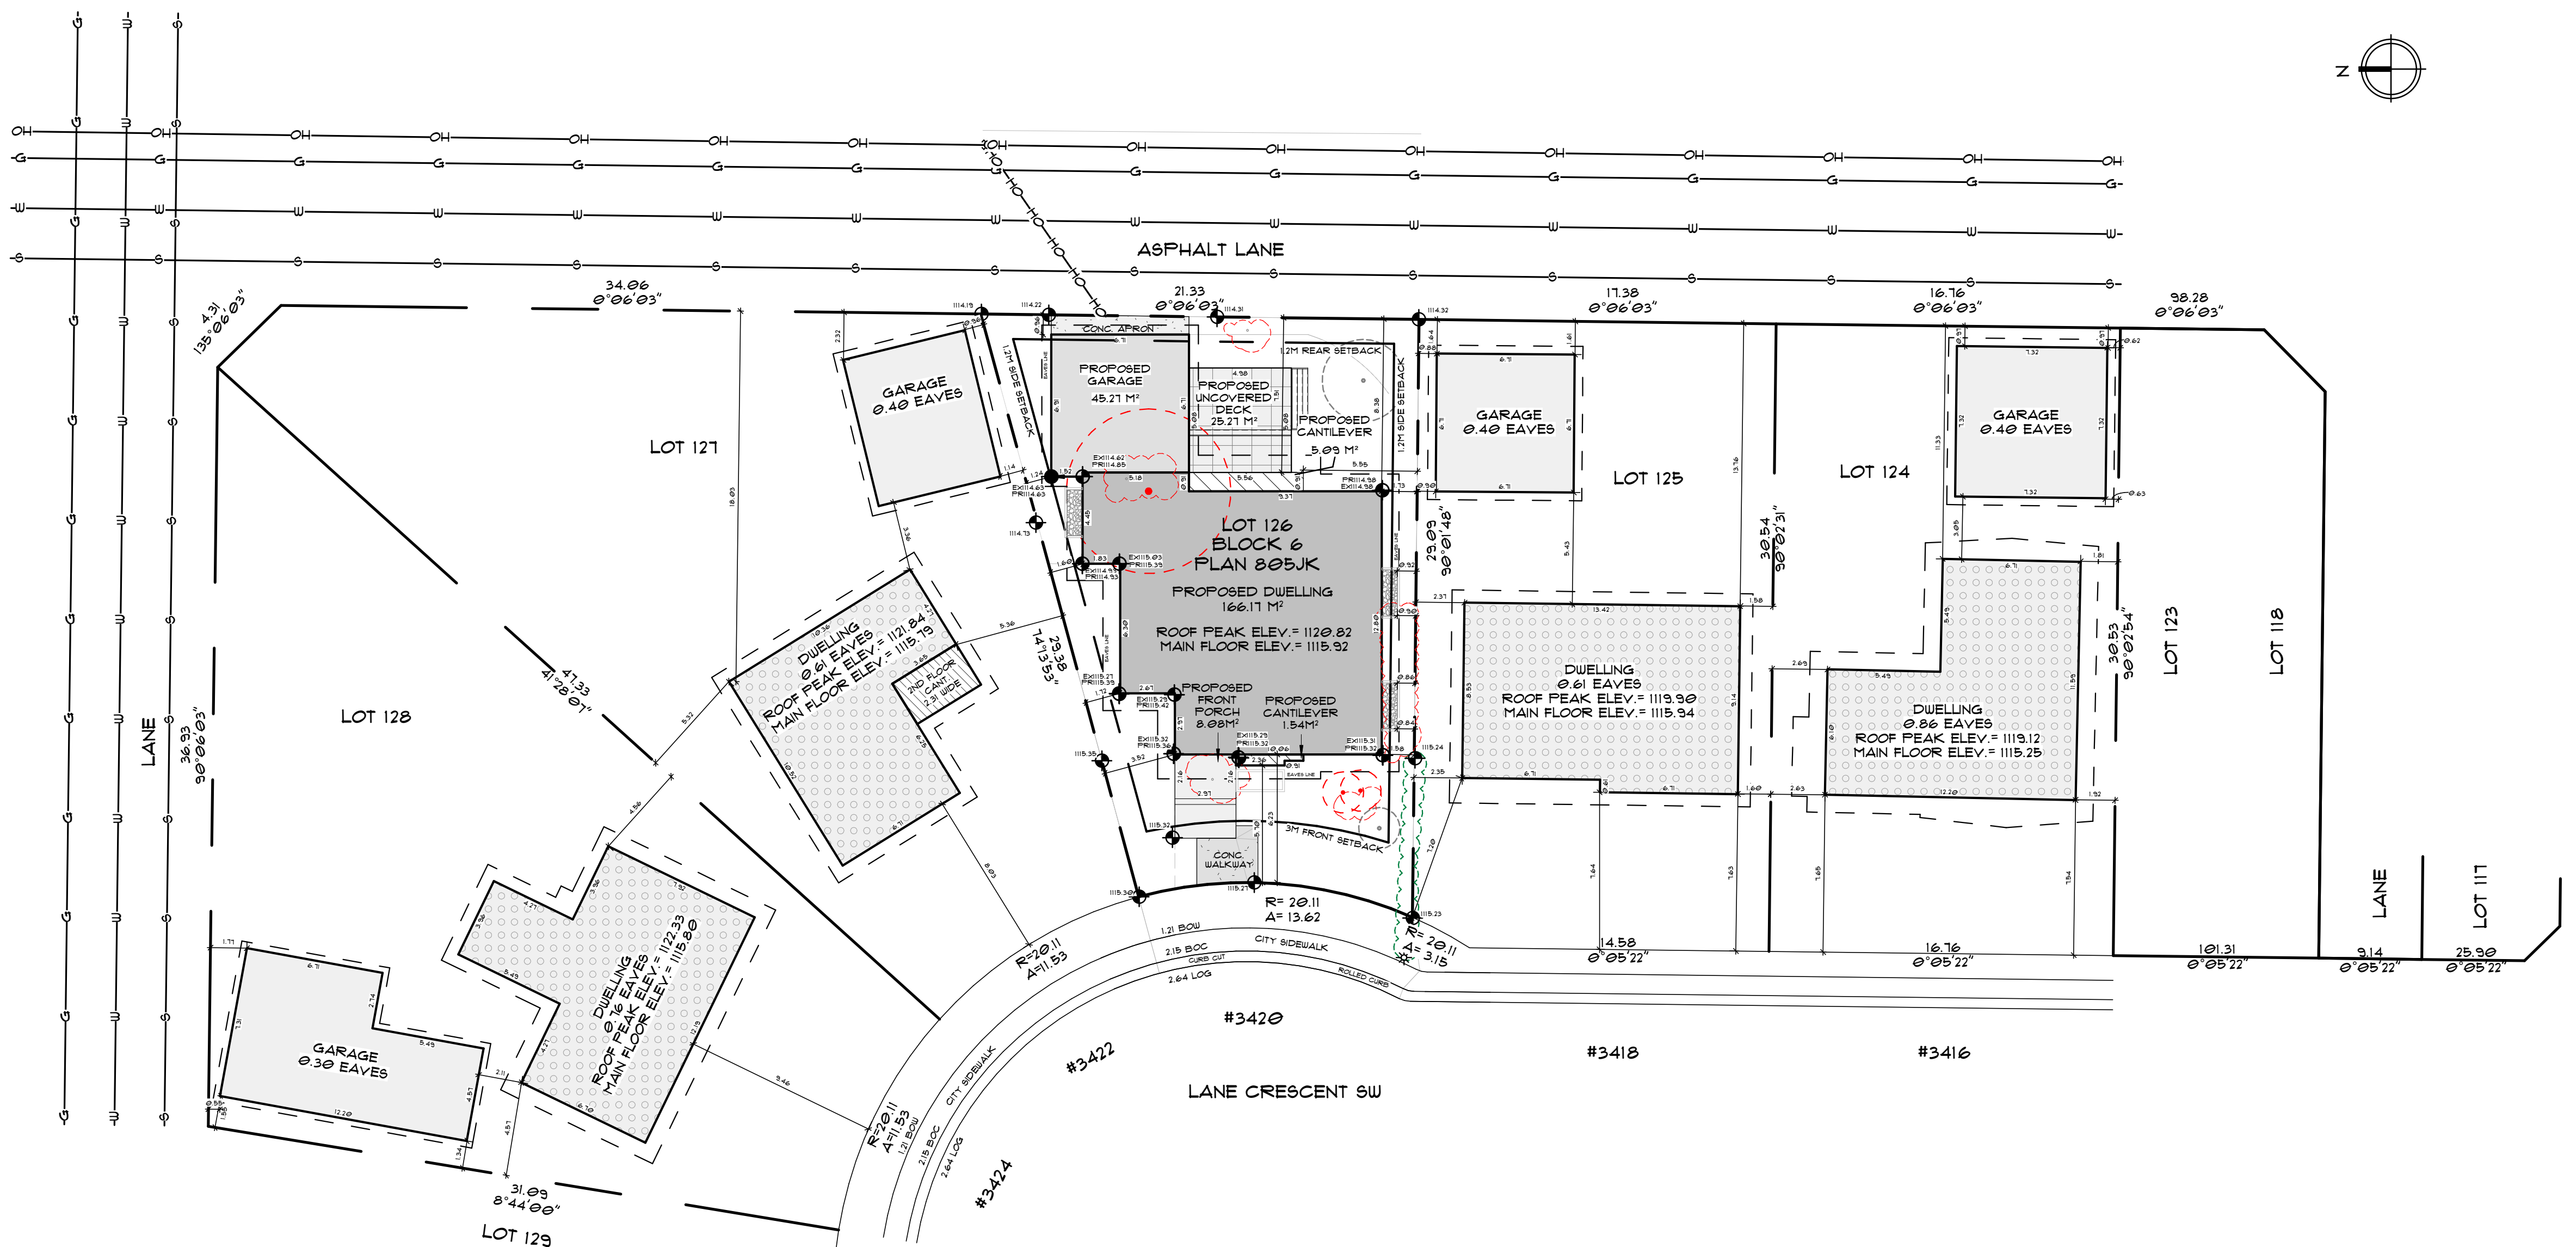

**ELEVATION DATUM POINTS**

T.O. ROOF PEAK	1120.82
T.O. MAIN FLR.	1115.92
U.S. MAIN FLR.	1115.66
EXST. T.O. LOWER FLR.	1113.39
EXST. A.T. FOOTING	1113.29
PROP. T.O. LOWER FLR. SLAB	1112.89
PROP. A.T. FOOTING	1112.79

**PARCEL COVERAGE CALCULATION**

AREA LOCATION	COVERAGE AREA	TOTAL PARCEL AREA	% OF COVERAGE
HOUSE	166.11	484.83	34.27%
GARAGE	45.21	484.83	9.34%
CANTILEVER	1.54	484.83	0.32%
CANTILEVER	5.09	484.83	1.05%
TOTAL	218.01	484.83	44.98%

**2**  
A.2  
1:200  
**STREETSCAPE**

**LEGEND**

PROPERTY LINE	— — — — —	PROPOSED DWELLING	[Solid Grey Box]	EXISTING GEODETIC DATUM	⬤ Exxx.00	LAMP STANDARD	[Sun Symbol]
SETBACK LINE	- - - - -	PROPOSED GARAGE	[Light Grey Box]	SLOPE OF GRADE	↔ 2% SLOPE	POWER POLE	[Circle with X]
FLOOR LINE ABV.	— — — — —	PROPOSED FRONT PORCH	[White Box]	NORTH ARROW	[North Arrow]	TREE TO BE REMOVED	[Red Circle]
EAVE LINE ABV.	- - - - -	PROPOSED UNCOVERED DECK/PATIO	[White Box]	TOP OF WALL	T.O.W.	NEW TREE/ REFER TO TREE SCHEDULE	[Green Circle]
WATER LINE	—W—W—W—W—	PROPOSED CANTILEVERS & PROJECTIONS	[Hatched Box]	BOTTOM OF WALL	B.O.W.	BUSH TO BE REMOVED	[Red Circle]
SEWER LINE	—S—S—S—S—	PROPOSED WALKWAY	[Dotted Box]	BACK OF CURB	B.O.C.	BUSH TO REMAIN	[Green Circle]
STORM LINE	—ST—ST—ST—ST—	PROPOSED DRIVEWAY	[Dotted Box]	LIP OF GUTTER	L.O.G.		
GAS LINE	—G—G—G—G—	EXISTING BUILDING	[Dotted Box]	BACK OF SIDEWALK	B.W.		
ELECTRICAL LINE	—E—E—E—E—	PROPOSED GEODETIC DATUM	⬤ Free.00				