

ONWARD SHAGANAPPI



1130, 140 - 4TH AVENUE S.W.
CALGARY, ALBERTA, CANADA
T2P 3N3

1406 26 Street SW, Calgary, AB T3C 1K3

Plan 2311009, Block 5, Lot 55

ISSUED FOR: DEVELOPMENT PERMIT

2026/03/06


PRELIMINARY - NOT FOR CONSTRUCTION



S1 - SITE PHOTO - VIEW FROM NORTHEAST




S2 - SITE PHOTO - VIEW FROM NORTH

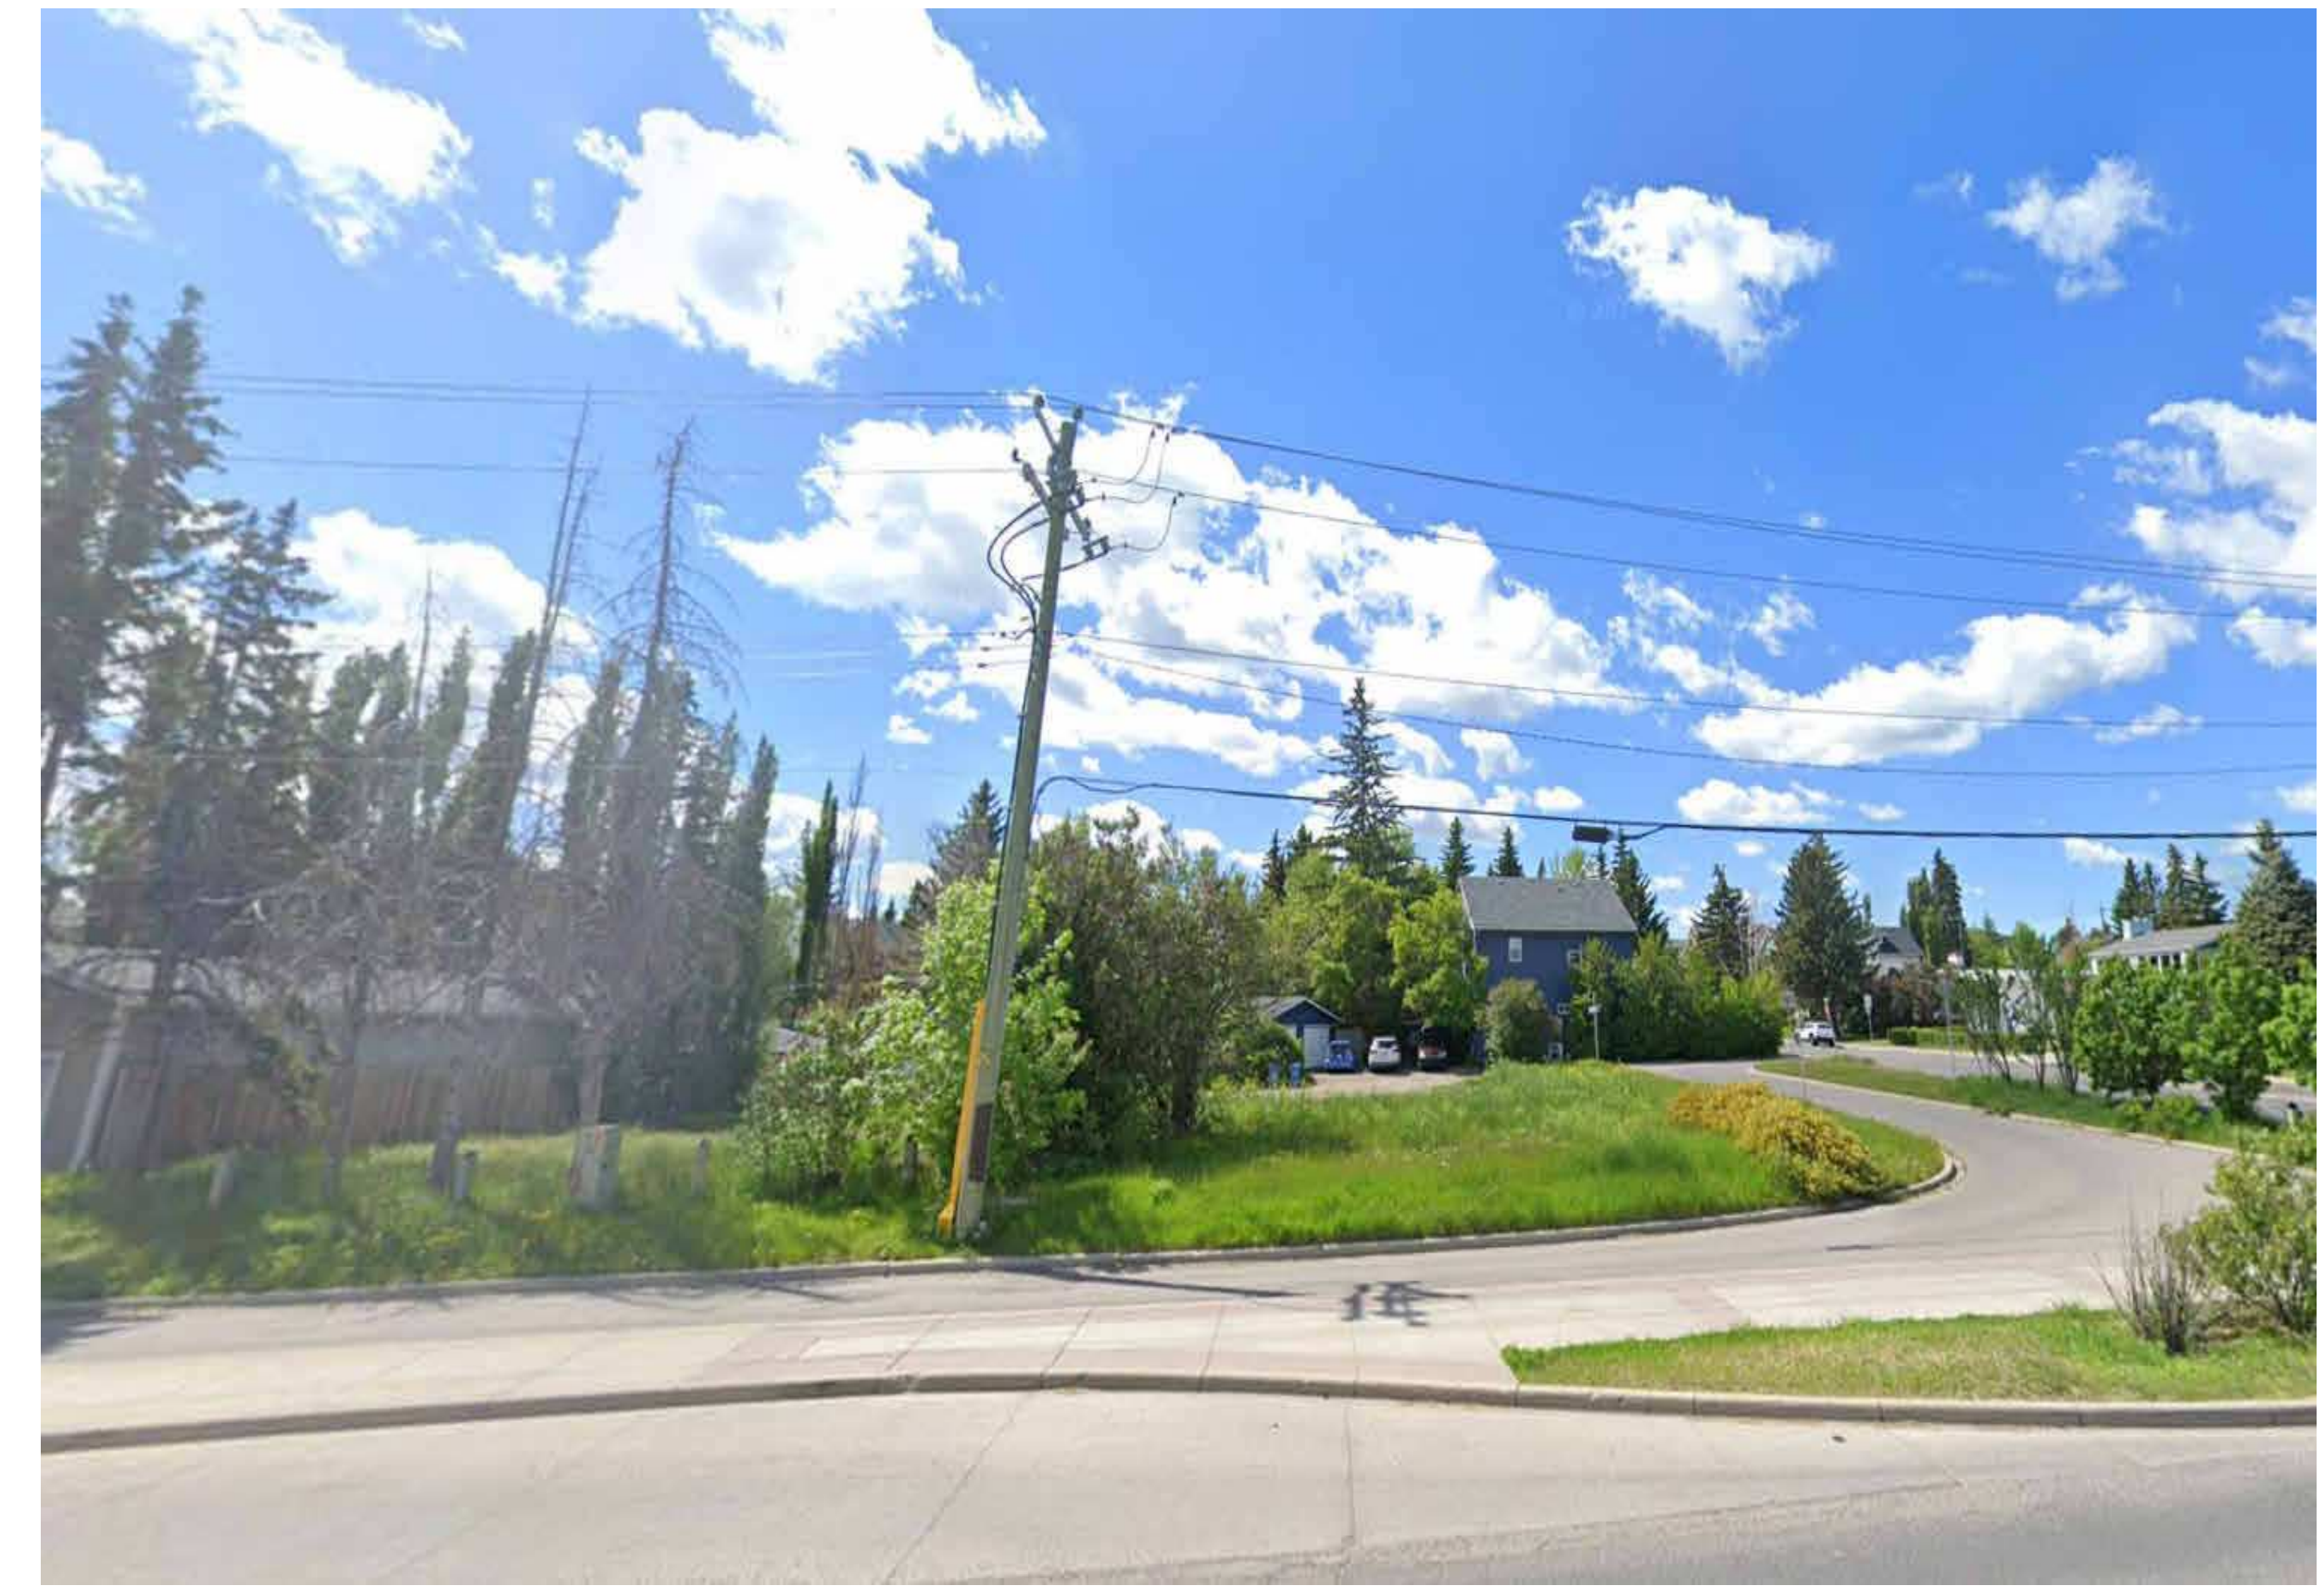

S3 - SITE PHOTO - VIEW FROM NORTH



S4 - SITE PHOTO - VIEW FROM NORTHWEST

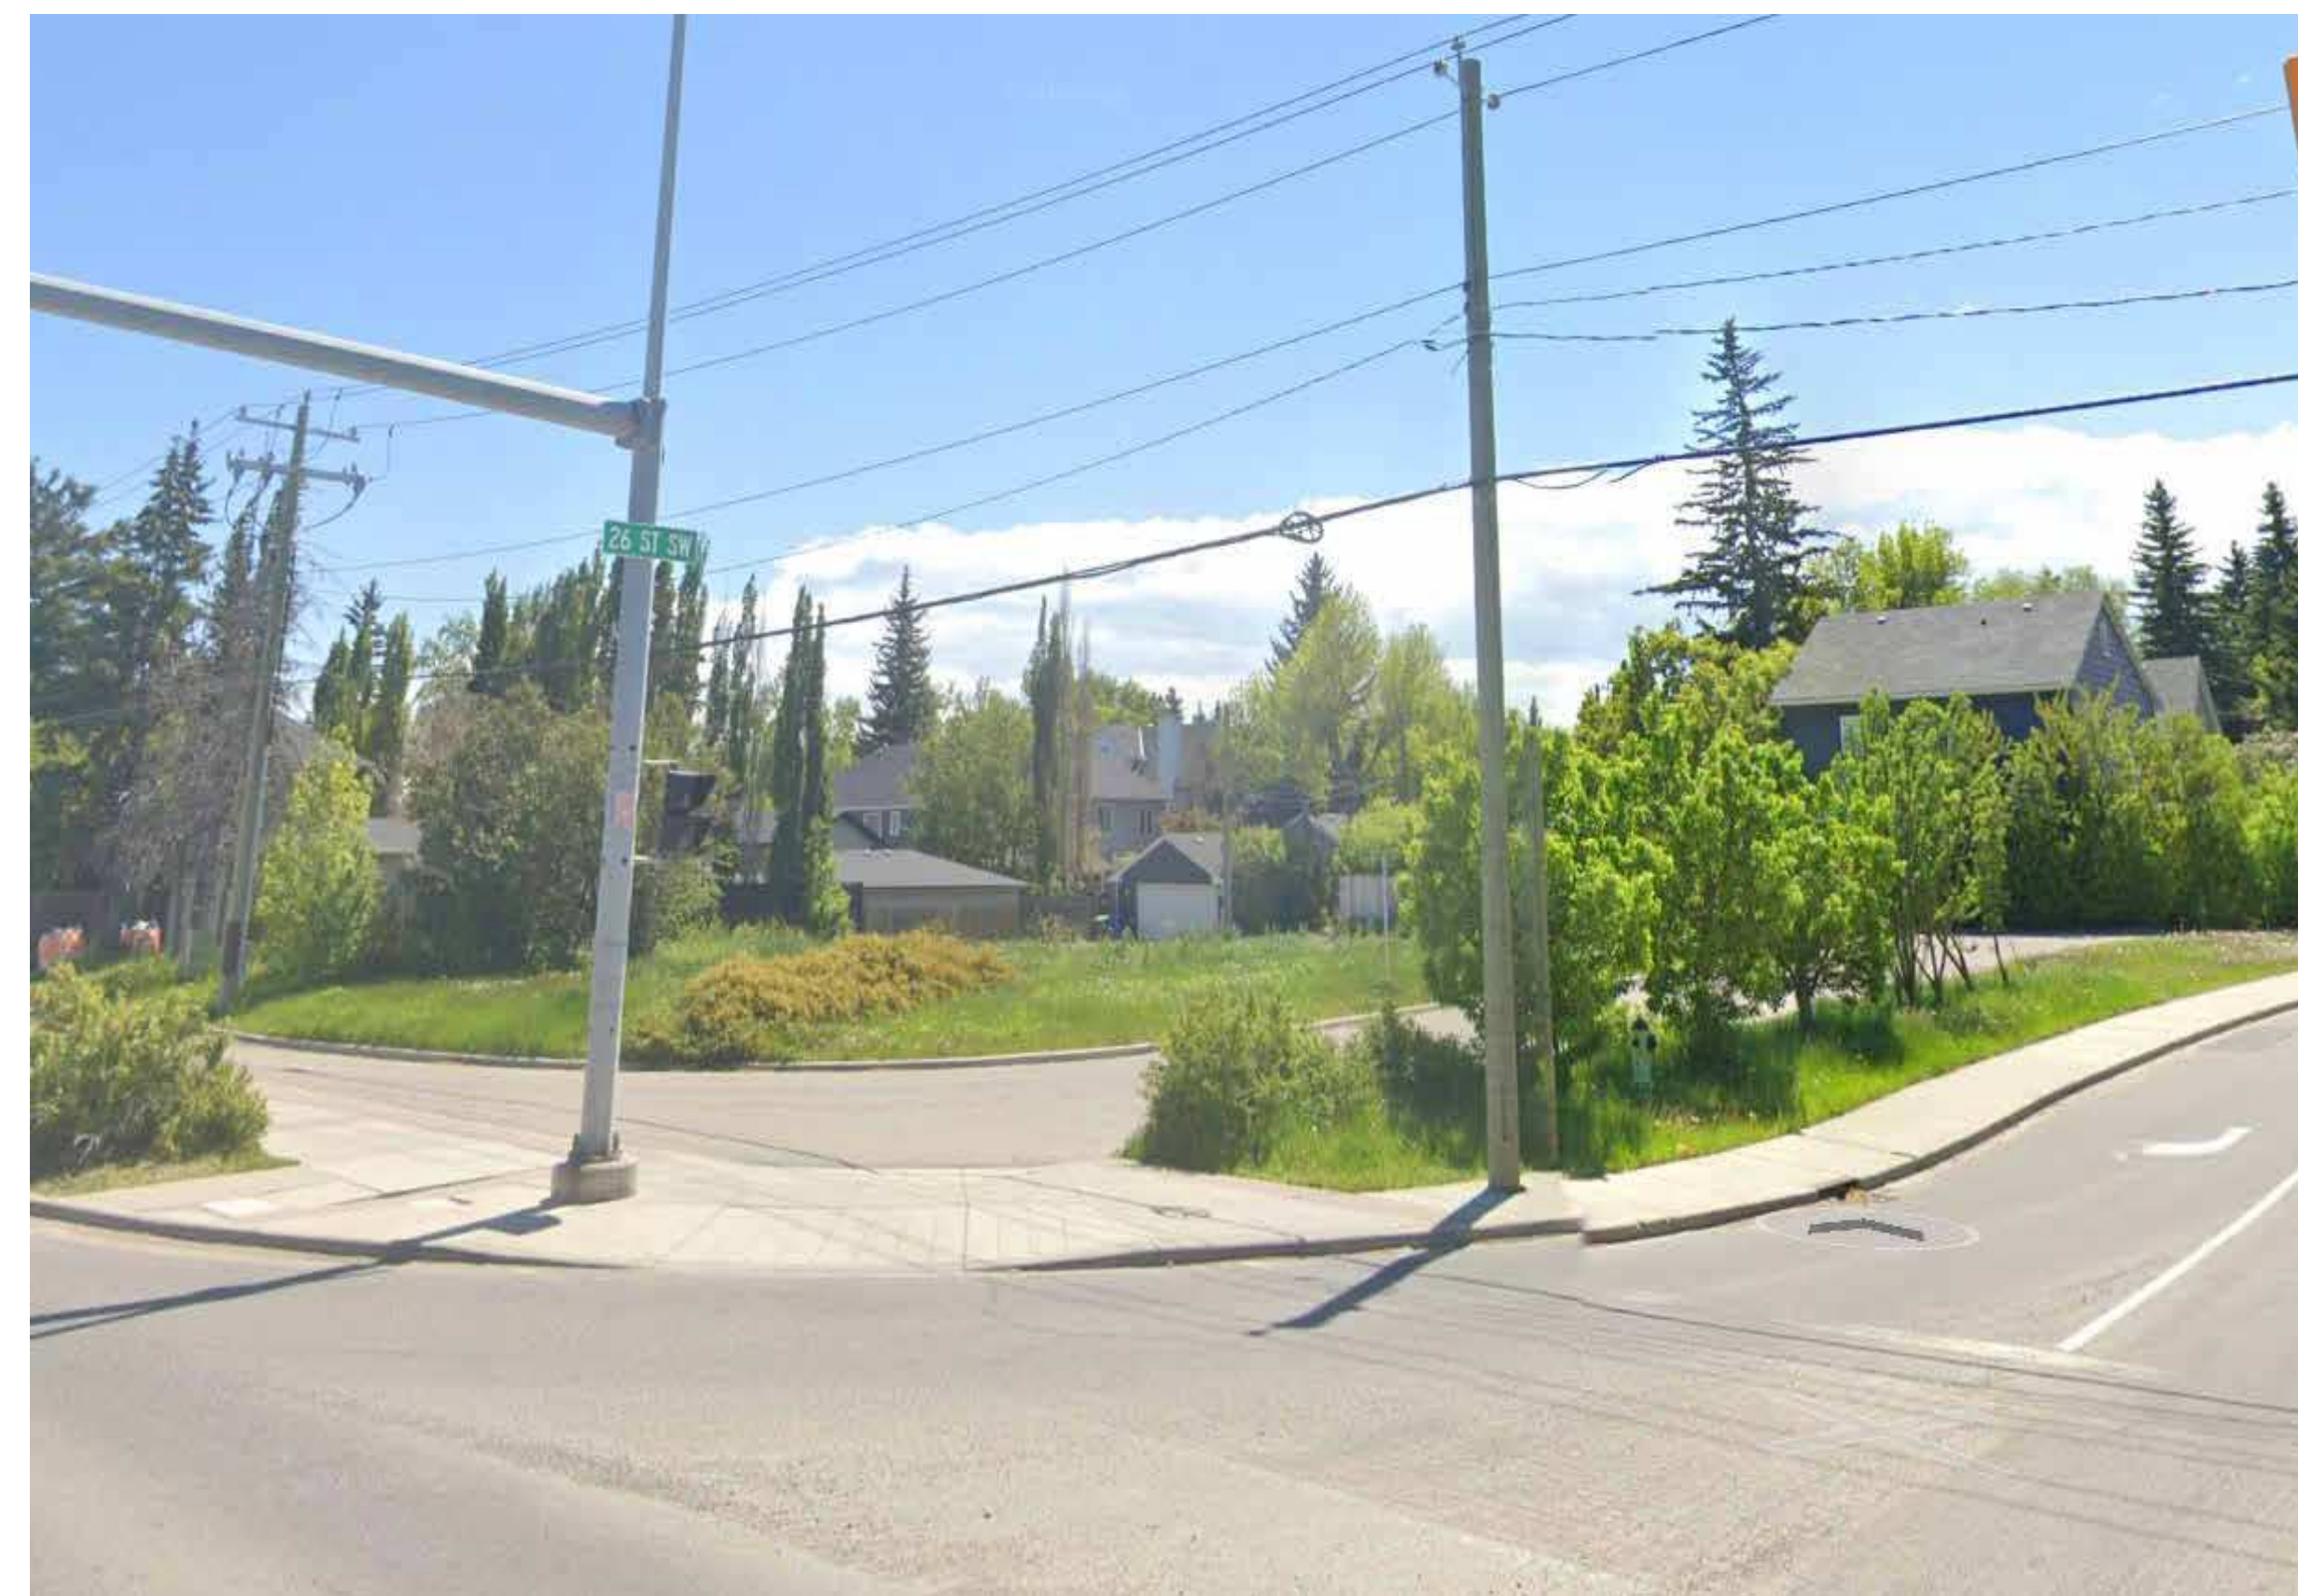

S5 - SITE PHOTO - VIEW FROM NORTHWEST




S6 - SITE PHOTO - VIEW FROM WEST




S7 - SITE PHOTO - VIEW FROM WEST



S8 - SITE PHOTO - VIEW FROM SOUTHWEST

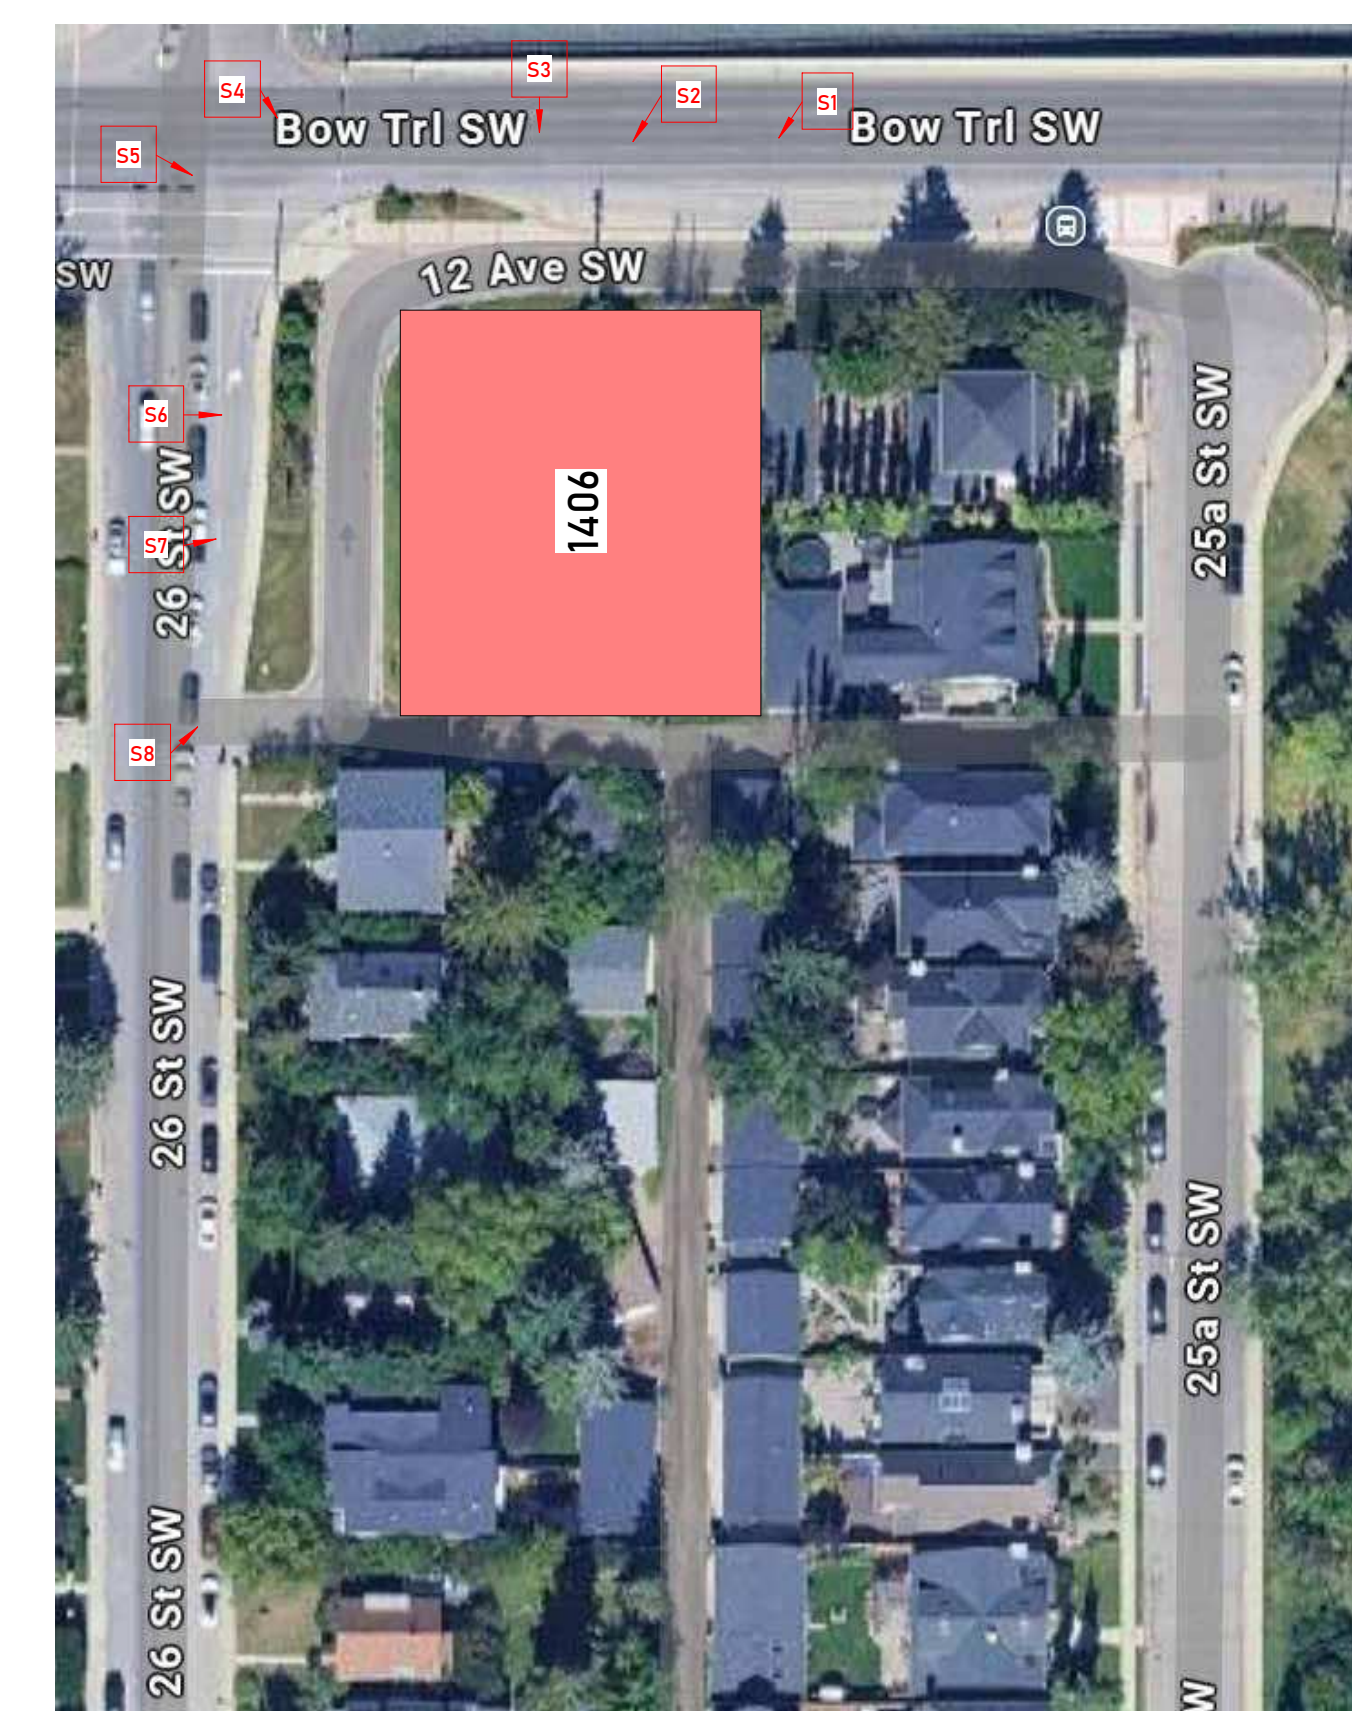

SITE PHOTO - KEY PLAN

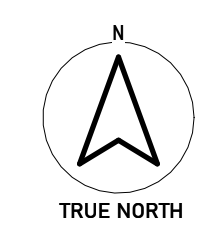

NOTES:
 - DIMENSION TO FACE OF STUD (INTERIOR PARTITIONS), CONCRETE, CONCRETE BLOCK, EXTERIOR WALL SHEATHING - UNLESS NOTED OTHERWISE
 - NOTE WHEN REQUIRED MINIMUM CLEAR DIMENSIONS WILL BE IDENTIFIED
 - VERIFY ALL DIMENSIONS, ELEVATIONS, AND DATUM; REPORT ANY ERRORS AND/OR DISCREPANCIES TO THE ARCHITECT PRIOR TO CONSTRUCTION
 - DO NOT SCALE DRAWINGS.
 - THIS DRAWING SUPERCEDES PREVIOUS ISSUES.

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| Project Component |
| Key Plan |


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| Seal(s) |
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| DATE | ISSUED FOR | REV |
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| Client | |
| | |
| Project | |
| ONWARD SHAGANAPPI | |
| 1406 26 Street SW, Calgary, AB T3C 1K3 | |
| Plan 2311009, Block 5, Lot 55 | |
| Drawing Title | |
| SITE PHOTOS | |
| Project Manager | Drawn |
| Project Leader | Author |
| | Checked |
| | Checker |
| Scale | 1 : 10 |
| Project No. | |
| Drawing No. | DP00.01 |

PRELIMINARY - NOT FOR CONSTRUCTION

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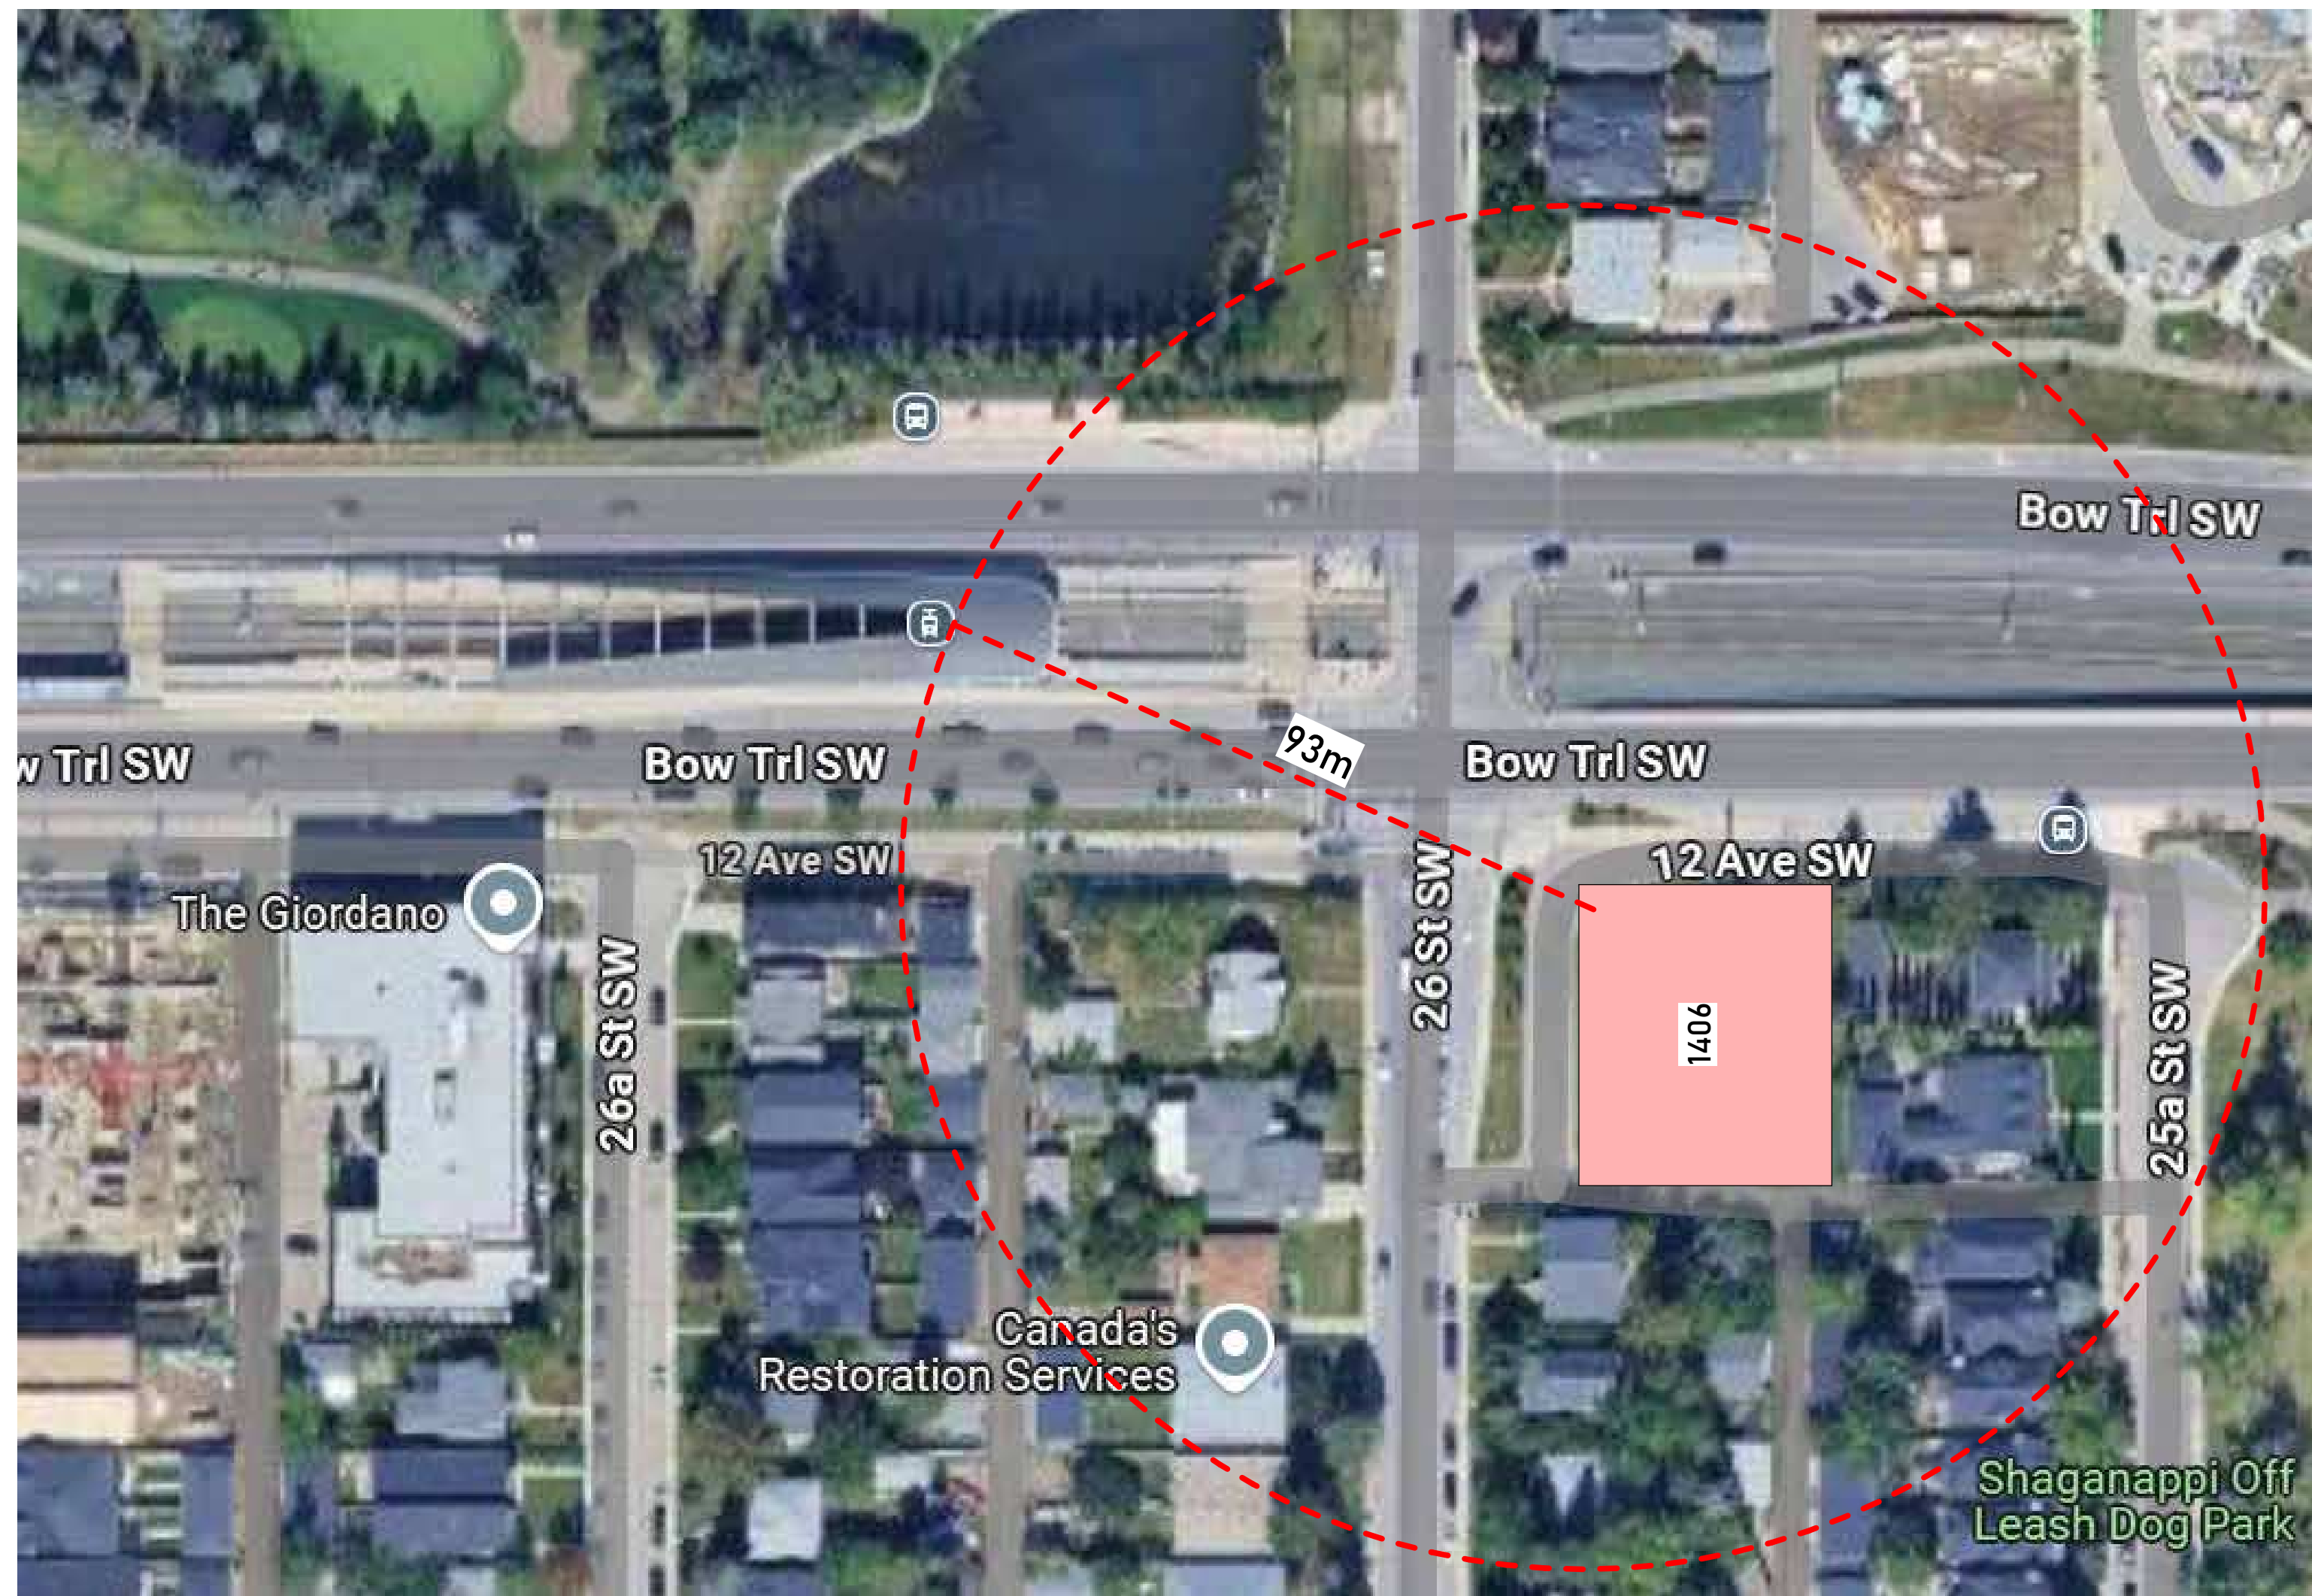
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| Project Component |
| Key Plan |

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| Seal(s) |
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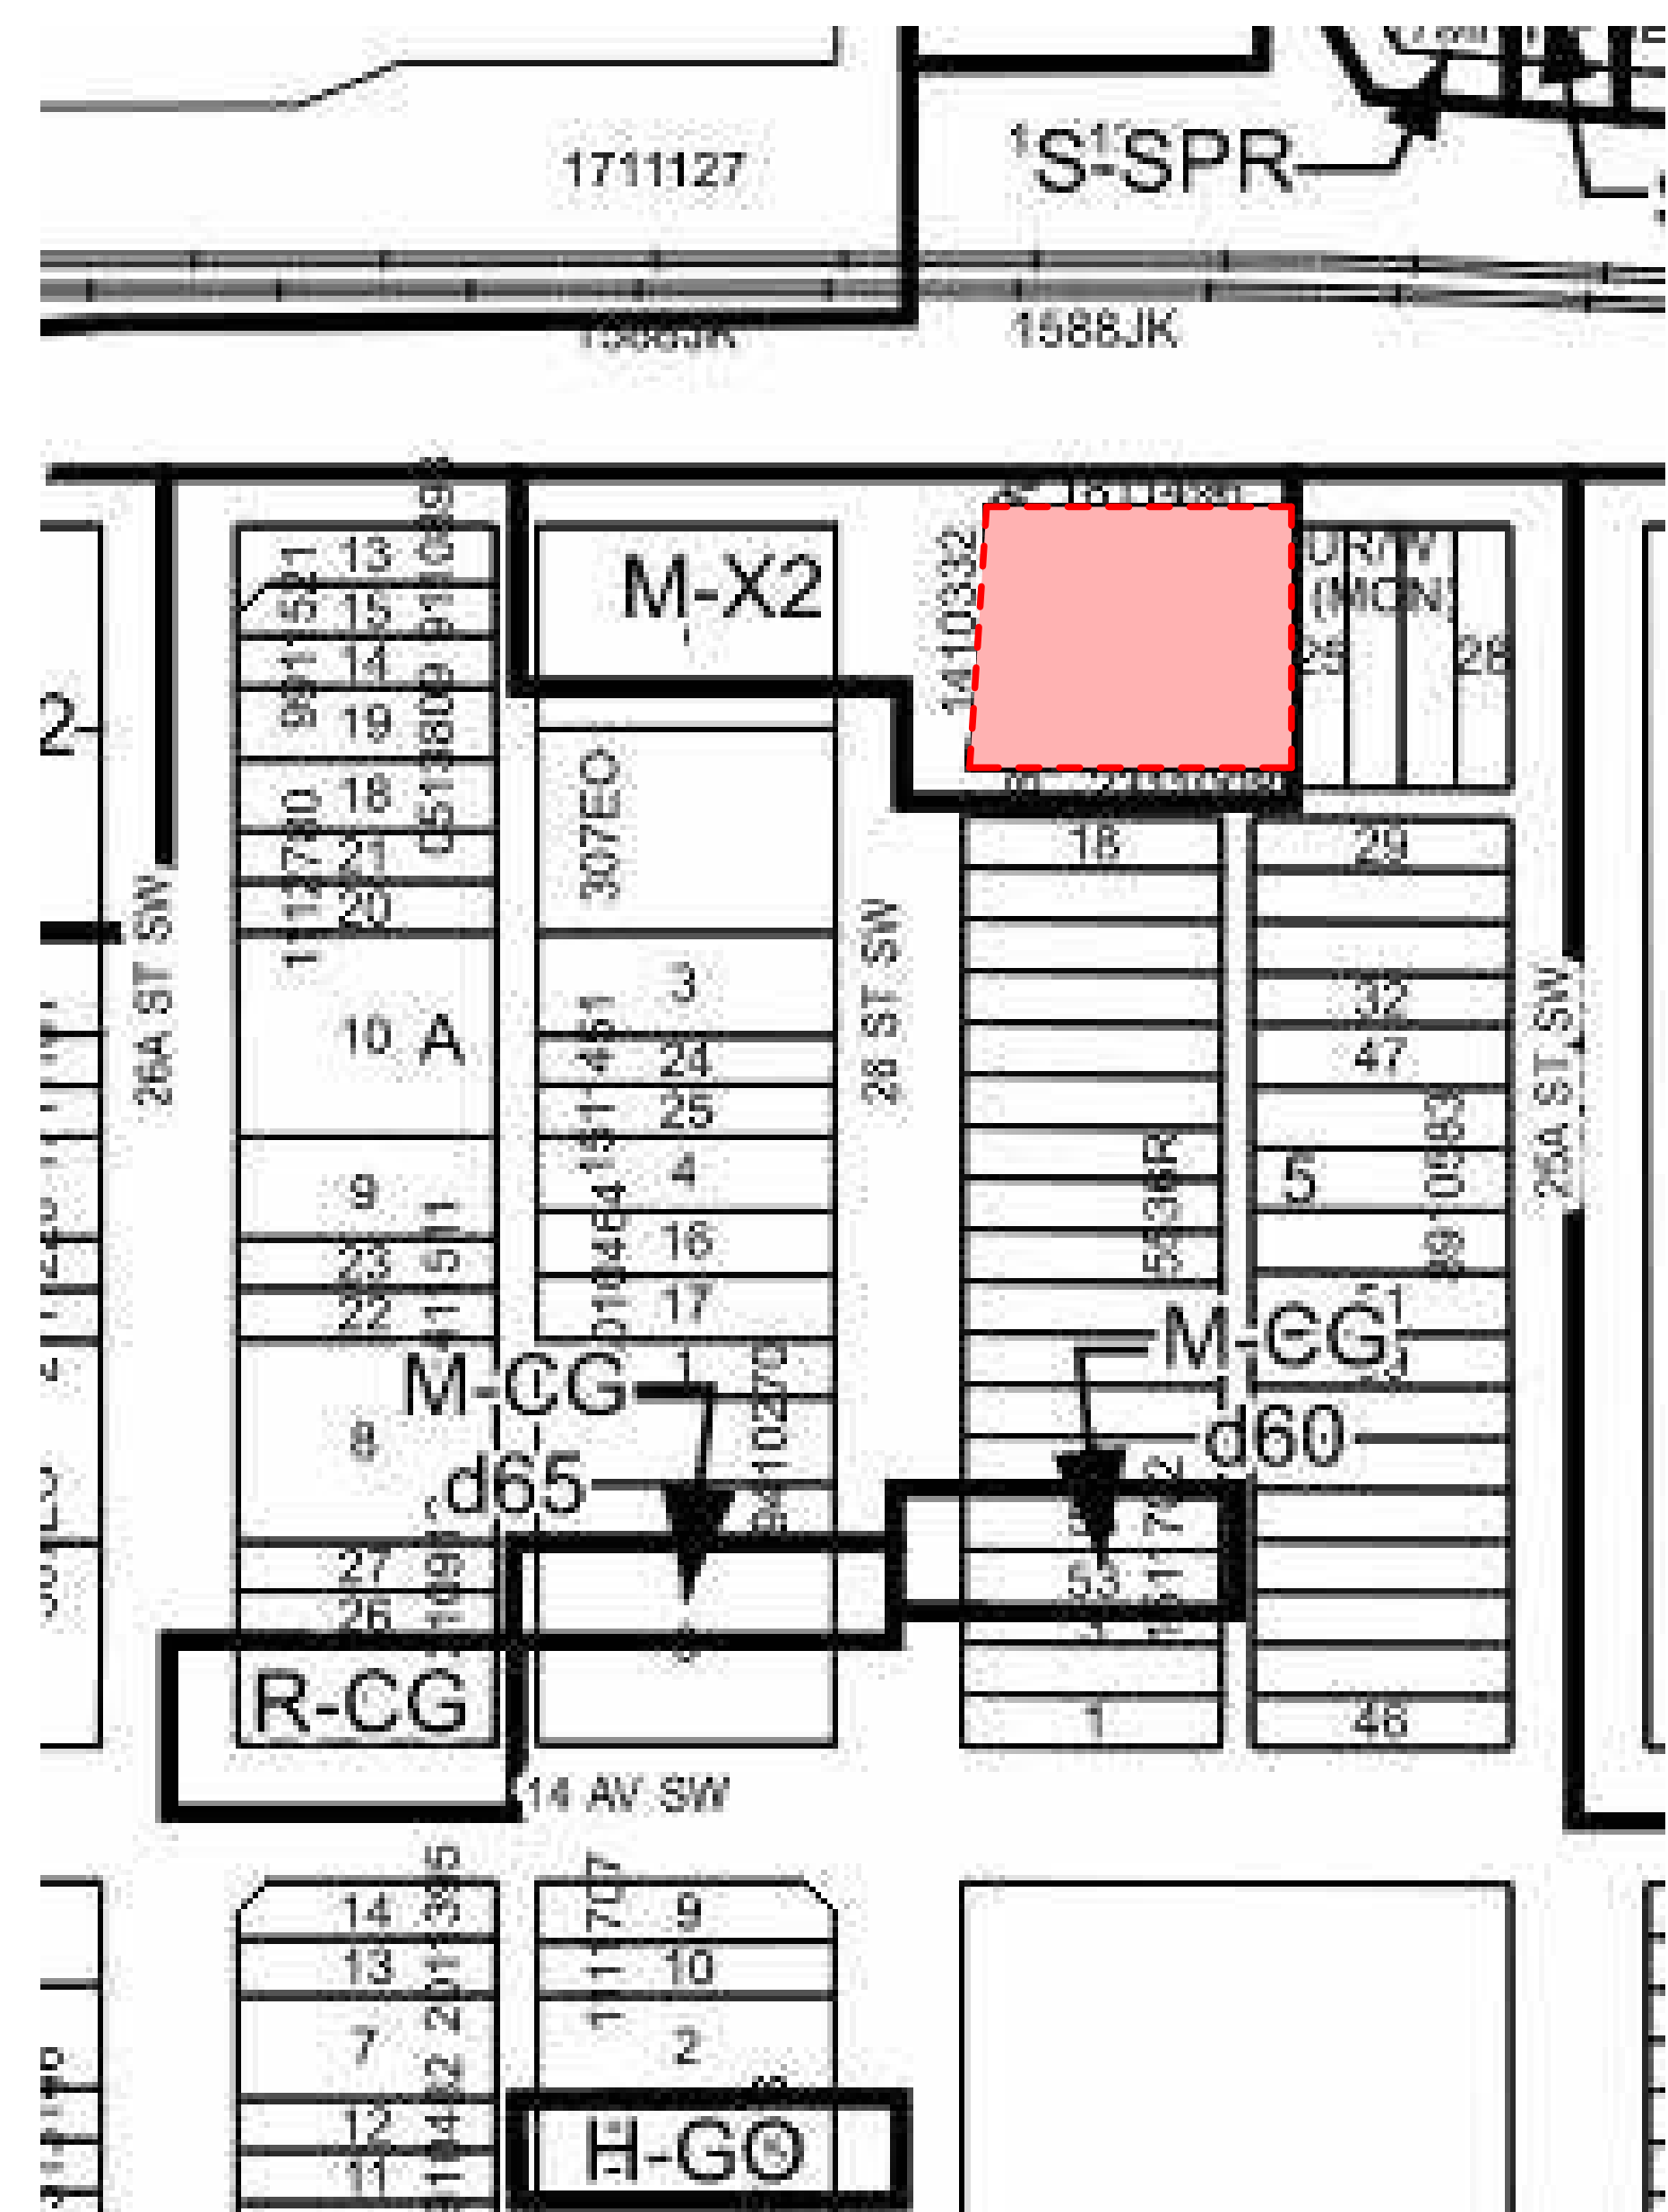
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| Client | |
| Project ONWARD SHAGANAPPI | |
| 1406 26 Street SW, Calgary, AB T3C 1K3 | |
| Plan 2311009, Block 5, Lot 55 | |
| Drawing Title SITE SURVEY | |
| Project Manager | Drawn |
| Project Leader | Author |
| Scale | Checked |
| Project No. | Checker |
| Drawing No. | |
| | DP01.01 |


PRELIMINARY - NOT FOR CONSTRUCTION

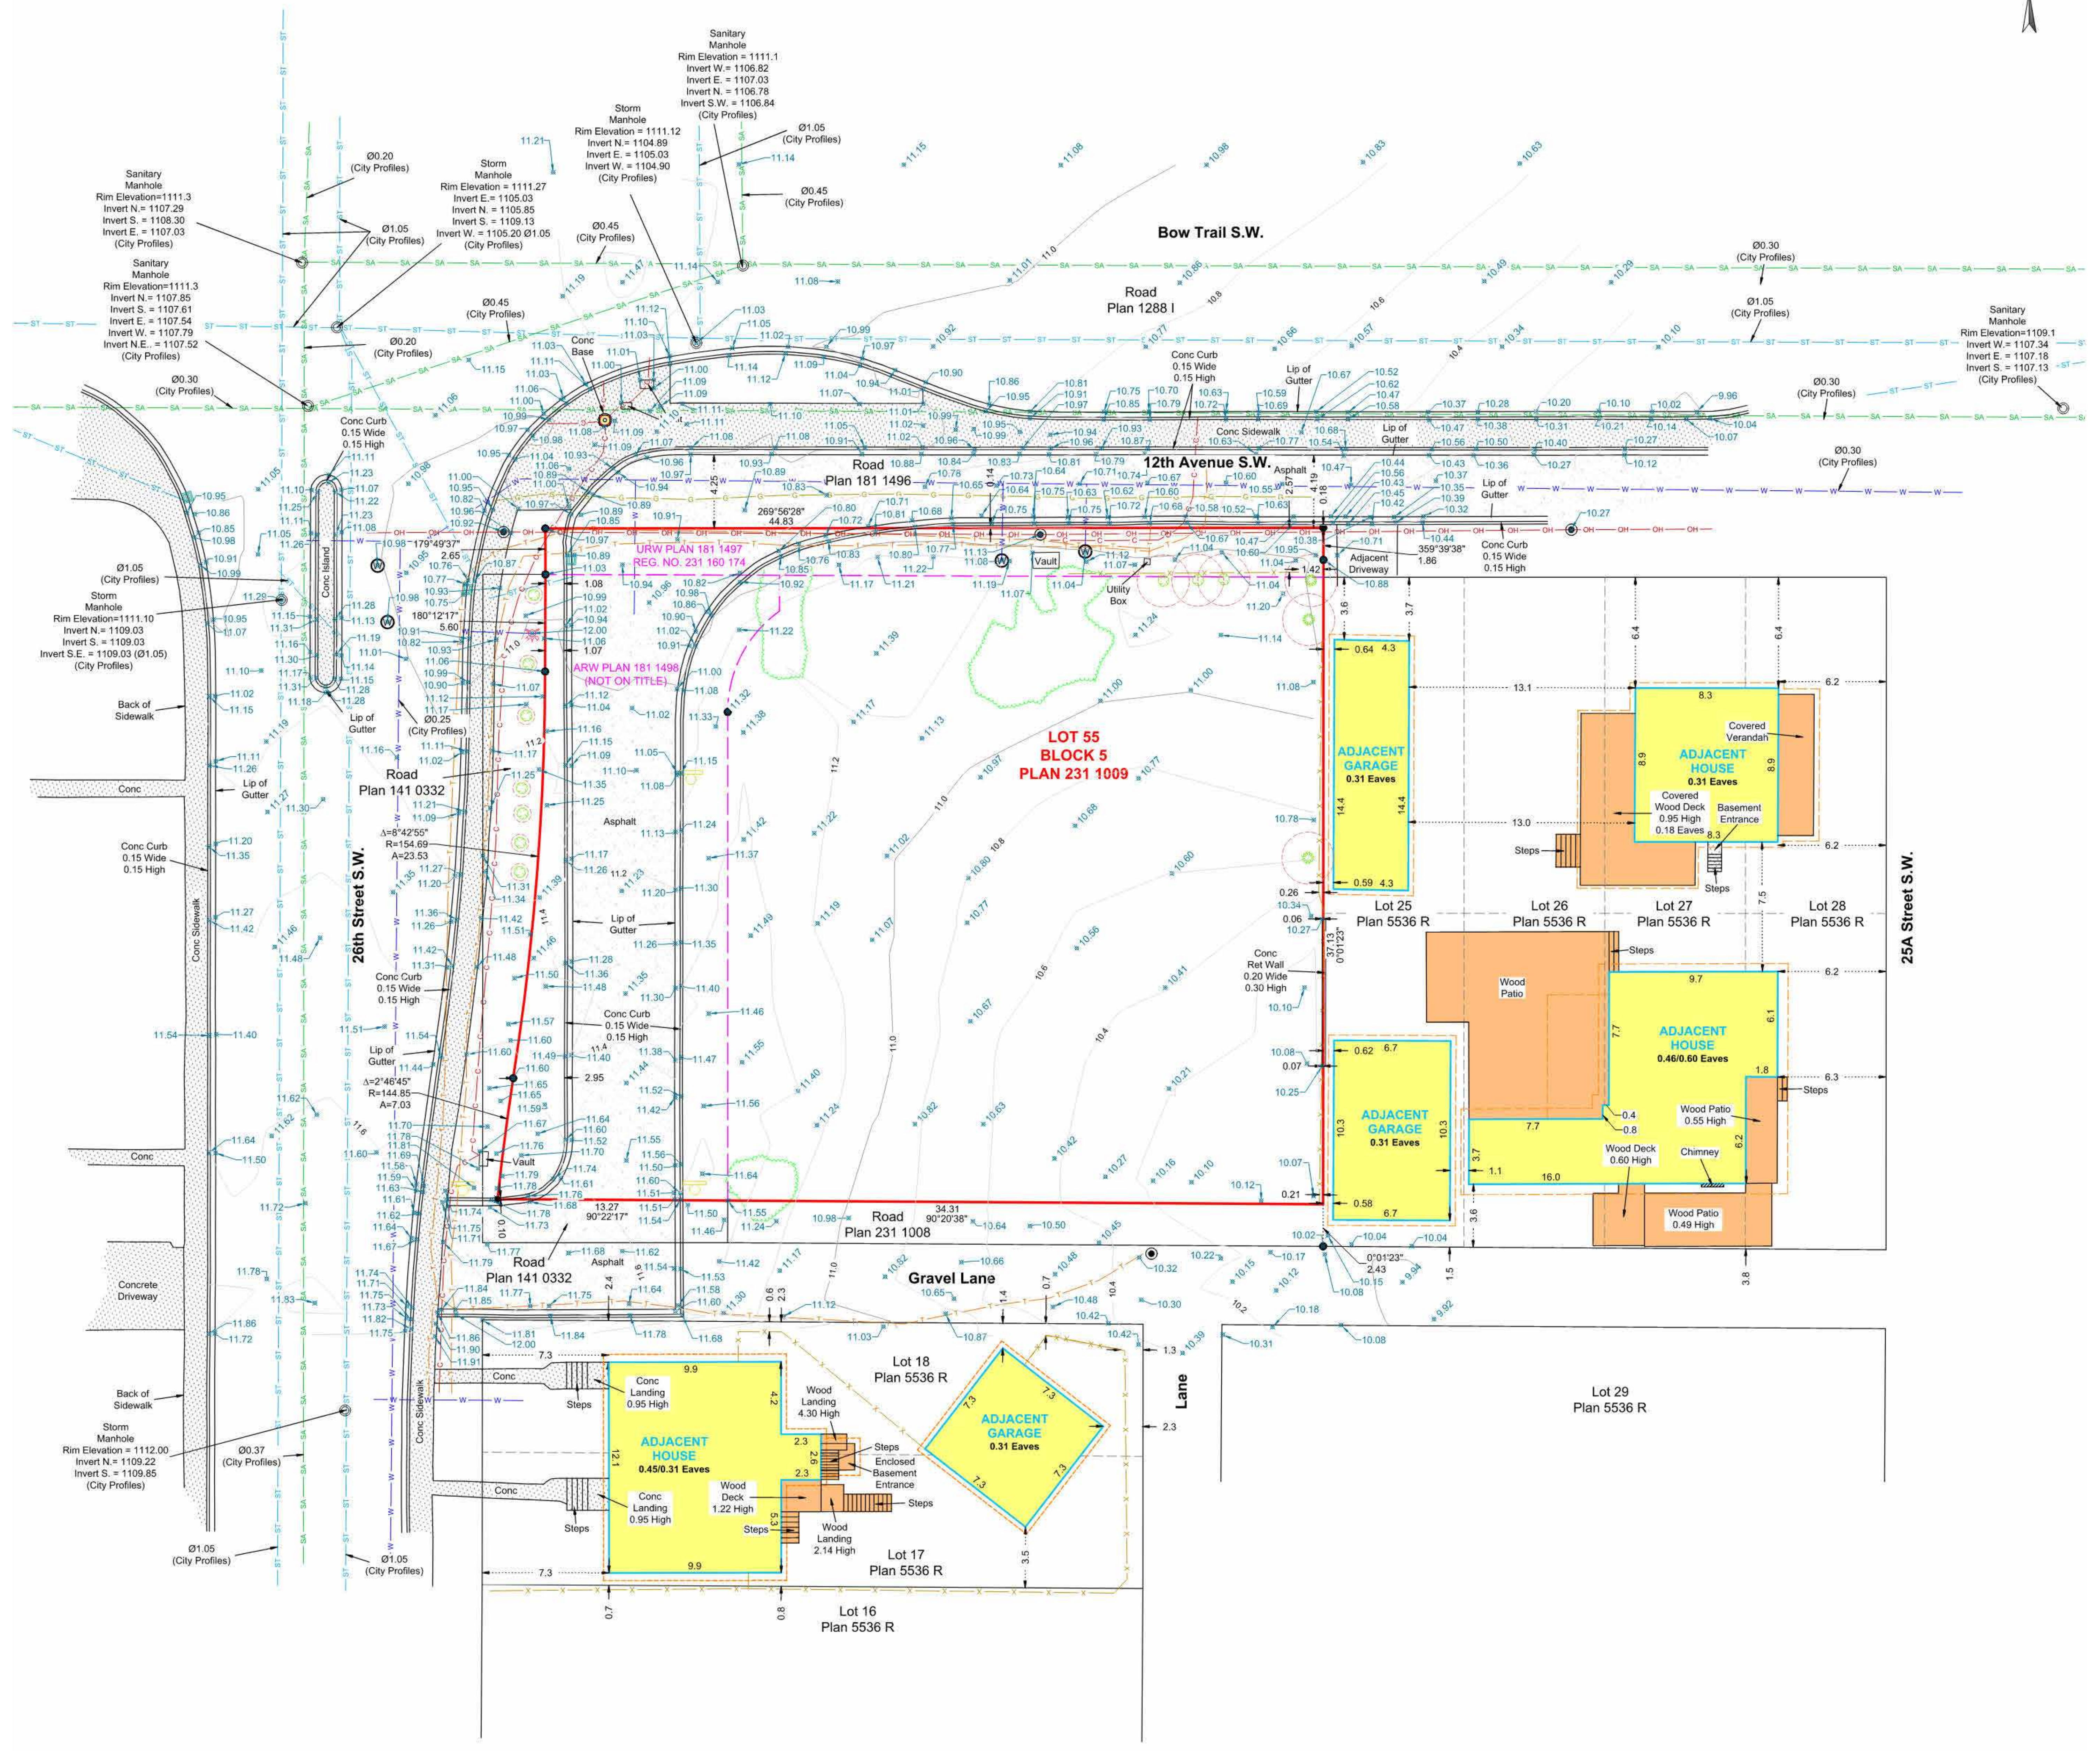

1 CONTEXT PLAN
 TRUE NORTH PROJECT NORTH SCALE: 1:10



2 VICINITY PLAN
 TRUE NORTH PROJECT NORTH SCALE: 1:10

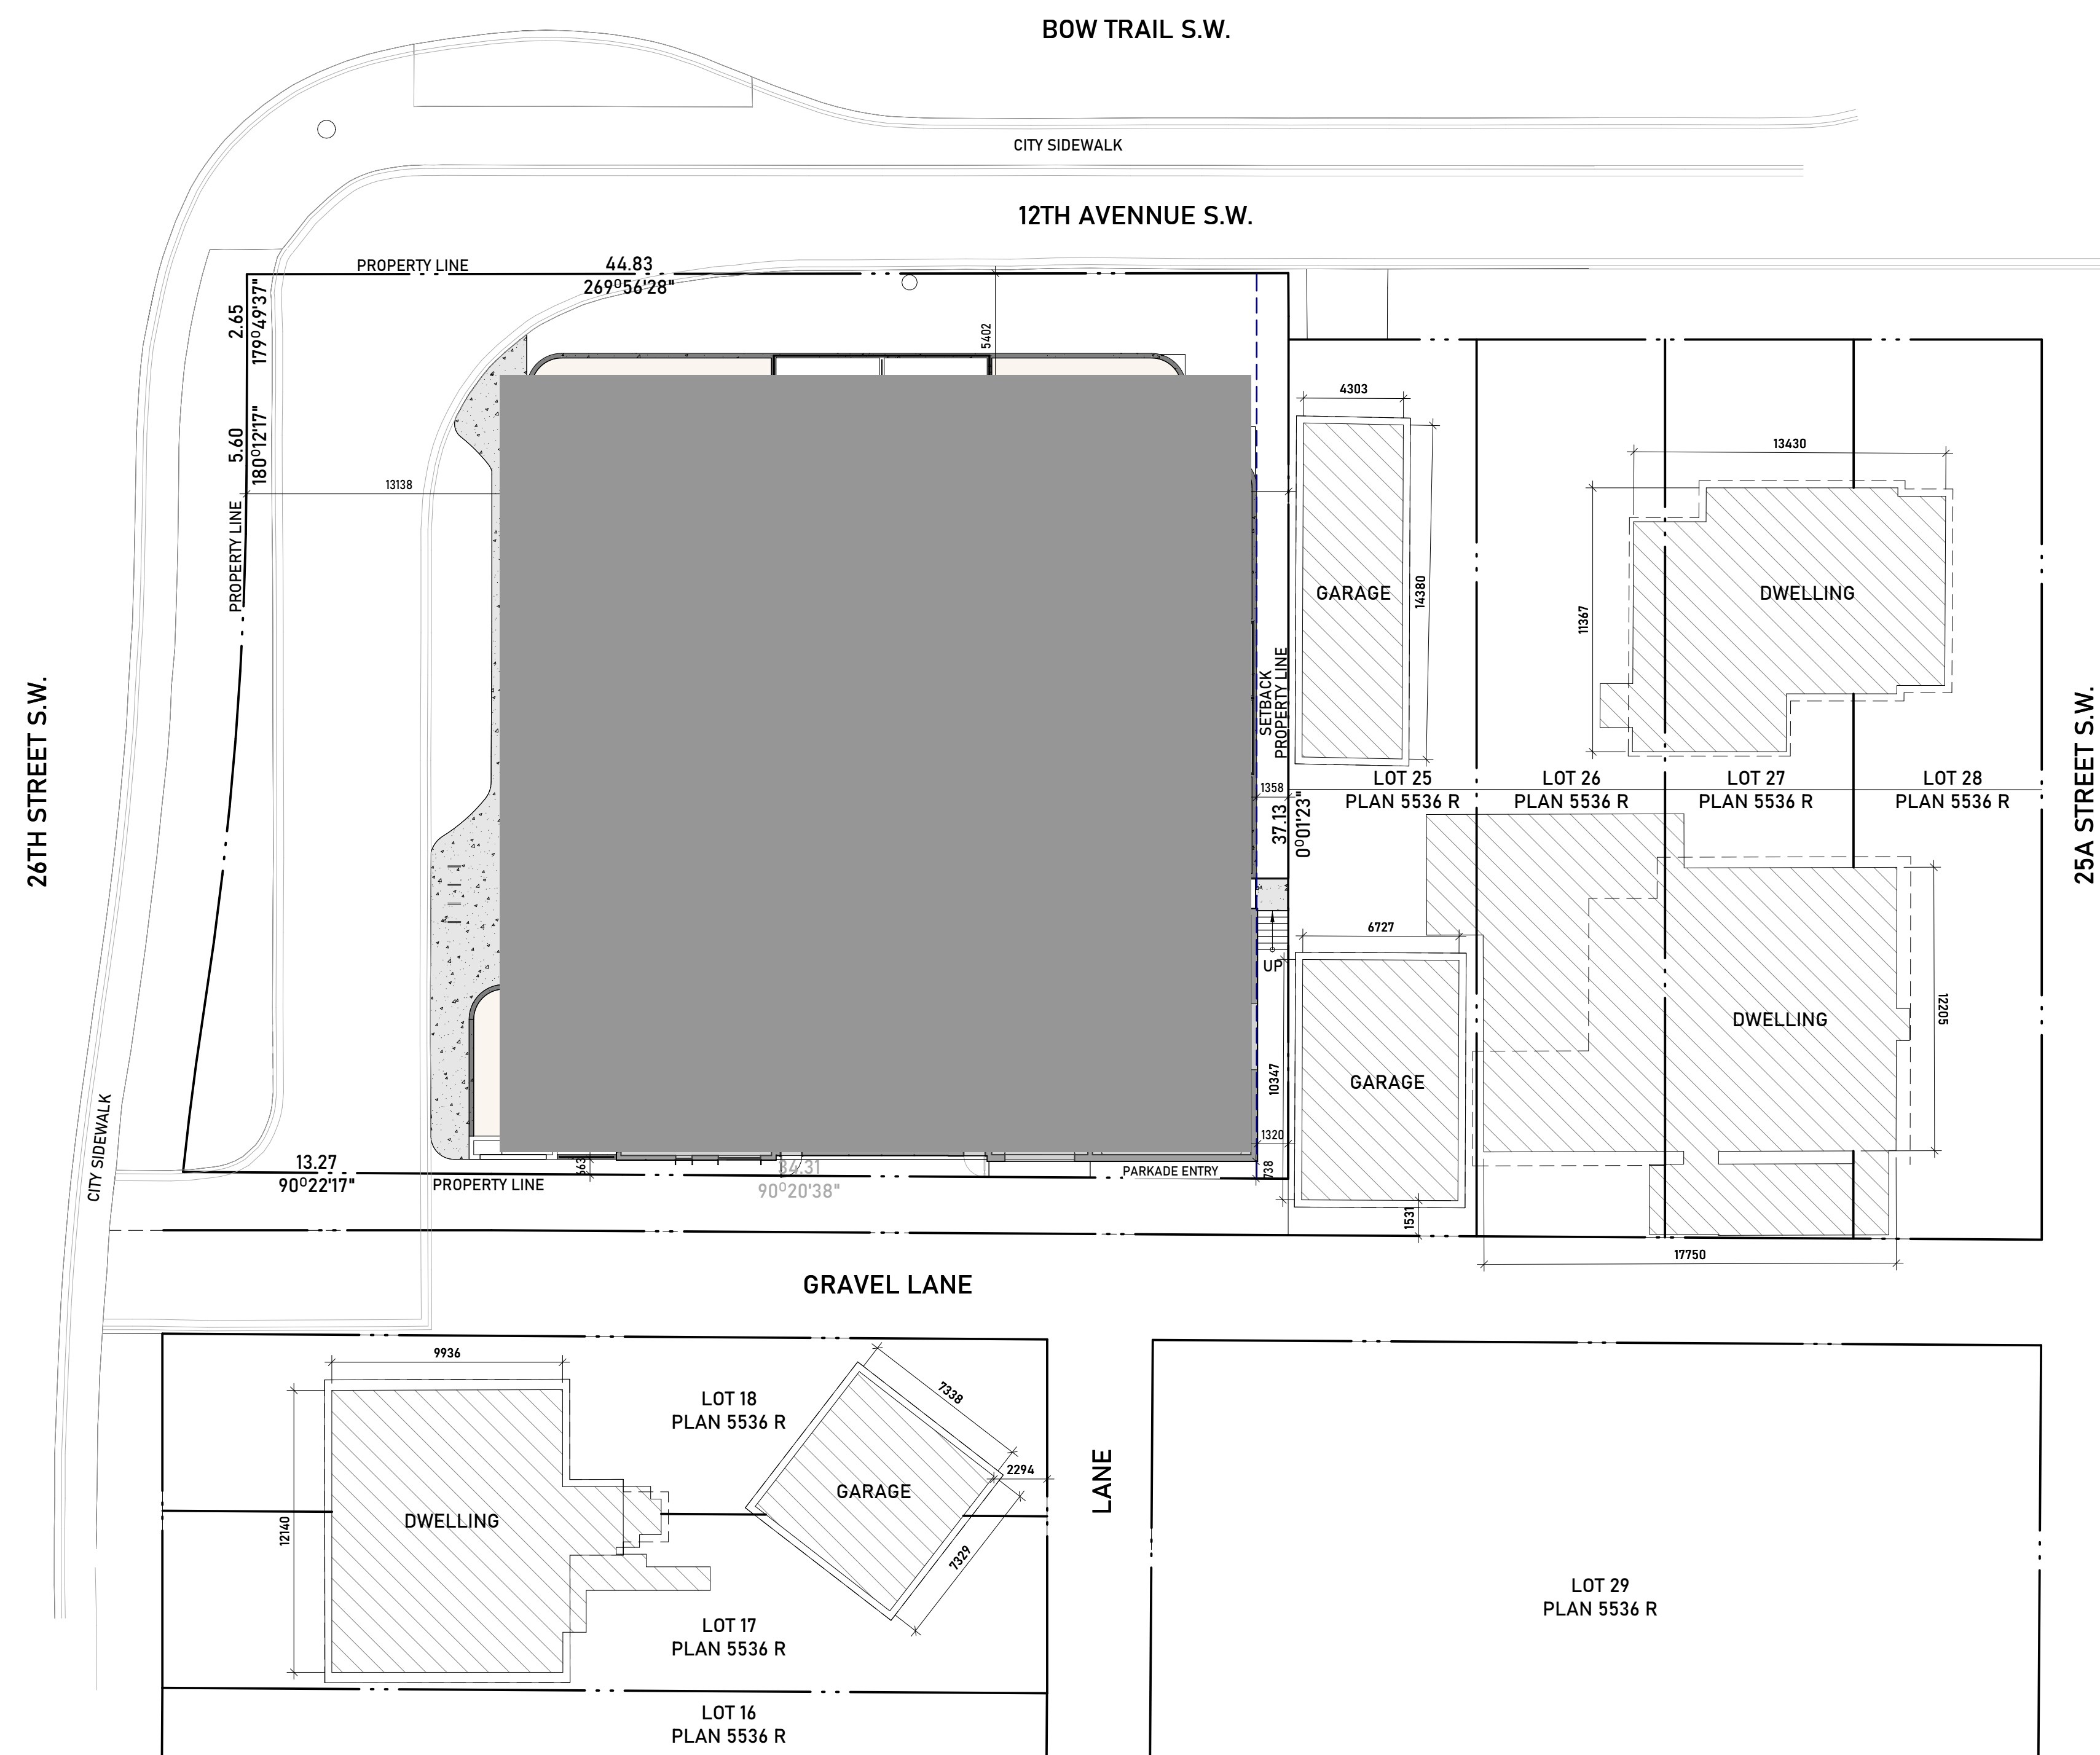

3 BLOCK PLAN
 TRUE NORTH PROJECT NORTH SCALE: 1:200

NOTES:
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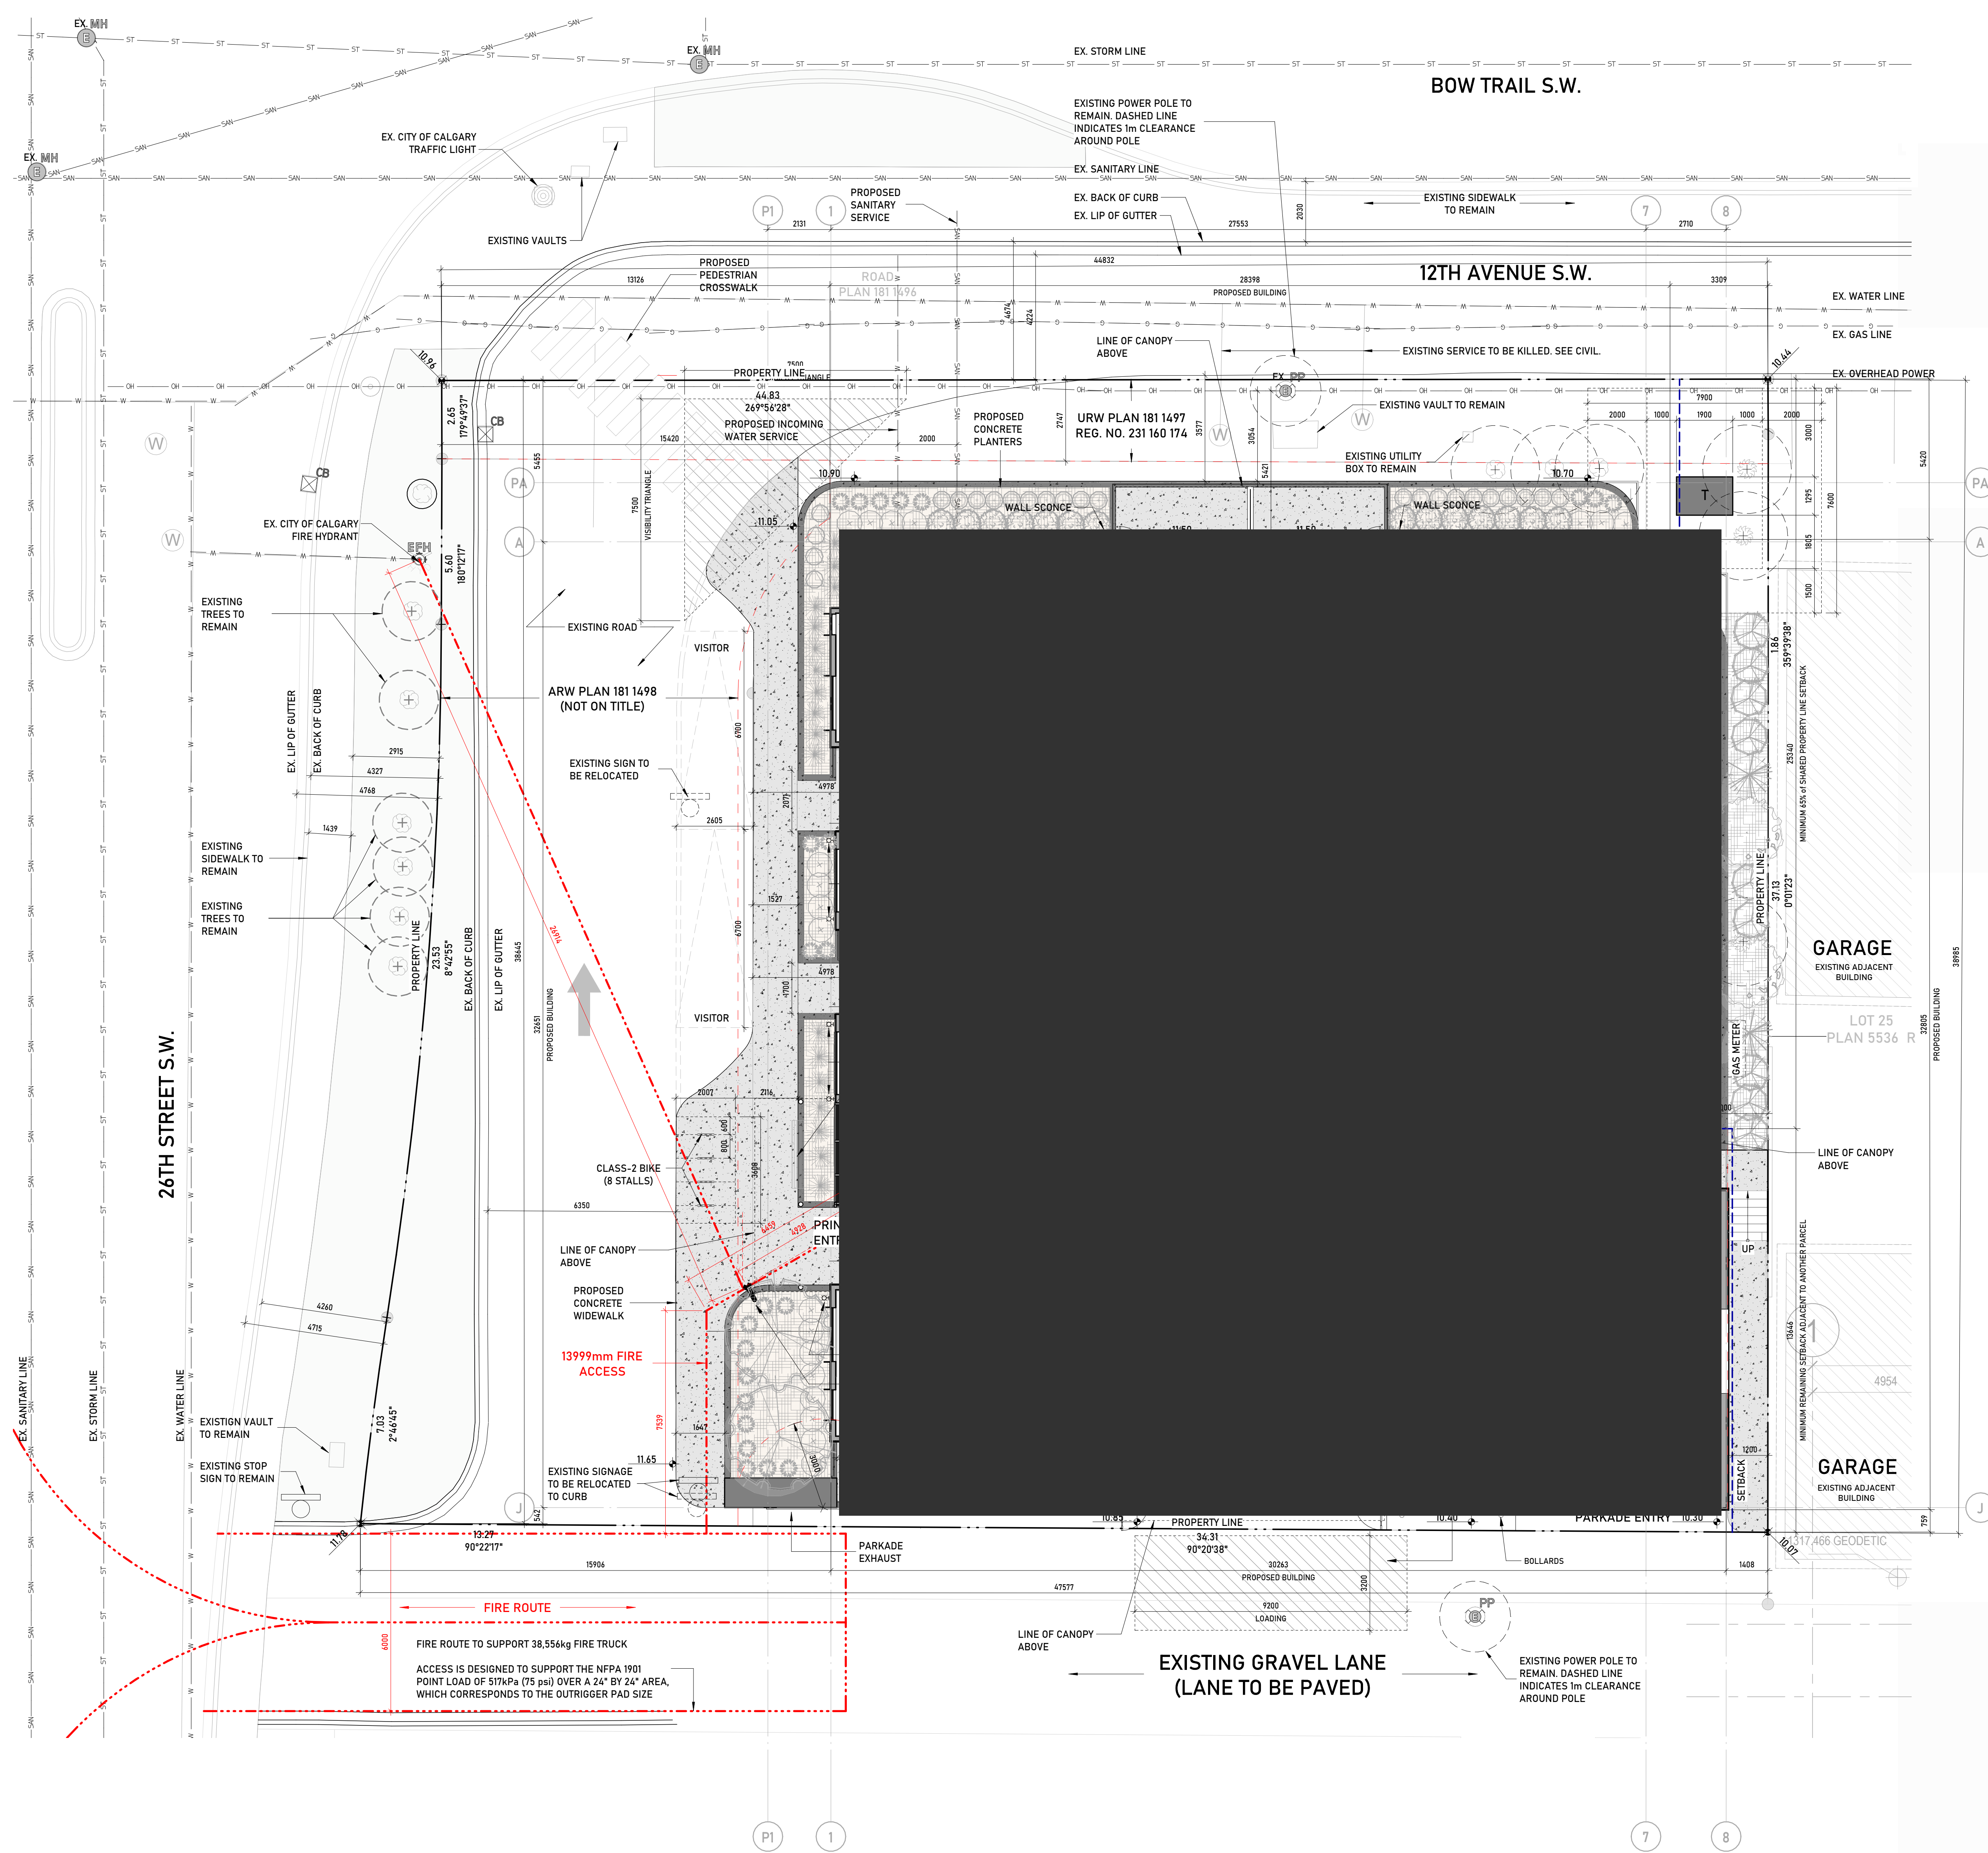
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| Project Component |
| Key Plan |
| Seal(s) |

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| Client | |
| Project | |
| ONWARD SHAGANAPPI | |
| 1406 26 Street SW, Calgary, AB T3C 1K3 | |
| Plan 2311009, Block 5, Lot 55 | |
| Drawing Title | |
| BLOCK PLAN, CONTEXT PLAN, LAND USE MAP | |
| Project Manager | Drawn |
| Project Leader | Author |
| Scale | Checked |
| Project No. | Checker |
| Drawing No. | As indicated |
| | DP01.02 |

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SITE PLAN LEGEND

- CONCRETE, WALKING SURFACE
- CONCRETE, DRIVING SURFACE
- LANDSCAPED AREA; REFER TO LANDSCAPING FOR FURTHER INFORMATION
- EXISTING TREES / BUSHES TO REMAIN
- EXISTING TREES / BUSHES TO BE REMOVED
- PROPOSED PLANTING; REFER TO LANDSCAPING FOR FURTHER INFORMATION
- TRANSFORMER
- PROPERTY LINE
- SETBACK LINE
- LINE OF EXISTING SHORING
- ENMAX CLEARANCES
- PROPOSED FENCELINE
- EXISTING FENCELINE
- PROPOSED BUILDING GRADES
- EXISTING WATER
- EXISTING SANITARY
- EXISTING STORM
- EXISTING GAS
- EXISTING UNDERGROUND POWER
- EXISTING OVERHEAD POWER

GENERAL NOTES

1. SITE CONFIRM ALL DIMENSIONS
2. ALL EXISTING BOULEVARD TREES TO REMAIN
3. ALL EXISTING POLES AND GUY WIRES TO REMAIN
4. ALL ELEMENTS ARE PROPOSED UNLESS NOTED OTHERWISE

| Project Information | | | | | | |
|-----------------------------|------------------------------------|---------|---------------------|--------------|-------|--------|
| Municipal Address | 1406 26 St SW, Calgary, AB T3C 1K3 | | | | | |
| Legal Address | Plan 2311009, Block 5, Lot 55 | | | | | |
| Total Parcel Area | sm | 1771.95 | Ac | 0.44 | Ha | 0.18 |
| Land Use District | DC 148D2025 / MU-1 | | | | | |
| Maximum F.A.R. | 3.0 | | Proposed F.A.R. | | | 2.41 |
| Maximum Building Height (m) | 20.0 | | Building Height (m) | | | 17.995 |
| Discretionary Use | Dwelling Units | | | | | |
| Parcel Dimensions (approx.) | Meters (L x W) | 44 | 39 | Feet (L x W) | 144.4 | 128.0 |

| Building Statistics | | | | | | |
|------------------------------|----------------|-----------------|--------------------|-----------|-----------|----------|
| Level | GFA | | Units | | | |
| | sm | sf | Studio | 1B | 2B | 3B |
| 1 | 891.4 | 9,594.9 | 0 | 6 | 2 | 1 |
| 2 | 860.1 | 9,258.0 | 0 | 10 | 2 | 2 |
| 3 | 860.1 | 9,258.0 | 0 | 10 | 2 | 2 |
| 4 | 860.1 | 9,258.0 | 0 | 10 | 2 | 2 |
| 5 | 801.5 | 8,627.3 | 0 | 10 | 1 | 2 |
| Total GFA | 4,273.2 | 45,996.3 | Totals | 0 | 46 | 9 |
| Allowable GFA | 5,315.8 | 57,219.2 | Grand Total | 64 | | |
| Below Grade Area | | | Unit Mix | 0% | 72% | 14% |
| PL01 | 1,112.6 | 11,975.9 | Units / Ha | 361 | | |
| Barrier Free Units Provided | | | | 0 | 16 | 0 |
| Percentage of Units Provided | | | | 25% | | |

| Amenity Space Calculations | | | |
|---|---------------------|--------------------------------|------------------------|
| Amenity Space Required (sm) | | Amenity Required per unit (sm) | |
| 320 | | 5 | |
| Level | Amenity Space (sm) | Common Amenity Space | Total Amenity Provided |
| 1 | Private Patio: 68.7 | N/A | 0 |
| 2 | Private Balc.: 39.5 | N/A | 0 |
| 3 | Private Balc.: 39.5 | N/A | 0 |
| 4 | Private Balc.: 39.5 | N/A | 0 |
| 5 | Private Balc.: 33.4 | Outdoor Space | 60.5 |
| Totals | 220.6 | Totals | 60.5 |
| Amenity Space Utilized to Meet By-Law* | | 180 | 240.5 |
| | | Surplus / Deficiency | -79.5 |

Notes: *Maximum 5sm of private amenity / unit allocated to achieve by-law requirements.

| By-Law Requirements and Provisions | | | |
|-------------------------------------|----------------------------|--------------|----------|
| Motor Vehicle Parking Requirements | | | |
| Type | Per Unit | Per Building | Total |
| Resident* | 0.25 | 16 | 16 |
| Visitor | 0 | 0 | 0 |
| Loading Stall | N/A | 1 | 1 |
| Barrier Free Stalls Required | 11-25 = 2 BF Stalls | | 2 |
| Motor Vehicle Provided | | | |
| Surface | 0.03 | 2 | 27 |
| Underground | 0.4 | 25 | 27 |
| Resident | 0.4 | 24 | 27 |
| Visitor | 0.05 | 3 | 3 |
| Loading Stall | 1 | | 1 |
| Barrier Free Stalls Included | 26-50 = 3 BF Stalls | | 3 |

| Bicycle Parking Requirement | | | |
|-----------------------------|----------|--------------|-------|
| Class | Per Unit | Per Building | Total |
| Class 1 | 1 | 64 | 71 |
| Class 2 | 0.1 | 7 | 7 |
| Bicycle Parking Provided | | | |
| Class 1 | 1.0 | 65 | 73 |
| Class 2 | 0.1 | 8 | 8 |

| Garbage Collection | | |
|-----------------------|--|--------------|
| Volume per unit (yd3) | | Total volume |
| 0.3 | | 19.2 |

*The motor vehicle parking stall requirement is reduced to 0.25 stalls per Dwelling Unit for resident parking and 0.0 visitor parking stalls per unit where the following transportation demand measures are provided: provision of a bicycle repair facility; a minimum of 10 bicycle parking stalls - class 1 per unit; and a minimum of 50 per cent of the total bicycle parking stalls - class 1 provided are accessed directly from grade and provided in a horizontal format.

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| Project Component | |
| Key Plan | |


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| Seal(s) | |
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| Client | |
| Project | |
| ONWARD SHAGANAPPI | |
| 1406 26 Street SW, Calgary, AB T3C 1K3 | |
| Plan 2311009, Block 5, Lot 55 | |
| Drawing Title | |
| PROPOSED SITE PLAN, SITE STATISTICS, BYLAW REVIEW | |
| Project Manager | Drawn |
| - | Author |
| Project Leader | Checked |
| - | Checker |
| Scale | 1 : 100 |
| Project No. | - |
| Drawing No. | DP01.03 |


PRELIMINARY - NOT FOR CONSTRUCTION

- REVERSE
- FORWARD PHASE 1
- FORWARD PHASE 2




TRUE NORTH PROJECT NORTH
 SCALE: 1:150
VEHICLE SWEEP - SU9 LOADING

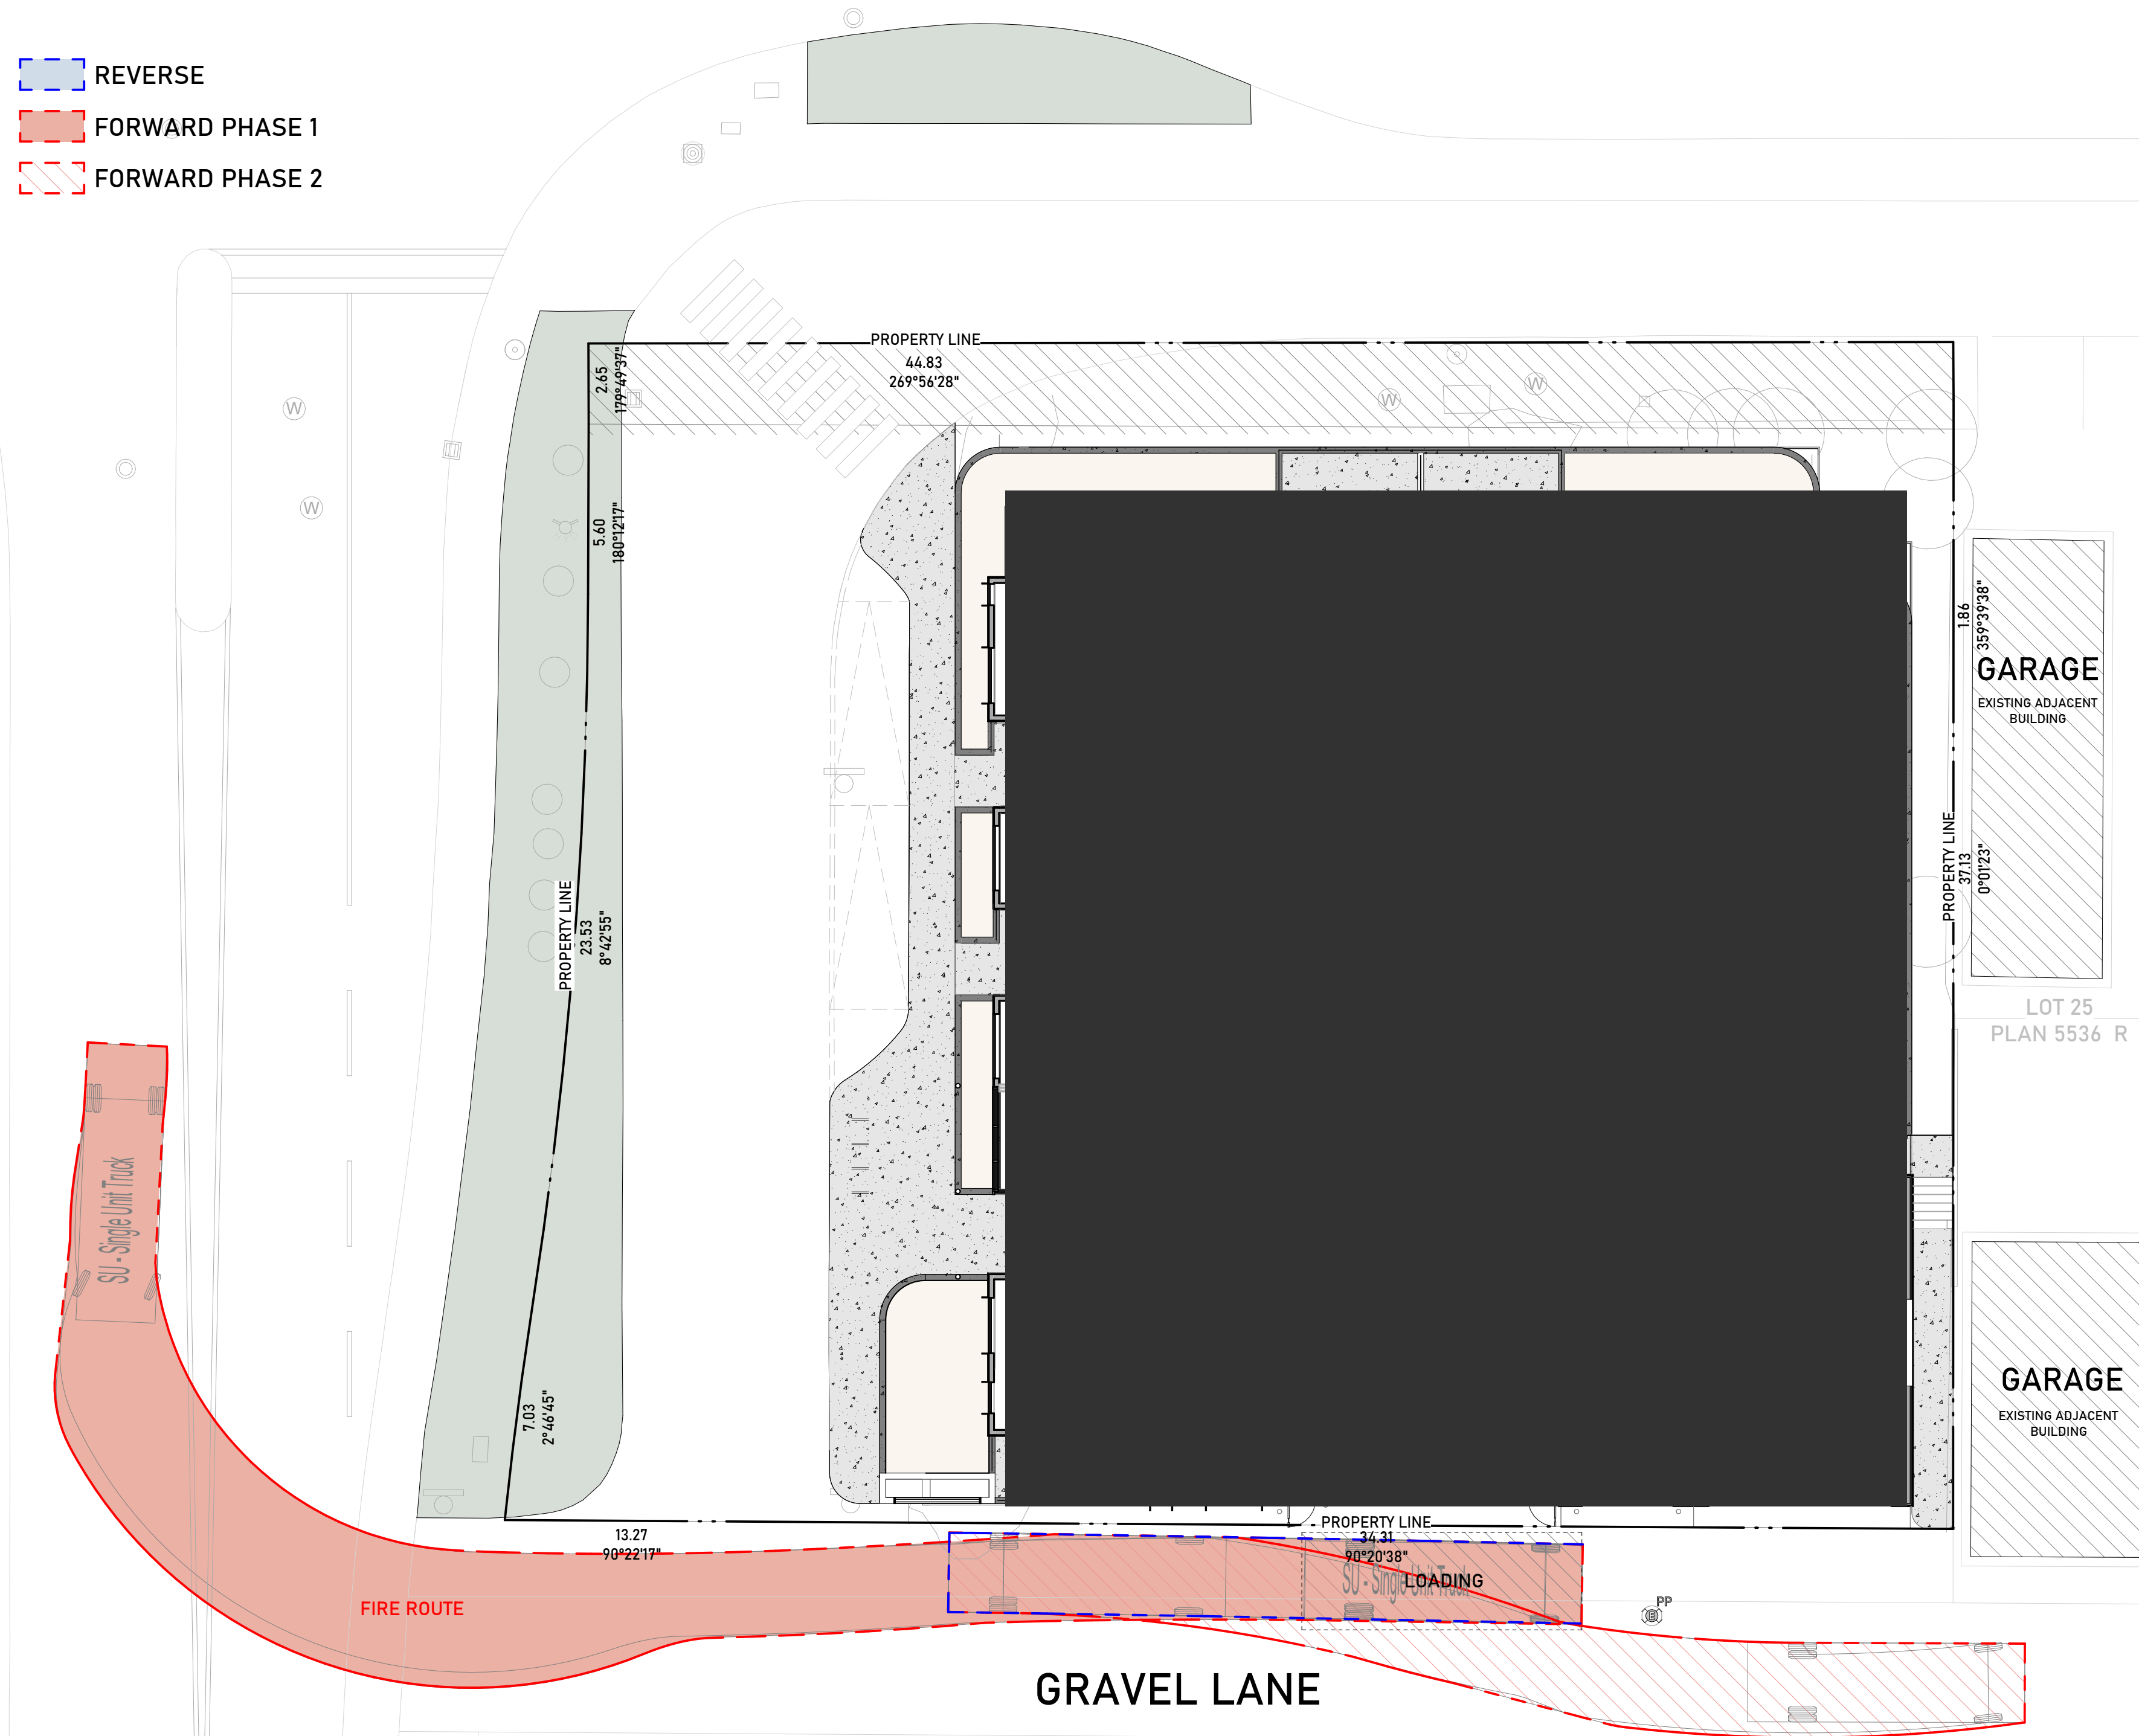- REVERSE
- FORWARD PHASE 1
- FORWARD PHASE 2
- STAGING / PICK-UP AREAS

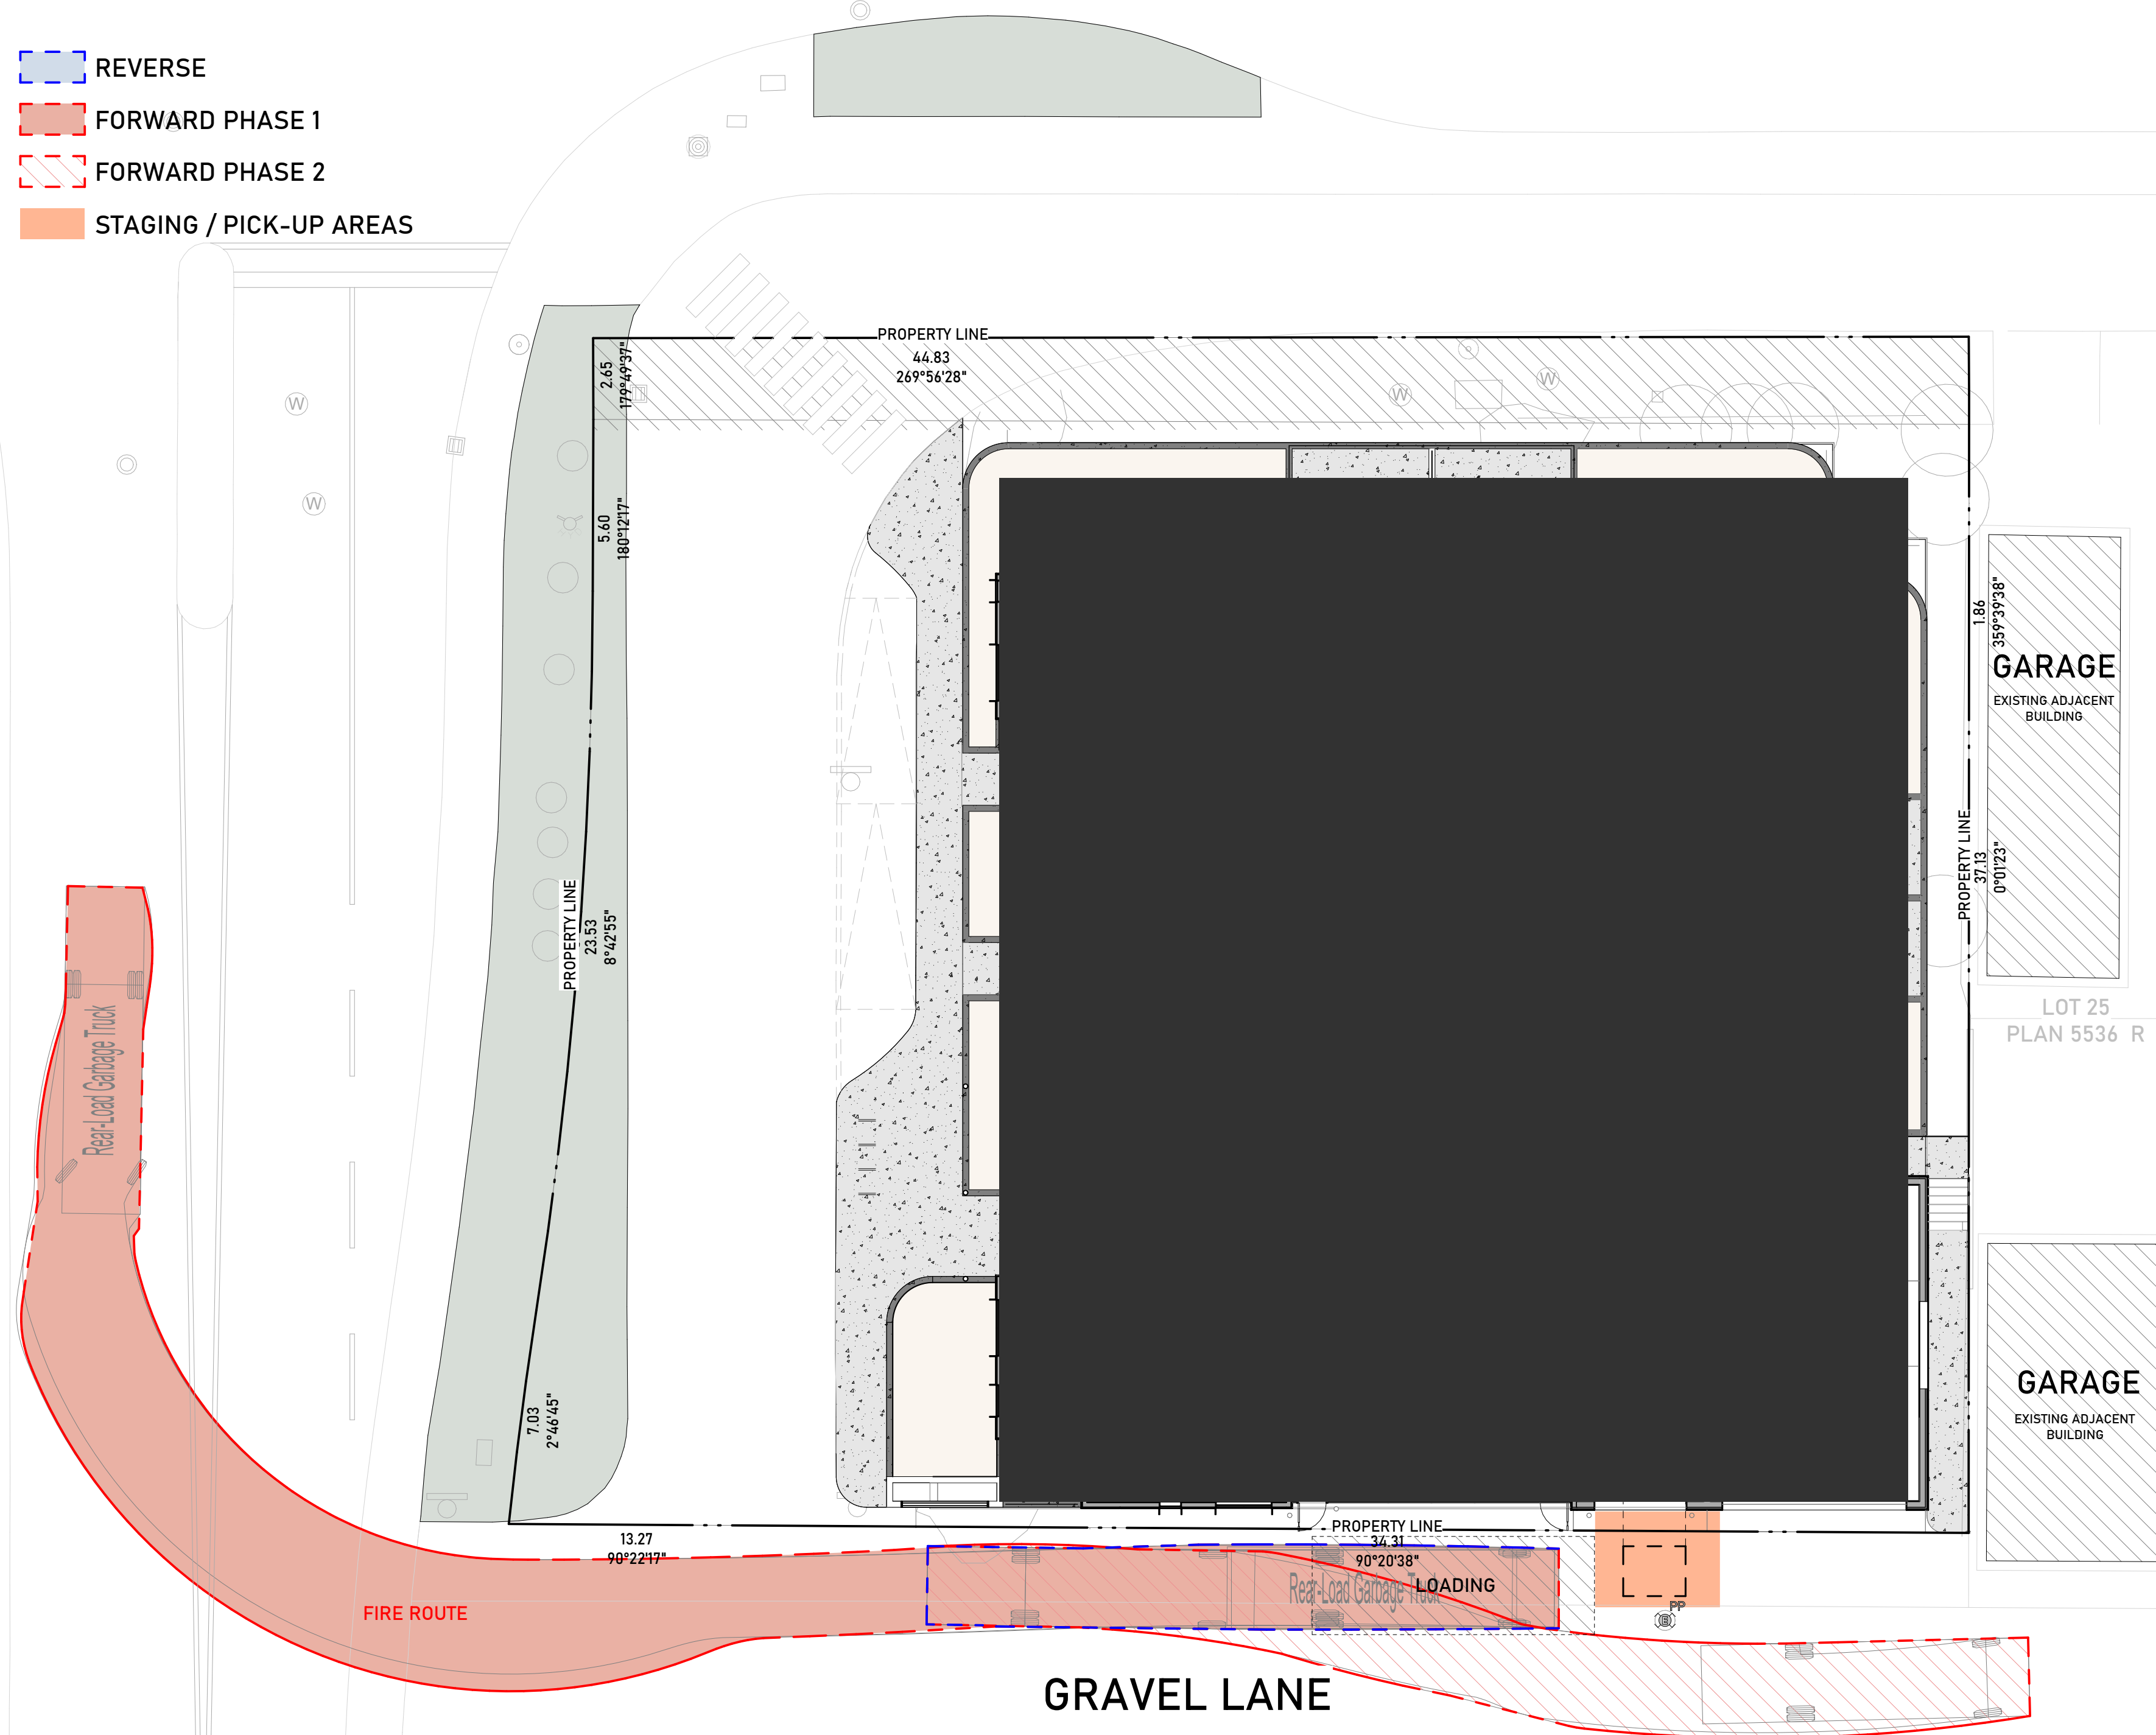


TRUE NORTH PROJECT NORTH
 SCALE: 1:150
VEHICLE SWEEP - WASTE & RECYCLING


- REVERSE
- FORWARD

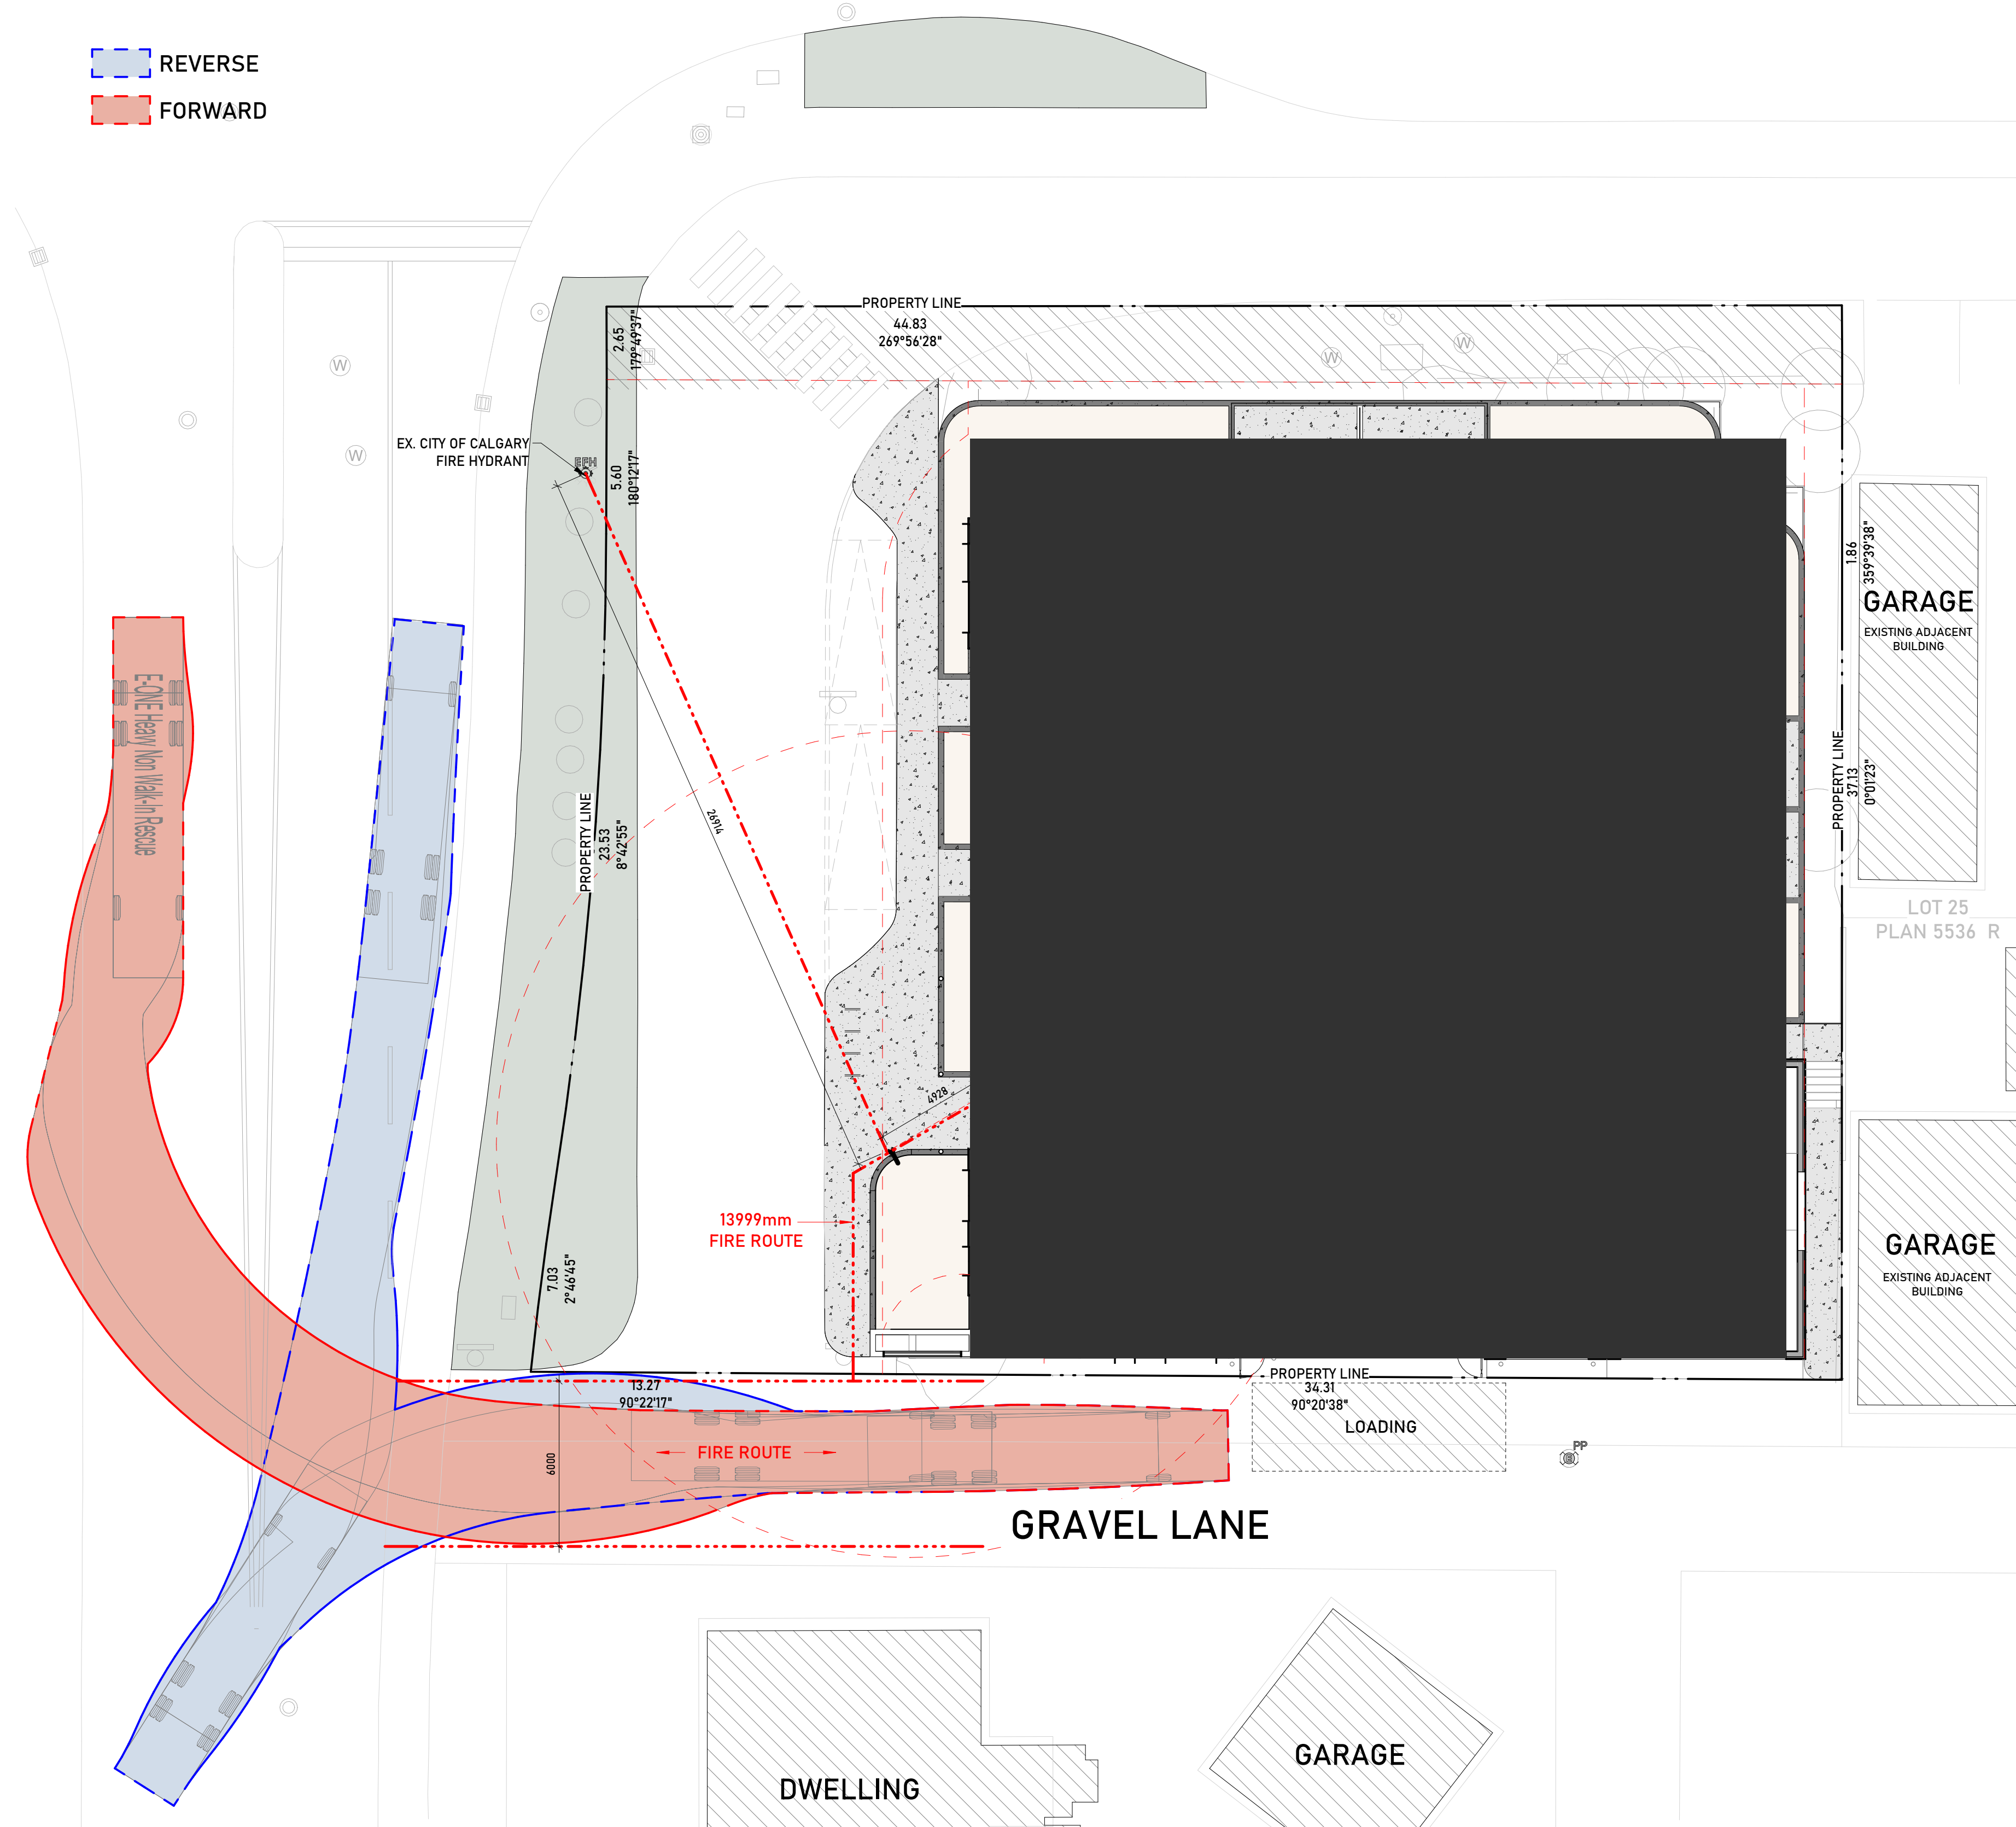


TRUE NORTH PROJECT NORTH
 SCALE: 1:150
VEHICLE SWEEP - FIRE ACCESS

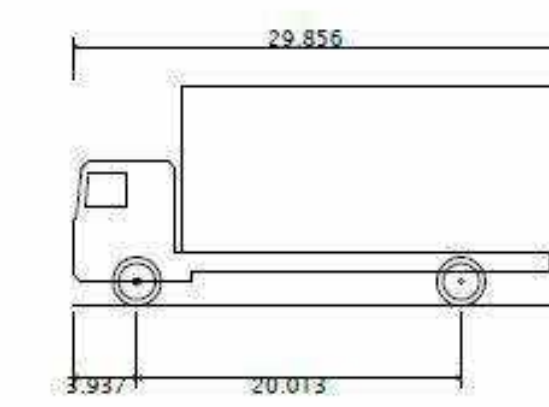

SU9 - Single Unit or Bus
 Overall Length 29.856ft
 Overall Width 8.530ft
 Overall Body Height 13.615ft
 Min Body Ground Clearance 1.460ft
 Track Width 8.530ft
 Lock-to-lock time 4.00s
 Curb to Curb Turning Radius 41.995ft

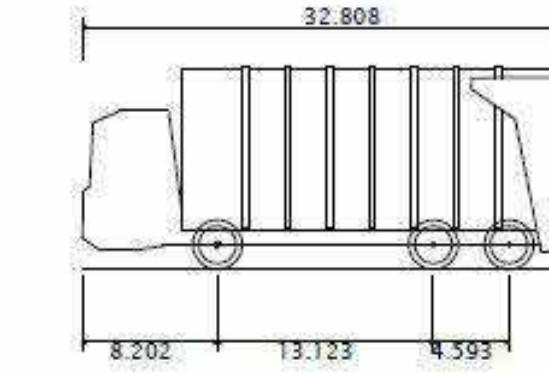

City of Calgary Waste Truck
 Overall Length 32.808ft
 Overall Width 8.530ft
 Overall Body Height 12.365ft
 Min Body Ground Clearance 1.054ft
 Track Width 8.530ft
 Lock-to-lock time 4.00s
 Wall to Wall Turning Radius 41.995ft

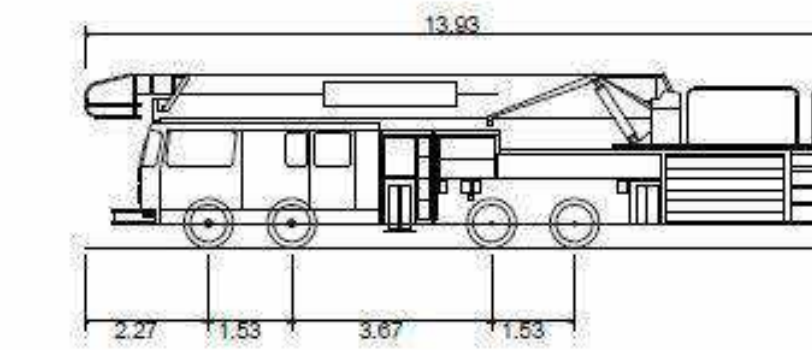

City of Calgary Fire - CFD Bronto Skylift
 Overall Length 13.930m
 Overall Width 2.570m
 Overall Body Height 3.203m
 Min Body Ground Clearance 0.250m
 Track Width 2.570m
 Lock to Lock Time 6.00s
 Max Steering Angle (Virtual) 47.50°

SCALE: 1:100
4 VEHICLE DIAGRAMS
 DP01.05

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| Project Component | |
| Key Plan | |

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| Seal(s) | |
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| Client | |
| Project ONWARD SHAGANAPPI 1406 26 Street SW, Calgary, AB T3C 1K3 Plan 2311009, Block 5, Lot 55 | |
| Drawing Title SITE ACCESS - VEHICLE SWEEP PATHS | |
| Project Manager | Drawn |
| Project Leader | Author |
| Scale | Checked |
| | Checker |
| Project No. | As indicated |
| Drawing No. | |
| | DP01.05 |

| MATERIAL LEGEND | | |
|-----------------|---------------------------------|--------|
| ABBREV. | MATERIAL TYPE | COLOUR |
| AE-1 | ALUMINUM EXTRUSION | CYAN |
| BRK-1 | MASONRY CLADDING | GRAY |
| CMP-1 | COMPOSITE METAL PANEL | BLACK |
| FCP-1 | FIBER CEMENT PANEL | WHITE |
| FCP-2 | FIBER CEMENT PANEL | GRAY |
| FCP-3 | FIBER CEMENT PANEL (LAP SIDING) | GRAY |
| MTL-1 | METAL CLADDING | BLACK |

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1 NORTH ELEVATION
 DP04.01 SCALE: 1:100



2 EAST ELEVATION
 DP04.01 SCALE: 1:100



3 SOUTH ELEVATION
 DP04.01 SCALE: 1:100



4 WEST ELEVATION
 DP04.01 SCALE: 1:100

Project Component
 Key Plan

Seal(s)

DATE ISSUED FOR REV

Client


Project
ONWARD SHAGANAPPI
 1406 28 Street SW, Calgary, AB T3C 1K3
 Plan 2311009, Block 5, Lot 55
 Drawing Title
EXTERIOR ELEVATIONS

Project Manager Drawn
 Project Leader Author
 Scale Checked
 1:100
 Project No.
 Drawing No.
DP04.01


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Project Component
 Key Plan


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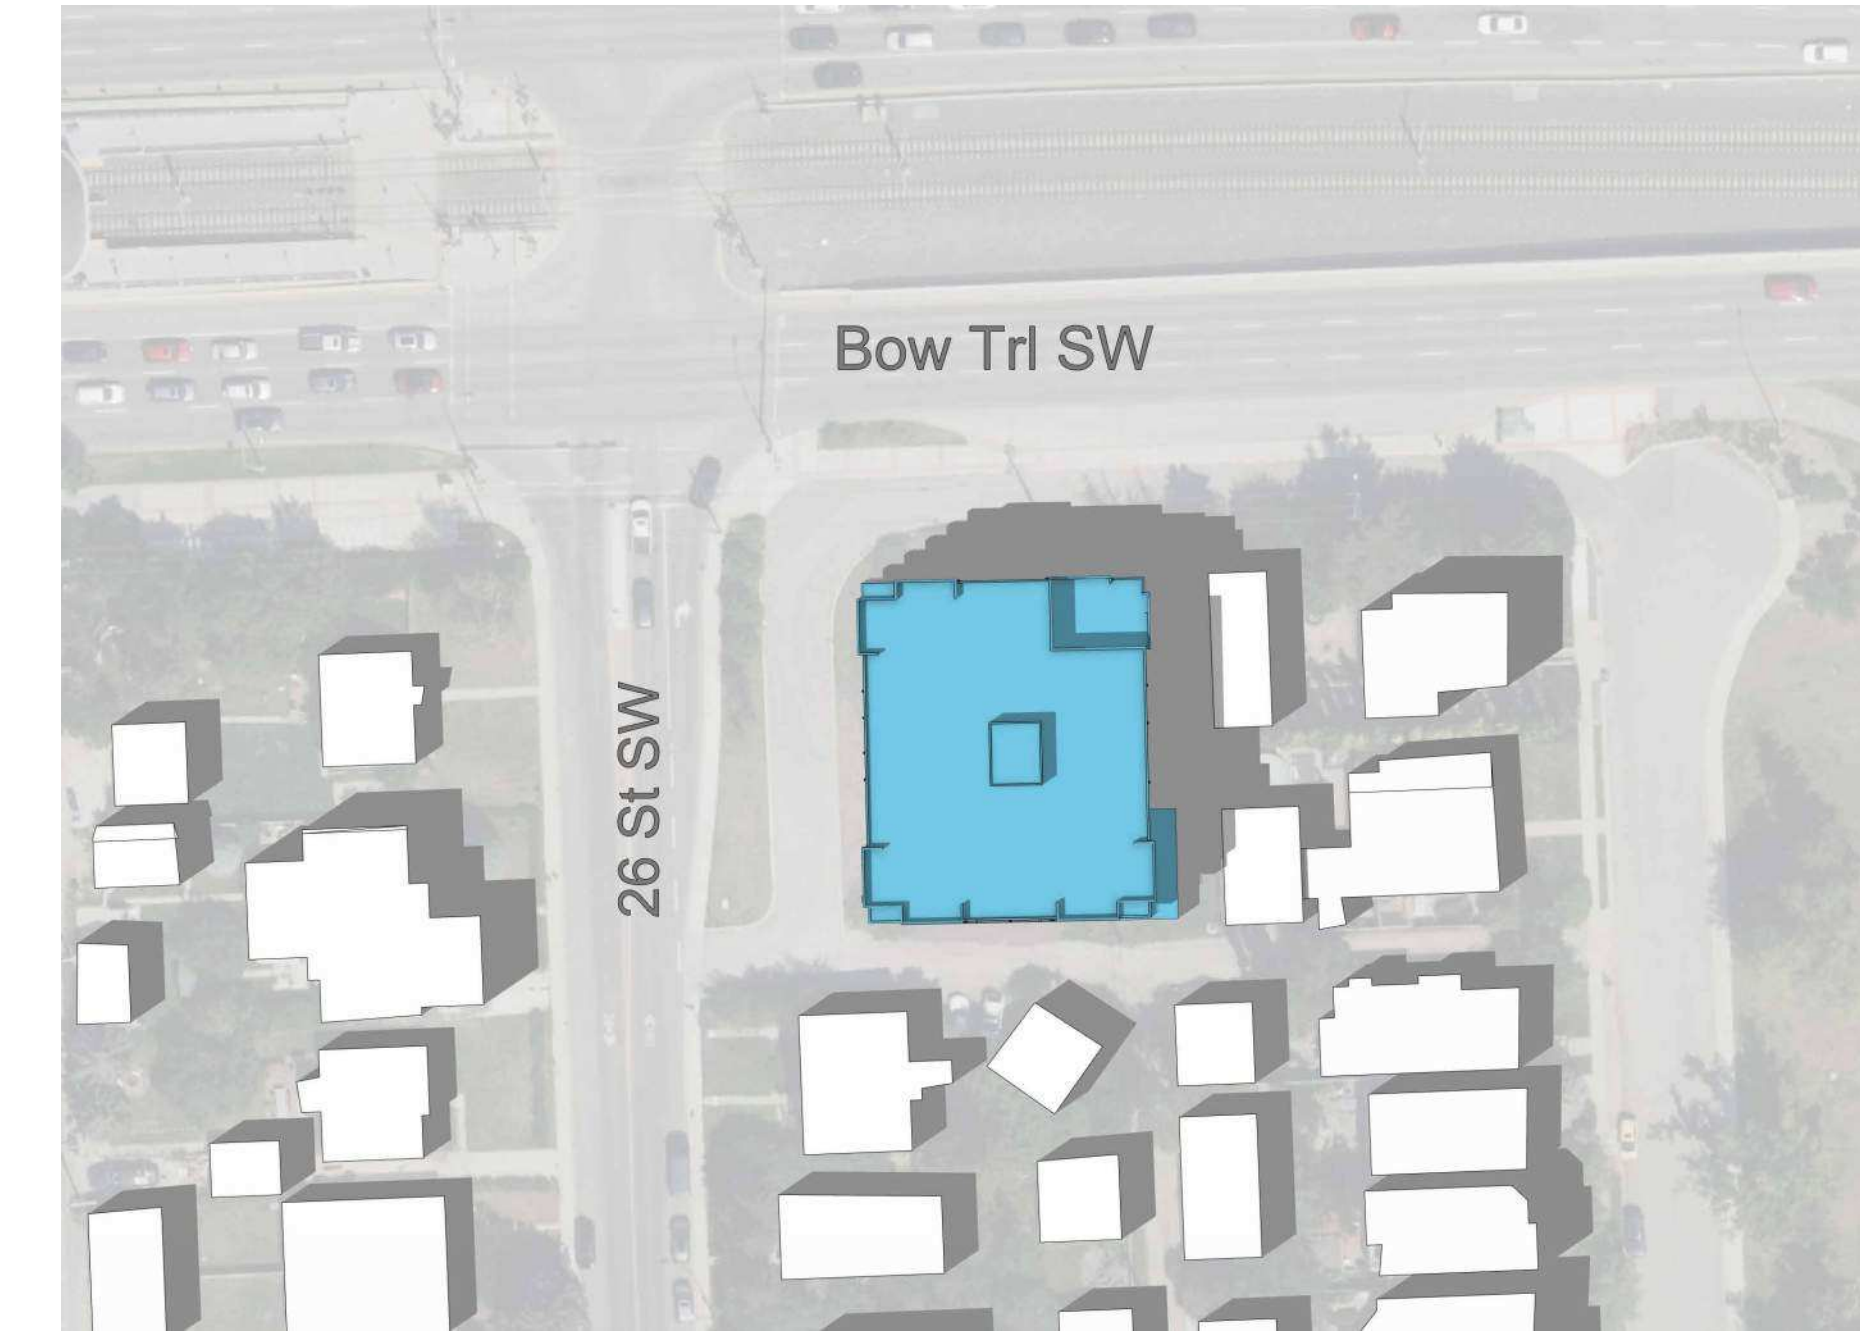
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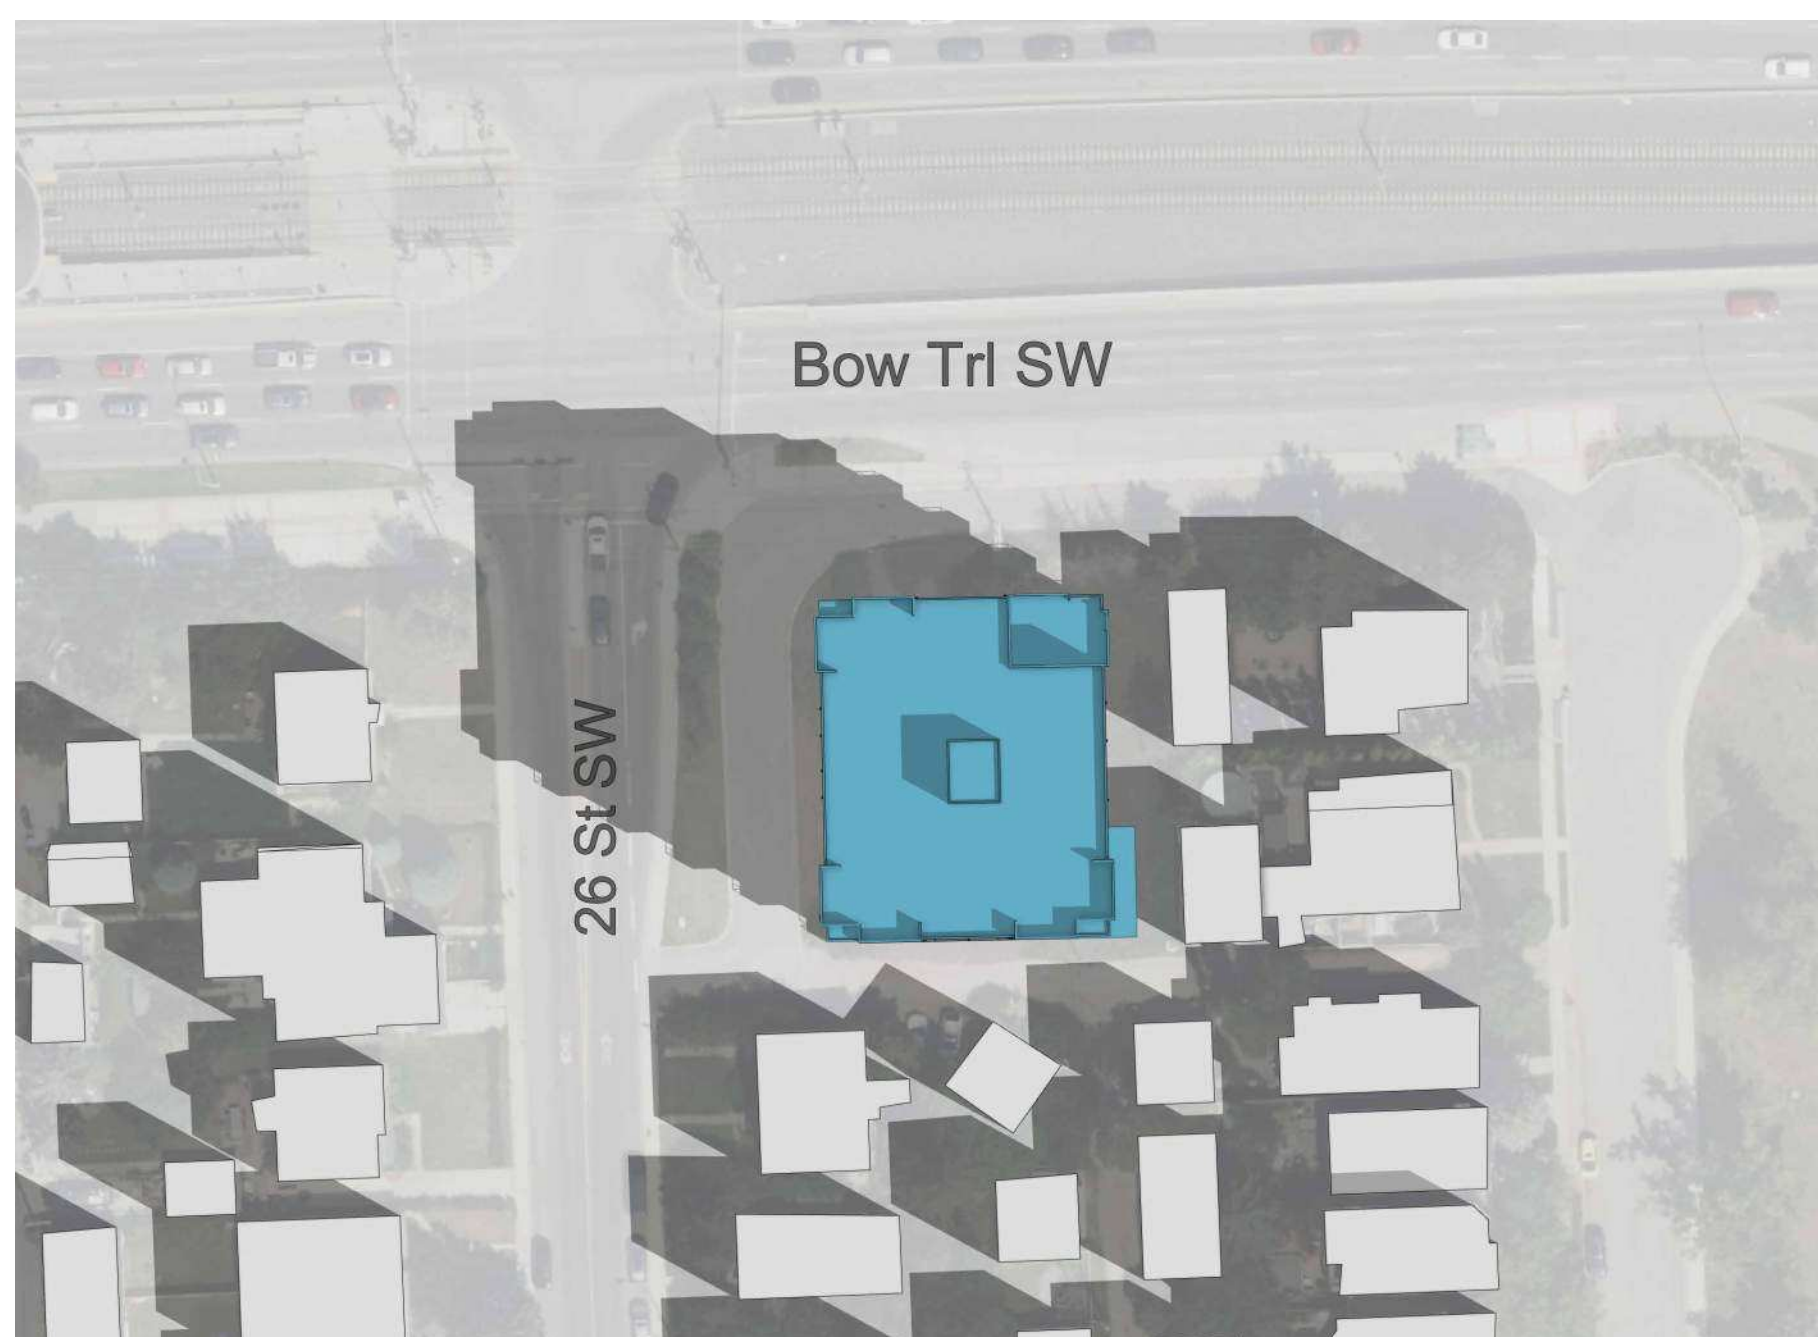
JUNE 12 PM

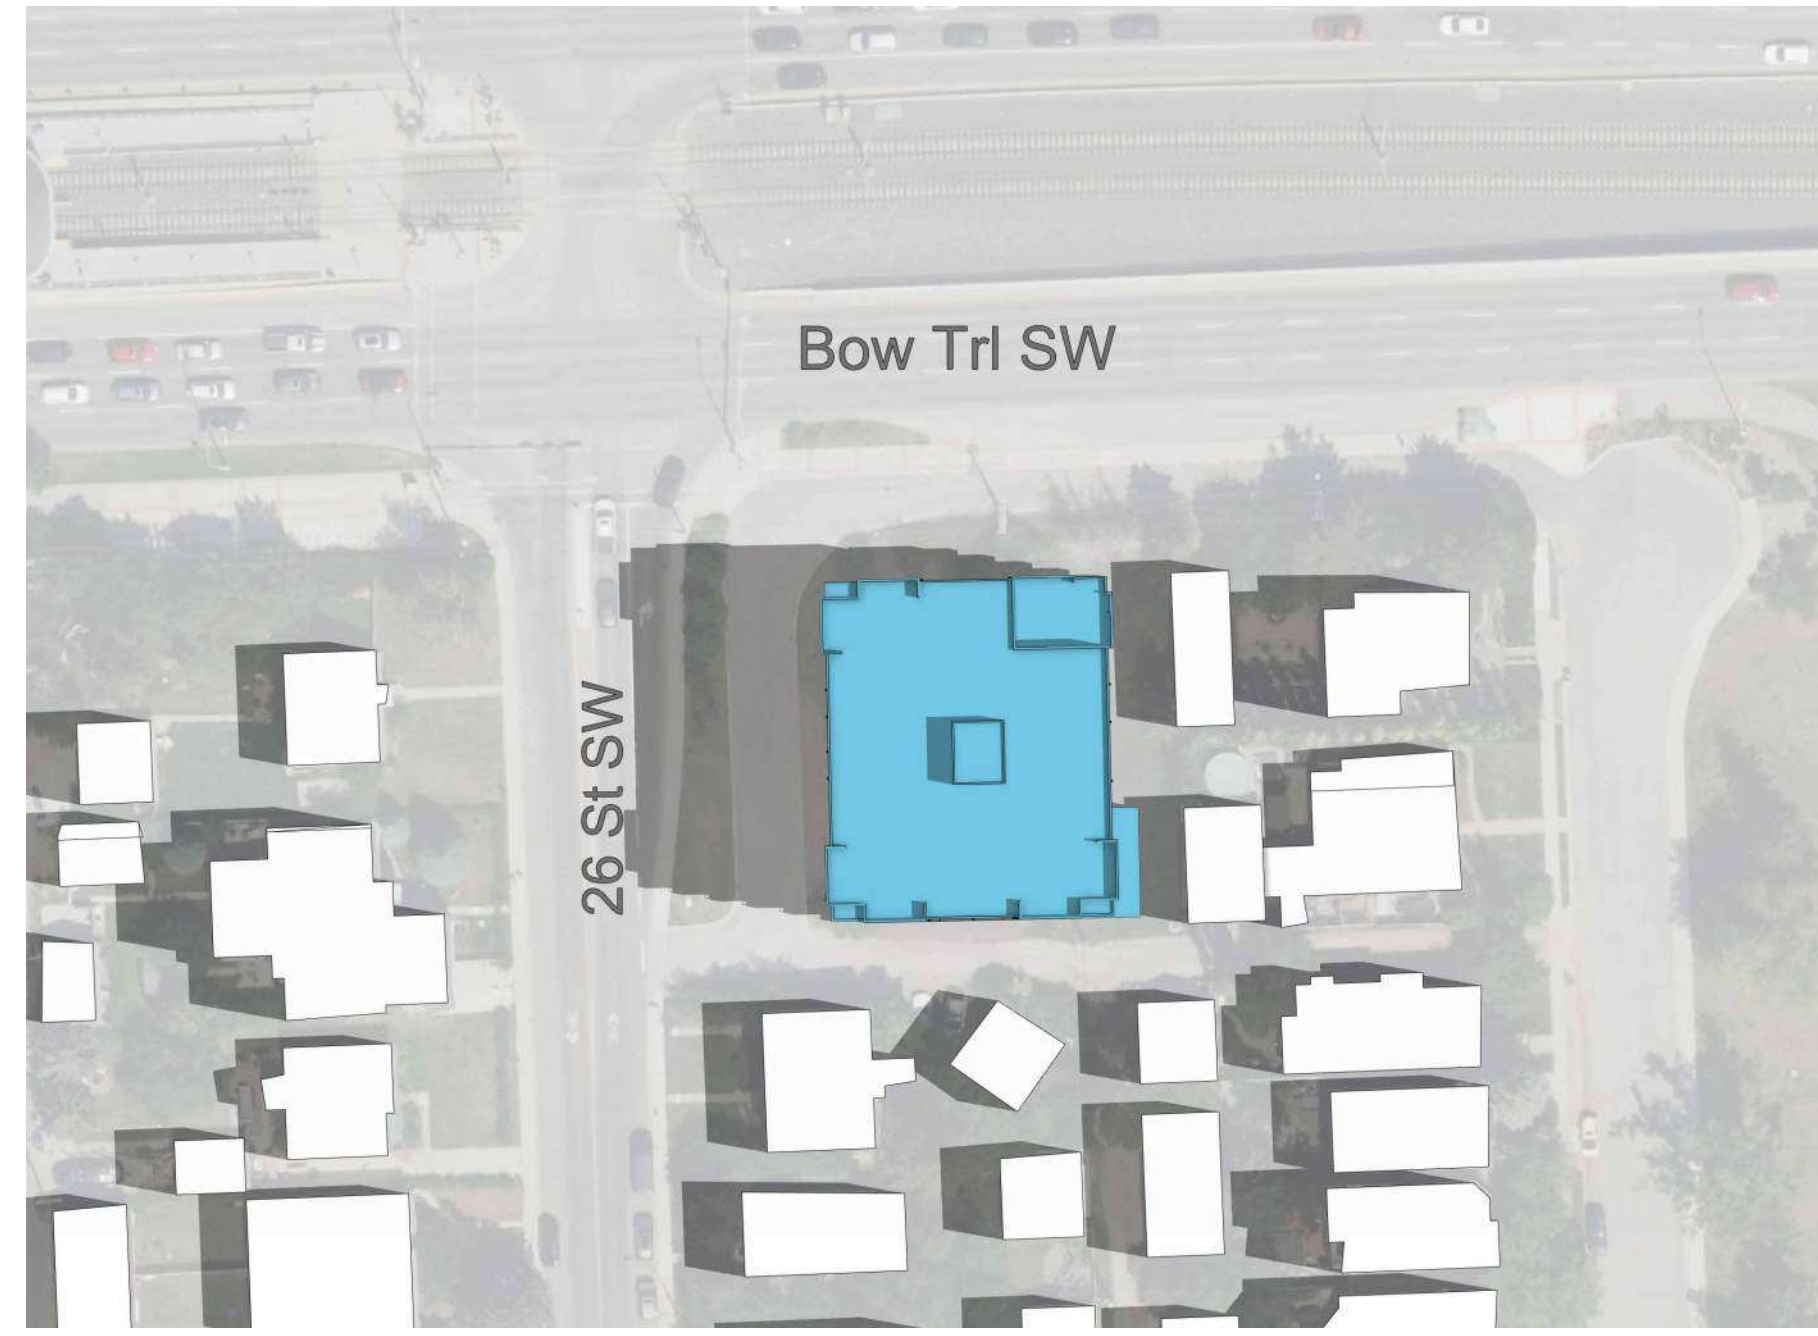

JUNE 2 PM

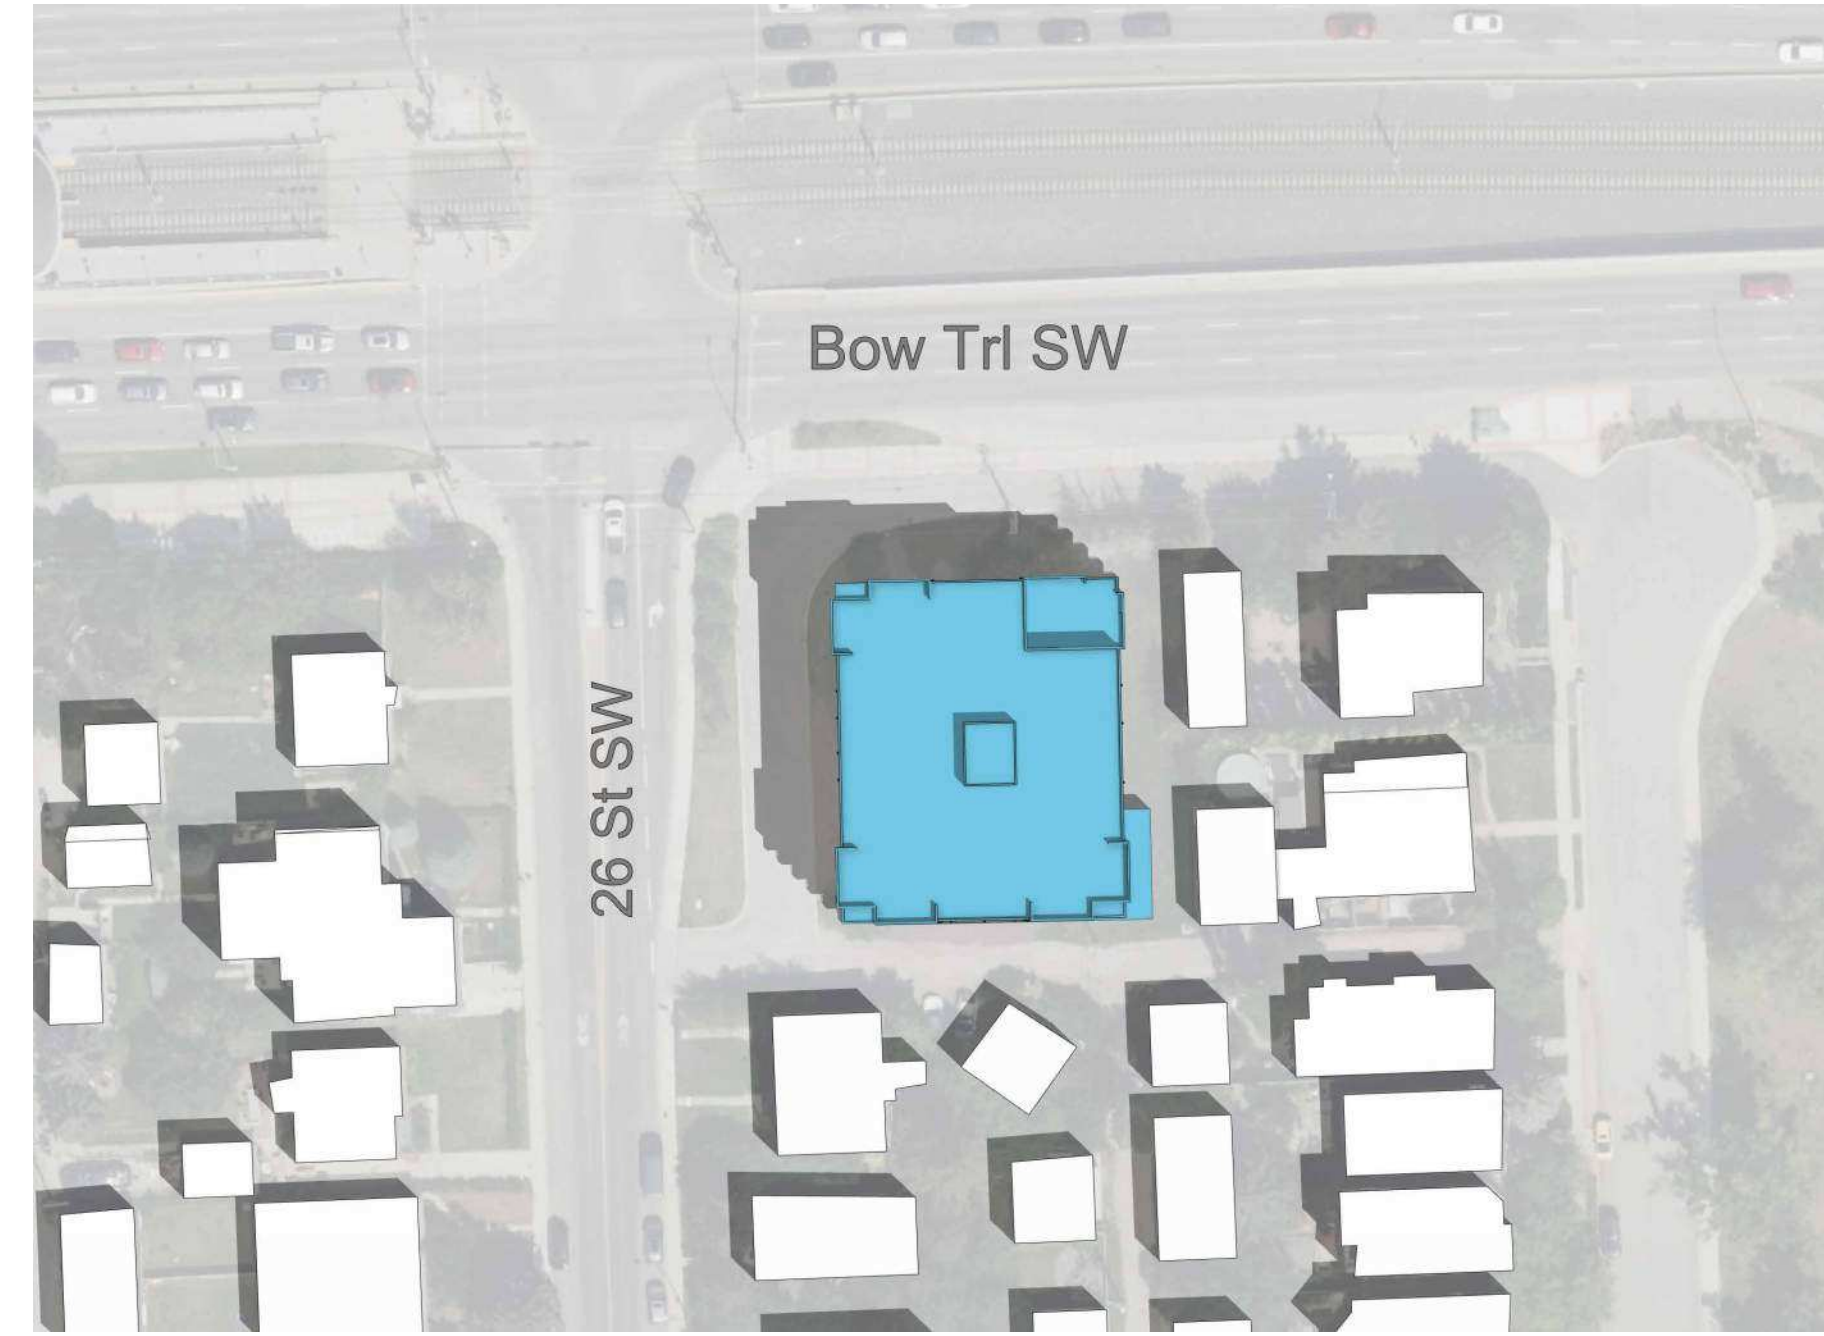

JUNE 4 PM

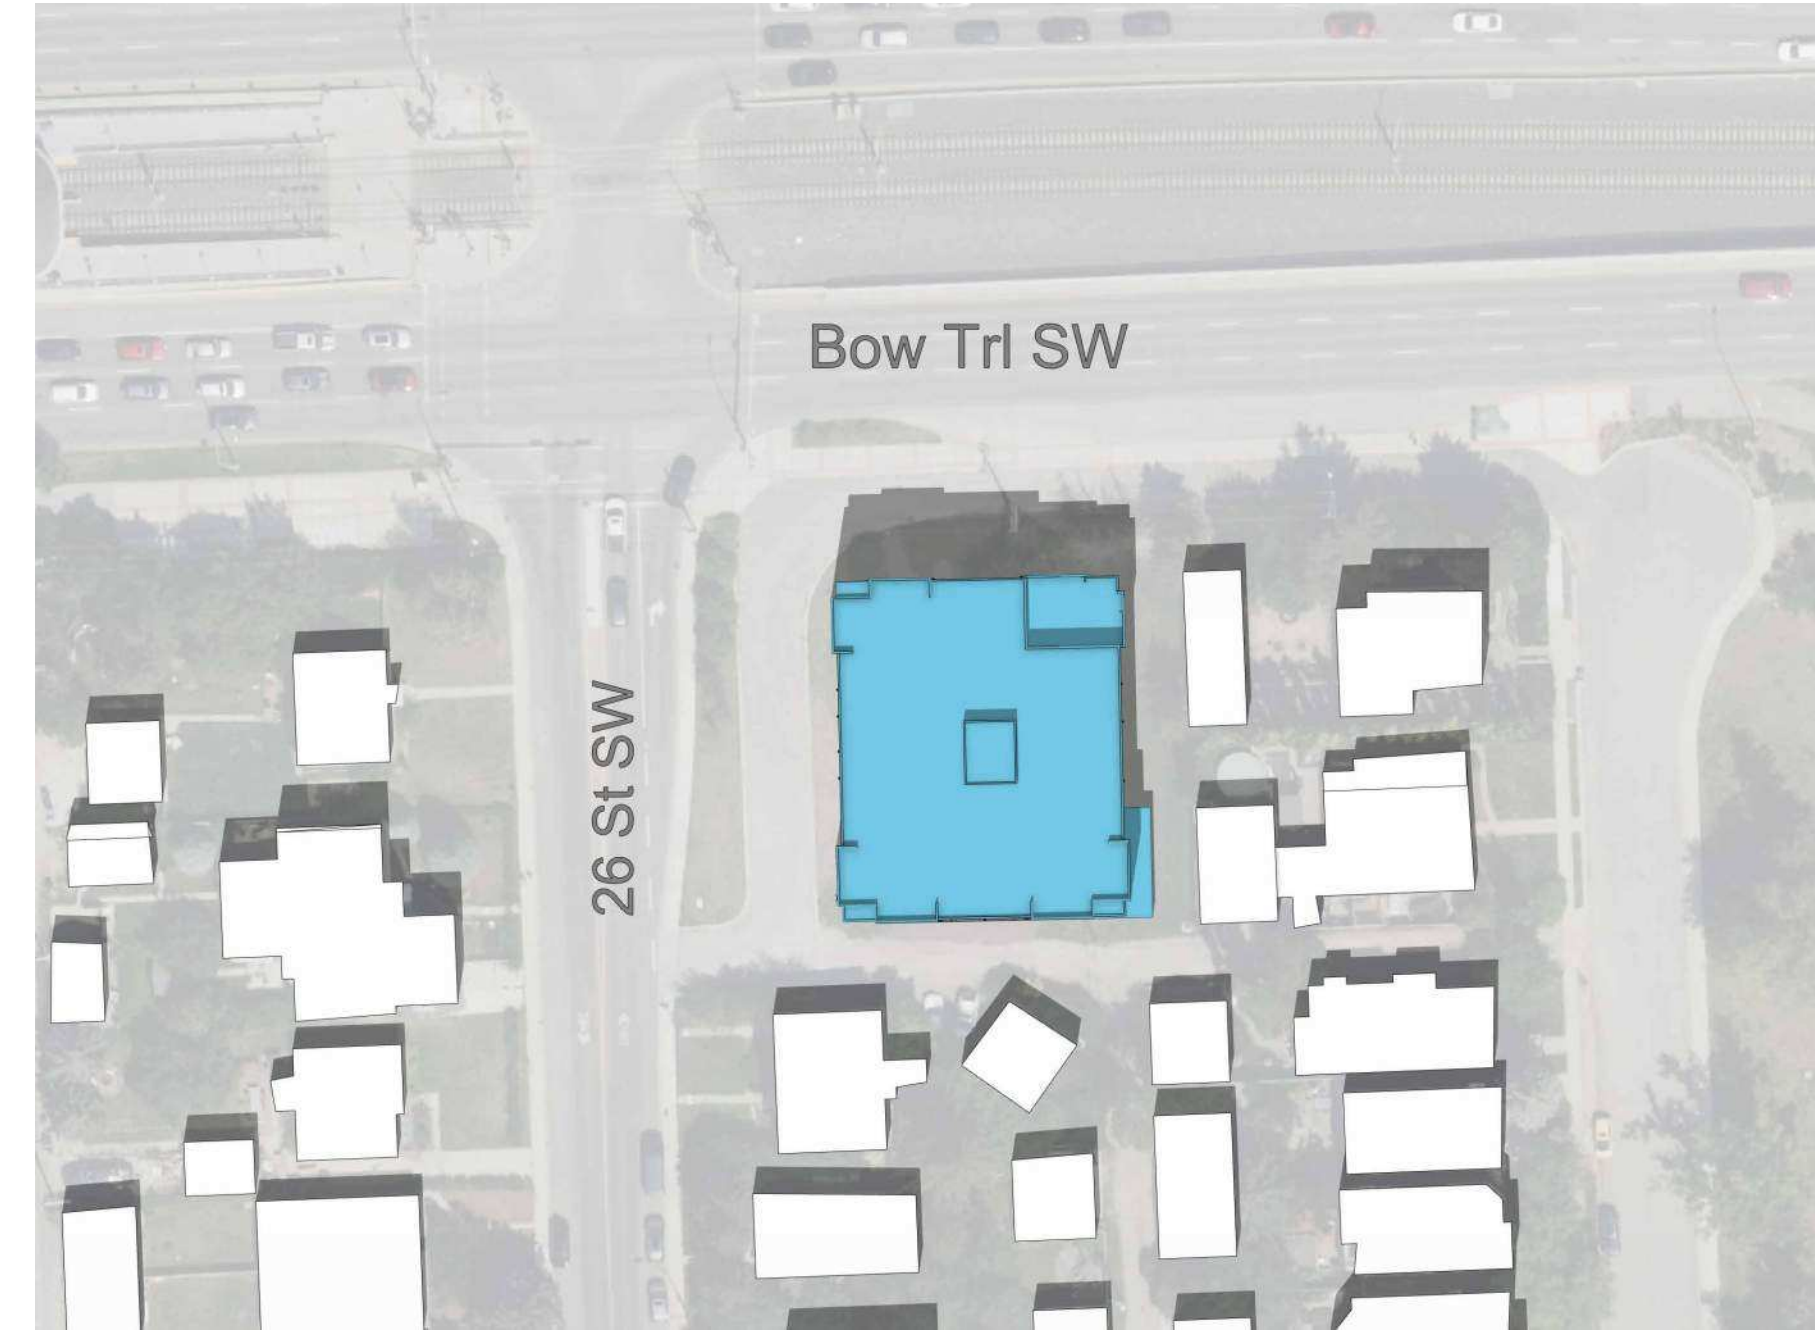


SEPTEMBER 10 AM



SEPTEMBER 12 PM



SEPTEMBER 2 PM

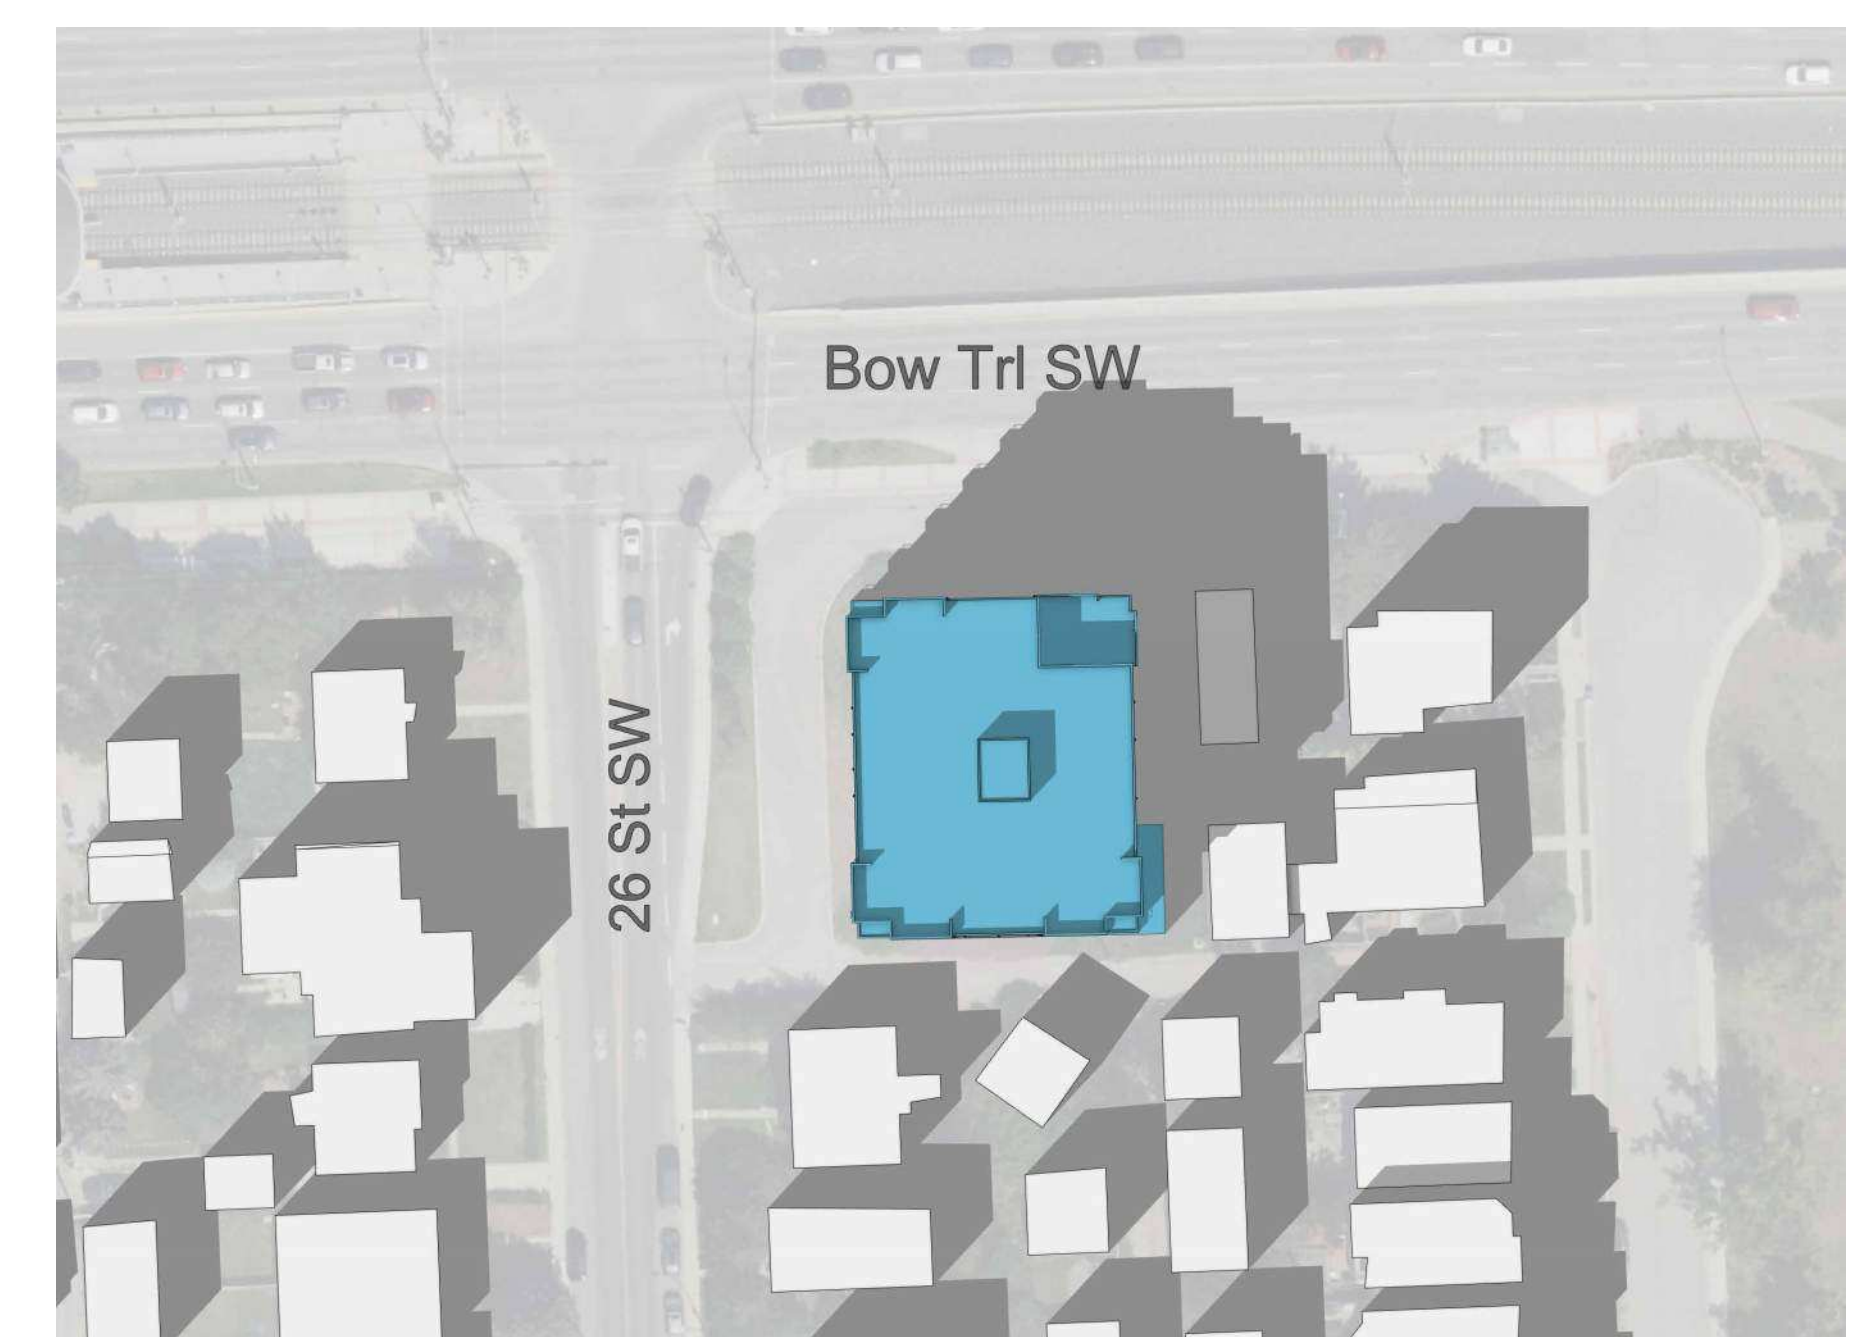


SEPTEMBER 4 PM



DECEMBER 10 AM



DECEMBER 12 PM

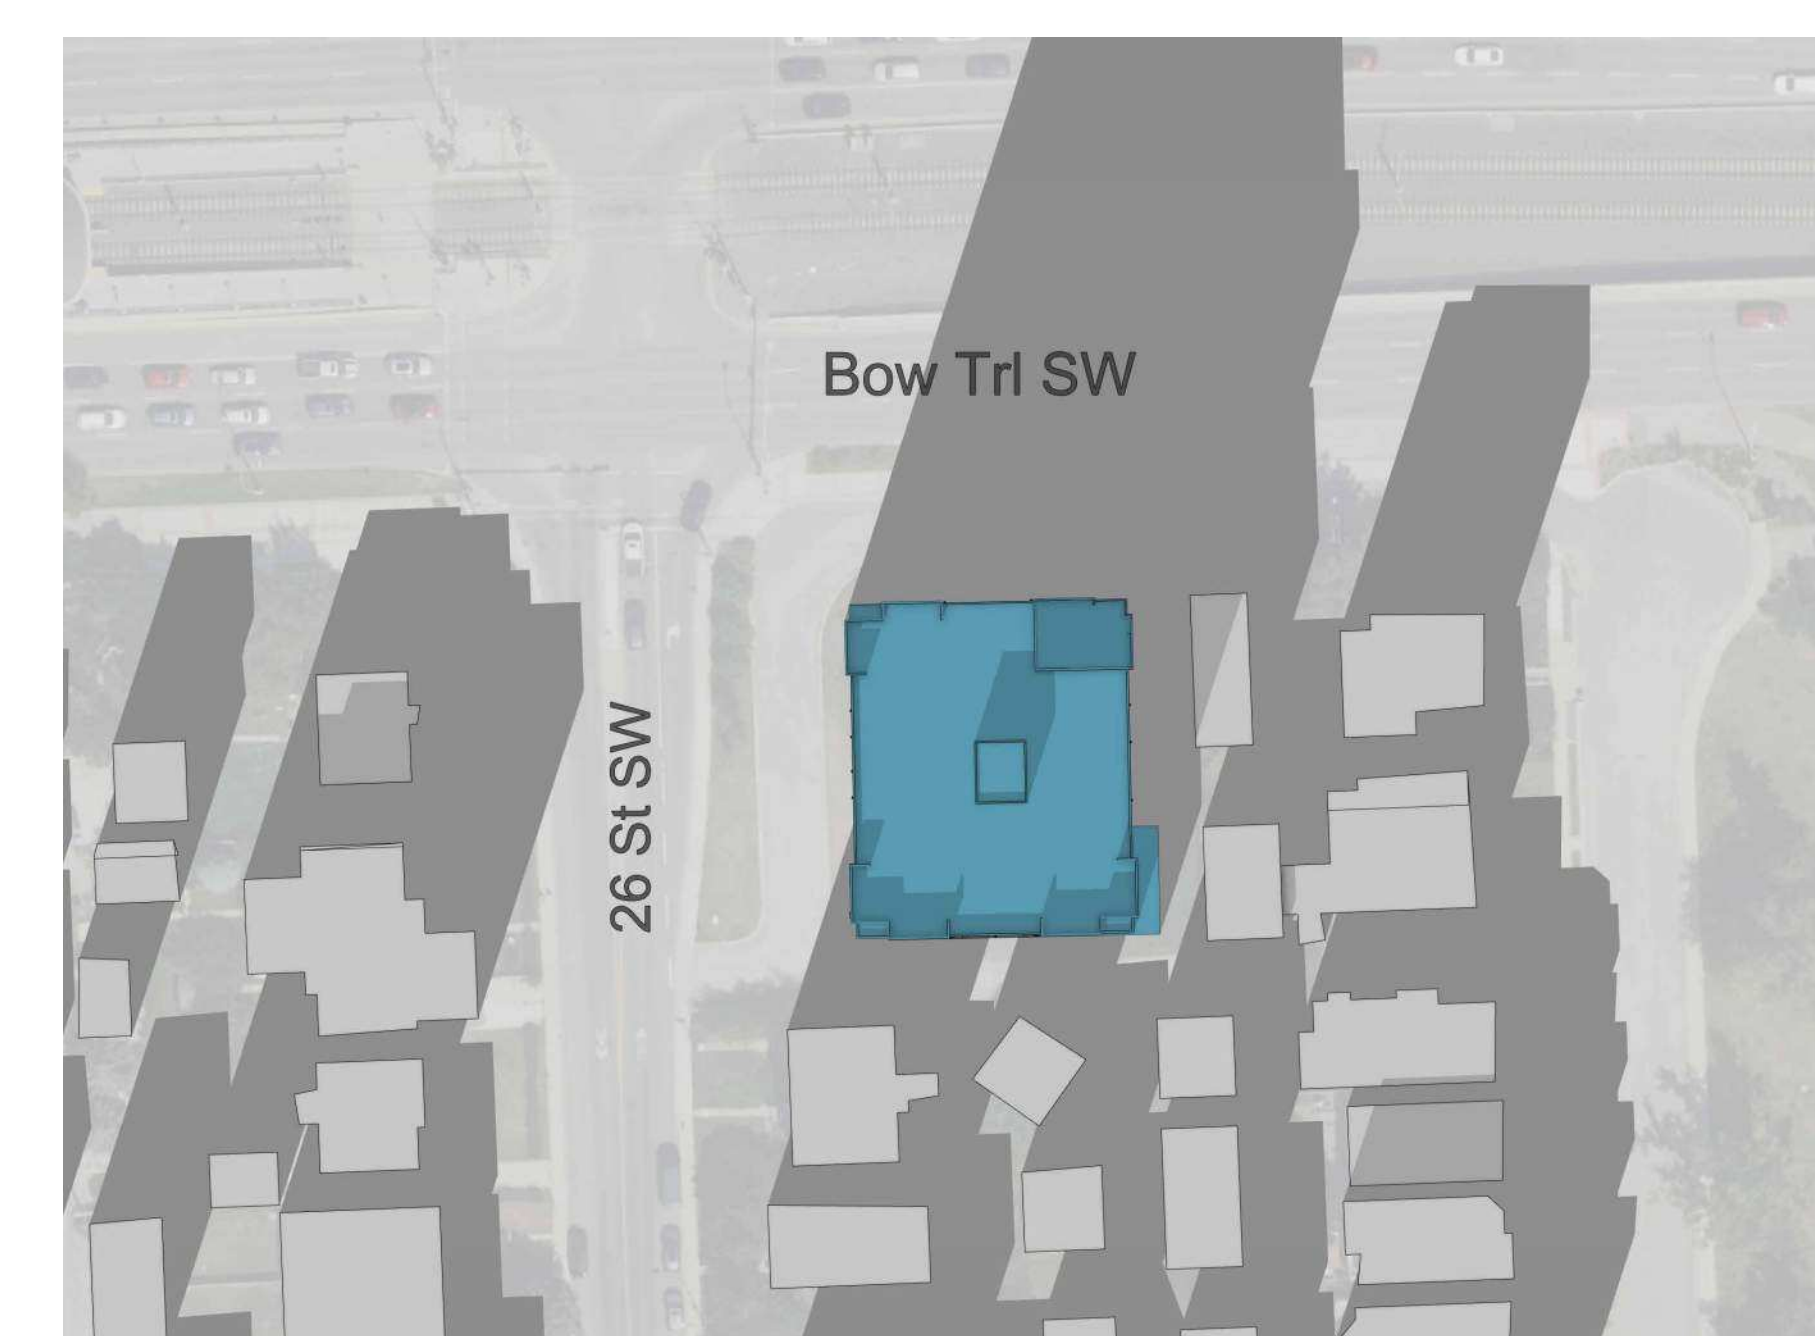

DECEMBER 2 PM




DECEMBER 4 PM

| DATE | ISSUED FOR | REV |
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Client
 Project
ONWARD SHAGANAPPI
 1406 26 Street SW, Calgary, AB T3C 1K3
 Plan 2311009, Block 5, Lot 55
 Drawing Title
SHADOW STUDY

| | |
|-----------------|---------|
| Project Manager | Drawn |
| Project Leader | Author |
| | Checked |
| | Checker |
| Scale | |



Project No.
 Drawing No.
DP06.01

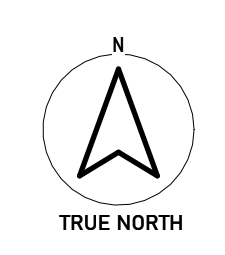

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THIS DRAWING TO BE USED FOR GRADING & SERVICING INFORMATION ONLY. FOR BUILDING LOCATION, DIMENSIONS, AND PARKING LAYOUT, REFER TO LATEST ARCHITECTURAL DRAWINGS

DEVELOPMENT IS TO BE BUILT TO THE CITY APPROVED STAMPED DSSP DRAWINGS. SHOULD ANY INCONSISTENCIES EXIST BETWEEN THIS DRAWING AND THE CITY STAMPED APPROVED DSSP DRAWINGS, PLEASE NOTIFY THE ENGINEER IMMEDIATELY. THE CITY OF CALGARY STAMPED ENGINEERING DRAWINGS GOVERN WHEN ANY INCONSISTENCIES ARE FOUND BETWEEN DRAWINGS. DSSP PLANS TO MATCH DP PLANS WHEN ALL IS COMPLETE

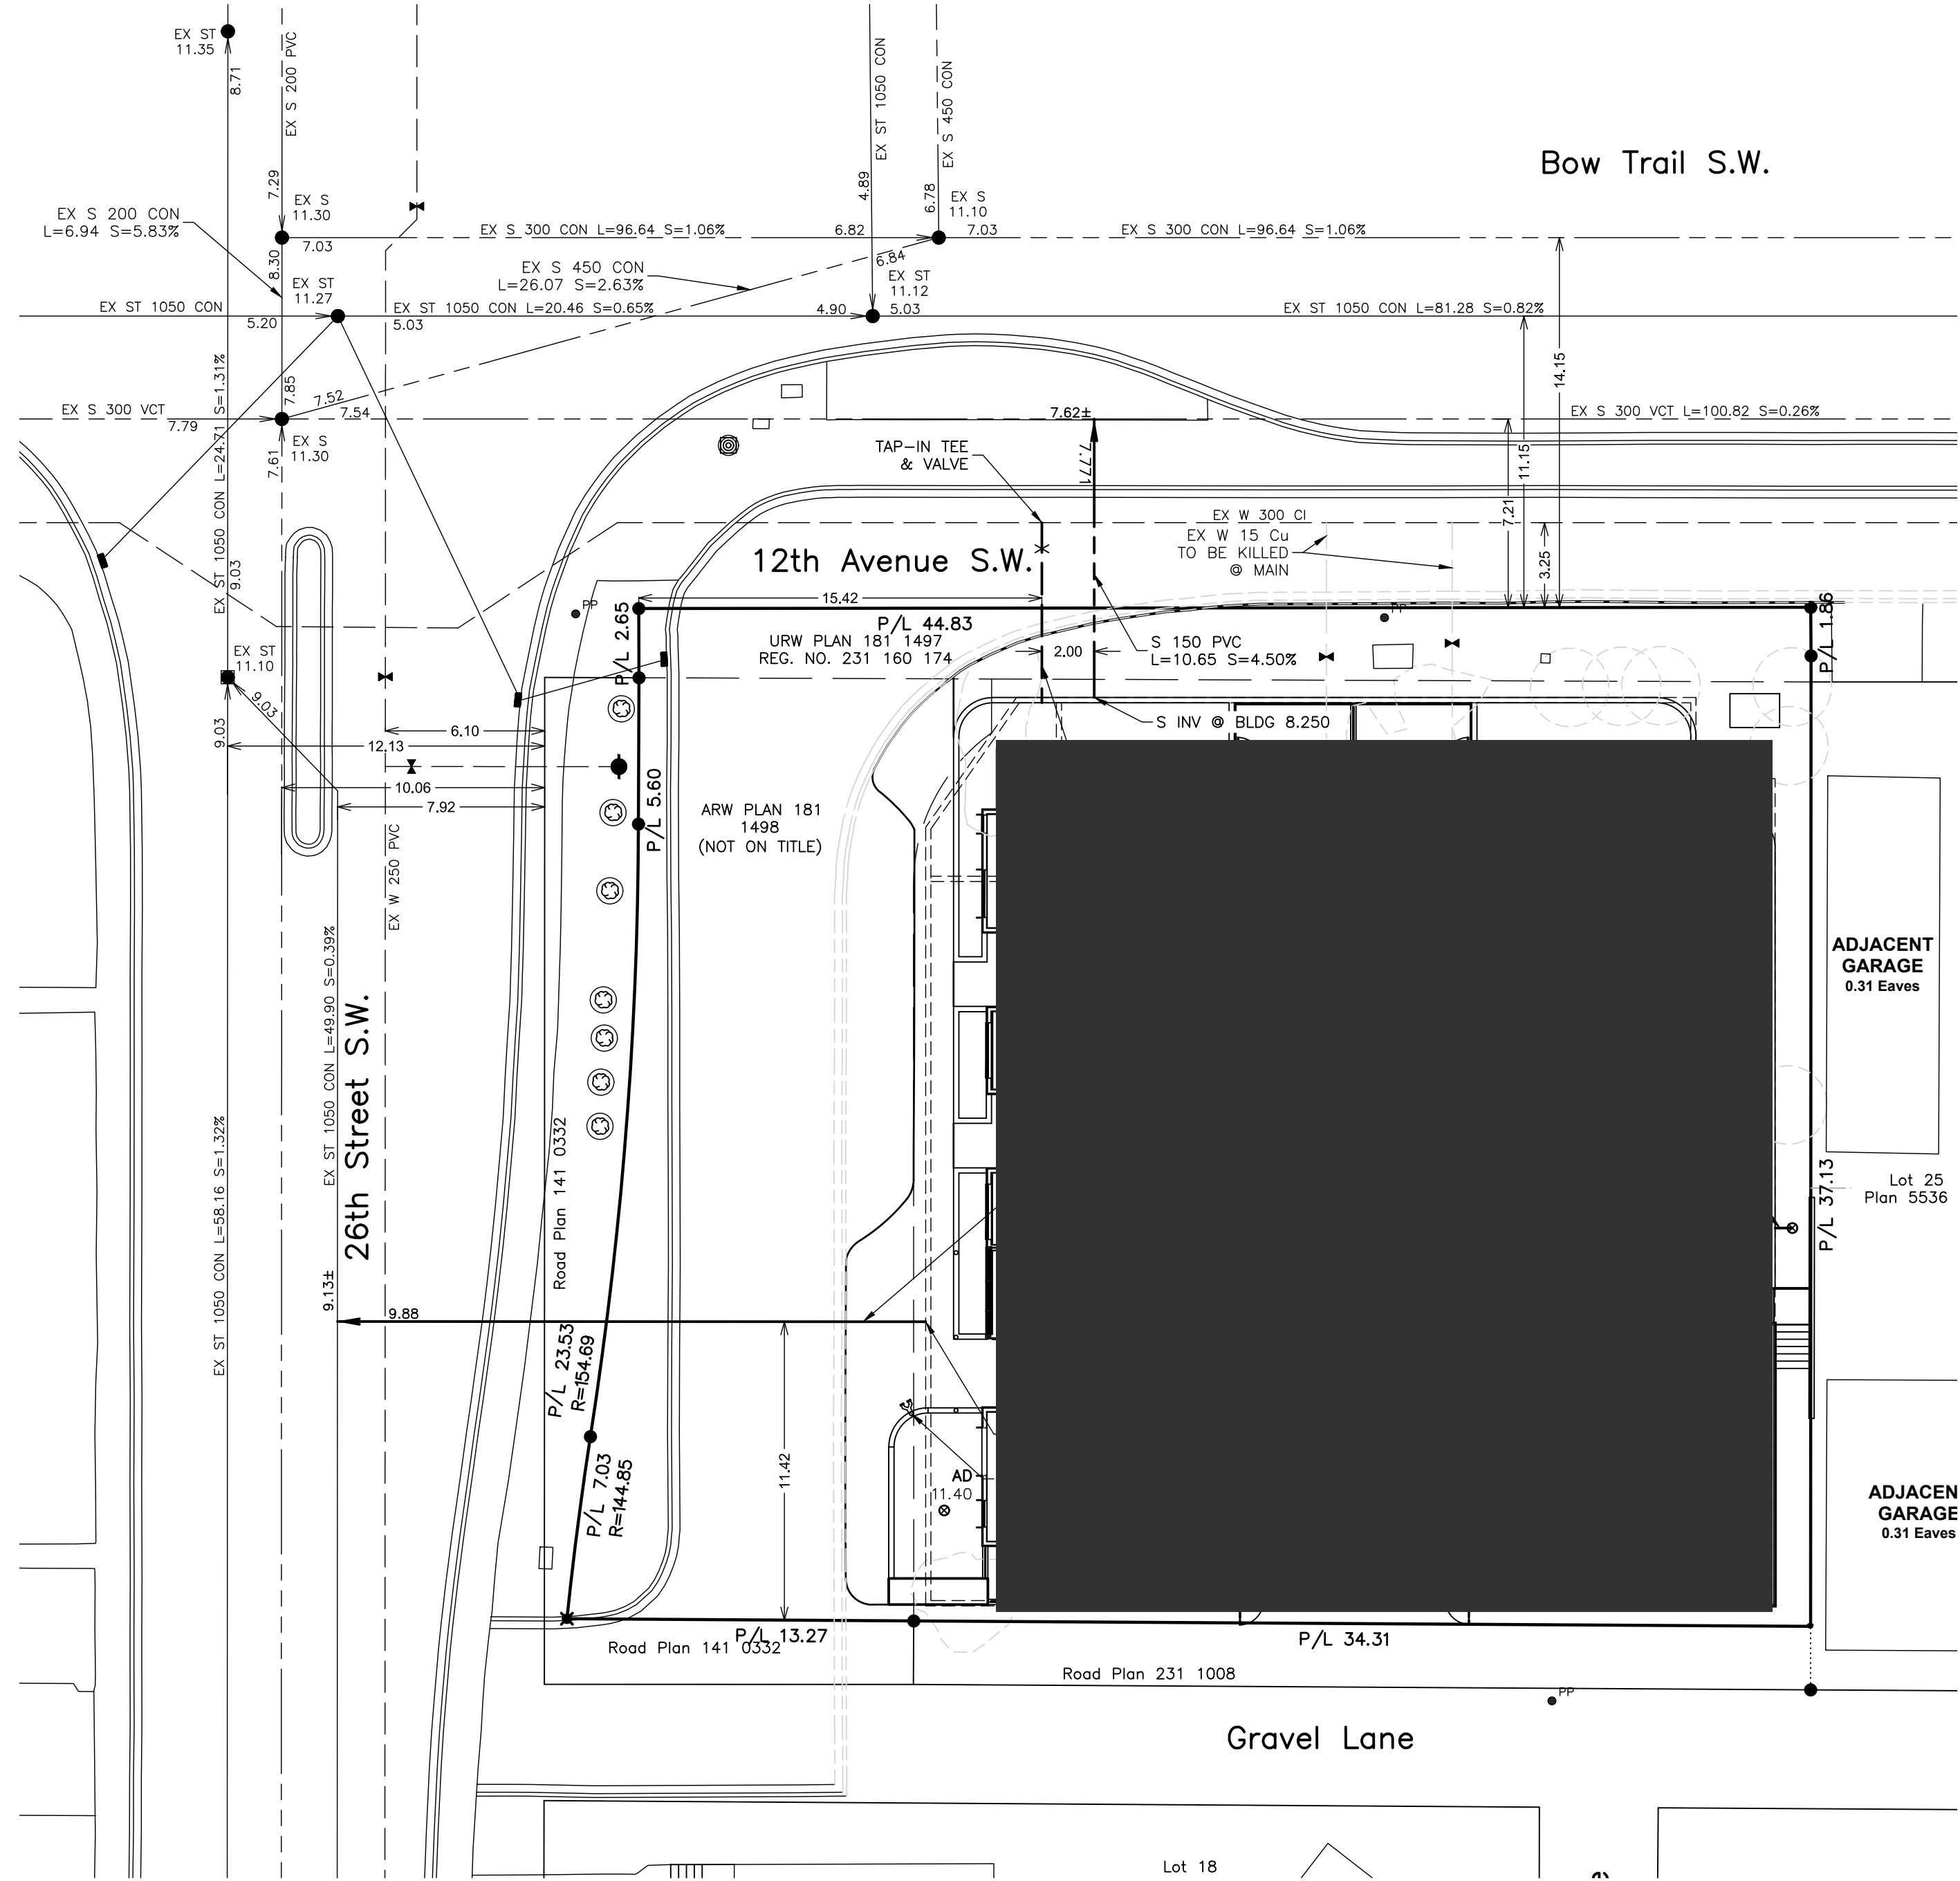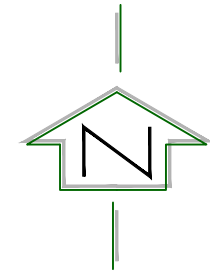

MUNICIPAL ADDRESS
 ??????????????????????
 Calgary AB

LEGAL DESCRIPTION
 LOT ???, BLOCK ?
 PLAN ??? ????_ 1/4
 SEC. ?-?-?-W?M

FOR DEVELOPMENT PERMIT SUBMISSION ONLY.
 NOT FOR TENDER OR CONSTRUCTION.

| | | | |
|---|--|---------|------|
| CITY OF CALGARY DEVELOPMENT SITE SERVICING PLAN | | | |
| DATE RECEIVED | | | |
| CIRCULATION TO | | INITIAL | DATE |
| WATER RESOURCES | | | |
| REVIEW AND INSPECTION BY THE CITY IS NOT A SUBSTITUTE FOR SUPERVISION, INSPECTION, AND DUE DILIGENCE BY THE ENGINEER OF RECORD, LOT OWNER, OR CONTRACTOR. | | | |
| THE ENGINEER OF RECORD MAINTAINS FULL RESPONSIBILITY TO EXERCISE COMPETENCE AND GOOD ENGINEERING JUDGEMENT FOR THE ENTIRETY OF THEIR DESIGN AND PROVIDE DOCUMENTATION FOR ALL PRIVATE SITE WORKS AND RETAIN THESE RECORDS FOR THE USE OF THEIR CLIENTS. | | | |

PERMIT _____ STAMP _____

- NOTES
- All elevations referenced to 1000m Geodetic Datum.
 - Hydrants, valves, check valves, manholes, sewer lines, water lines etc., to be installed to City of Calgary standards.
 - All manholes to be S.R.C.
 - Match crown minimum at all sewer connections.
 - All sewer distribution pipes to be SDR 35 PVC. All sewer service pipes <= to 150mm to be SDR 28 PVC. Sewer service pipes > than 150mm to be SDR 35.
 - Sewer lines to minimum slopes as per City of Calgary Standards.
 - Use City of Calgary Type 2 installation, Class 1A bedding for sewer pipes unless unwise noted.
 - Insulation required for sanitary sewers if cover less than 2.50m on mains.
 - Insulation required for storm sewers if cover less than 1.20m as per City of Calgary Standards.
 - All water mains to be DR 18 PVC unless otherwise noted.
 - Use City of Calgary Type 1 installation, Class 1A bedding for water mains, Type 2 installation, class 'B' bedding for services.
 - Depth of bury for water lines to conform with City of Calgary standards.
 - No trees to be planted over water line(s).
 - Protection of Potable Water Supply From Contamination: All Cross connections or potential cross connections must be either eliminated or protected against backflow by the installation of a cross connection control device. All cross connection control devices must be installed in accordance with the Water Utility By-law 22M82 and the National Plumbing Code of Canada.
 - For building locations and dimensions refer to latest Architectural drawings.
 - The contractor is responsible for locating all shallow utilities.
 - The contractor is to verify the location of existing sanitary storm and water services and confirm existing inverts prior to installation within the project area. The Engineer should be notified immediately of any discrepancies.
 - Weeping Tile & Free Flow area drains to be tied to unrestricted free flow storm sewer.
 - All Civil Scope of Work Ends at 1.00m away from the Building Foot Print.

LEGEND

| | |
|------------------|--|
| | Existing hydrant |
| | Proposed hydrant |
| | Existing valve |
| | Valve |
| | Watermain |
| | Sanitary sewer |
| | Storm sewer |
| | Existing manhole |
| | Proposed manhole |
| | Manhole with plastic inserts |
| | Grated top manhole |
| | Catch basin |
| | Water meter location |
| | Existing elevation |
| S-A 00.00 | Sanitary manhole number & elevation |
| CB/GT/ST-1 00.00 | CB/GT/Storm manhole number & elevation |
| M.F. 000.00 | Main floor elevation |
| T.F. 000.00 | Top of footing elevation |
| S 000.00 | Sanitary sewer invert at bldg |

REVISIONS

| | | | |
|-----|------|-------------|----|
| No. | DATE | DESCRIPTION | BY |
| 5 | | | |
| 4 | | | |
| 3 | | | |
| 2 | | | |
| 1 | | | |

ISSUED FOR

| | | | |
|-----|------|--------------------|-------------|
| No. | DATE | DESCRIPTION | BY |
| 4 | | AS-BUILT | |
| 3 | | FOR CONSTRUCTION | |
| 2 | | FOR TENDER | |
| 1 | | DEVELOPMENT PERMIT | 03/06/26 JM |
| | | DRAWING STATUS | DATE APP. |

CLIENT
CTZN ARCHITECTURE

PROJECT
**ONWARD HOMES SOCIETY
 63 UNITS
 1406 26 ST SW**

TITLE
SITE SERVICING PLAN

| | | |
|----------------|--------------|---------------------|
| DESIGN BY: - | SCALE: 1:200 | JOB NUMBER: 26-039 |
| DRAWN BY: - | | |
| CHECKED BY: - | REV NO.: - | DRAWING NUMBER: SP1 |
| DATE: 5-Mar-26 | | |

PERMIT _____ STAMP _____

NOTES
1. All elevations referenced to 1000m Geodetic Datum.

| LEGEND | |
|--------|---|
| | Existing hydrant |
| | Proposed hydrant |
| | Existing valve |
| | Proposed valve |
| | Watermain |
| | Sanitary sewer |
| | Storm sewer |
| | Existing manhole |
| | Proposed manhole |
| | Manhole with plastic inserts |
| | Grated top manhole |
| | Catch basin |
| | Proposed swale |
| | Overland flow |
| | Overland escape route |
| | Proposed design elevation |
| | Proposed building grades |
| | Existing elevation |
| | Proposed road grade |
| | Sanitary manhole number & elevation |
| | CB/GT/Storm manhole number & elevation |
| | Traplow |
| | M.F. 000.00 Main floor elevation |
| | T.F. 000.00 Top of footing elevation |
| | Sanitary sewer invert at bldg |

| REVISIONS | | |
|-----------|------|-------------|
| 5 | | |
| 4 | | |
| 3 | | |
| 2 | | |
| 1 | | |
| No. | DATE | DESCRIPTION |

| ISSUED FOR | | |
|------------|--------------------|-------------|
| 4 | AS-BUILT | |
| 3 | FOR CONSTRUCTION | |
| 2 | FOR TENDER | |
| 1 | DEVELOPMENT PERMIT | 03/06/26 JM |
| No. | DRAWING STATUS | DATE |

CLIENT
CTZN ARCHITECTURE



PROJECT
**ONWARD HOMES SOCIETY
63 UNITS
1406 26 ST SW**

TITLE
SITE GRADING PLAN

| | | |
|----------------|--------------|---------------------|
| DESIGN BY: - | SCALE: 1:200 | JOB NUMBER: 26-039 |
| DRAWN BY: - | | |
| CHECKED BY: - | REV NO.: - | DRAWING NUMBER: SP2 |
| DATE: 5-Mar-26 | | |

THIS DRAWING TO BE USED FOR GRADING & SERVICING INFORMATION ONLY. FOR BUILDING LOCATION, DIMENSIONS, AND PARKING LAYOUT, REFER TO LATEST ARCHITECTURAL DRAWINGS

DEVELOPMENT IS TO BE BUILT TO THE CITY APPROVED STAMPED DSSP DRAWINGS. SHOULD ANY INCONSISTENCIES EXIST BETWEEN THIS DRAWING AND THE CITY STAMPED APPROVED DSSP DRAWINGS, PLEASE NOTIFY THE ENGINEER IMMEDIATELY. THE CITY OF CALGARY STAMPED ENGINEERING DRAWINGS GOVERN WHEN ANY INCONSISTENCIES ARE FOUND BETWEEN DRAWINGS. DSSP PLANS TO MATCH DP PLANS WHEN ALL IS COMPLETE

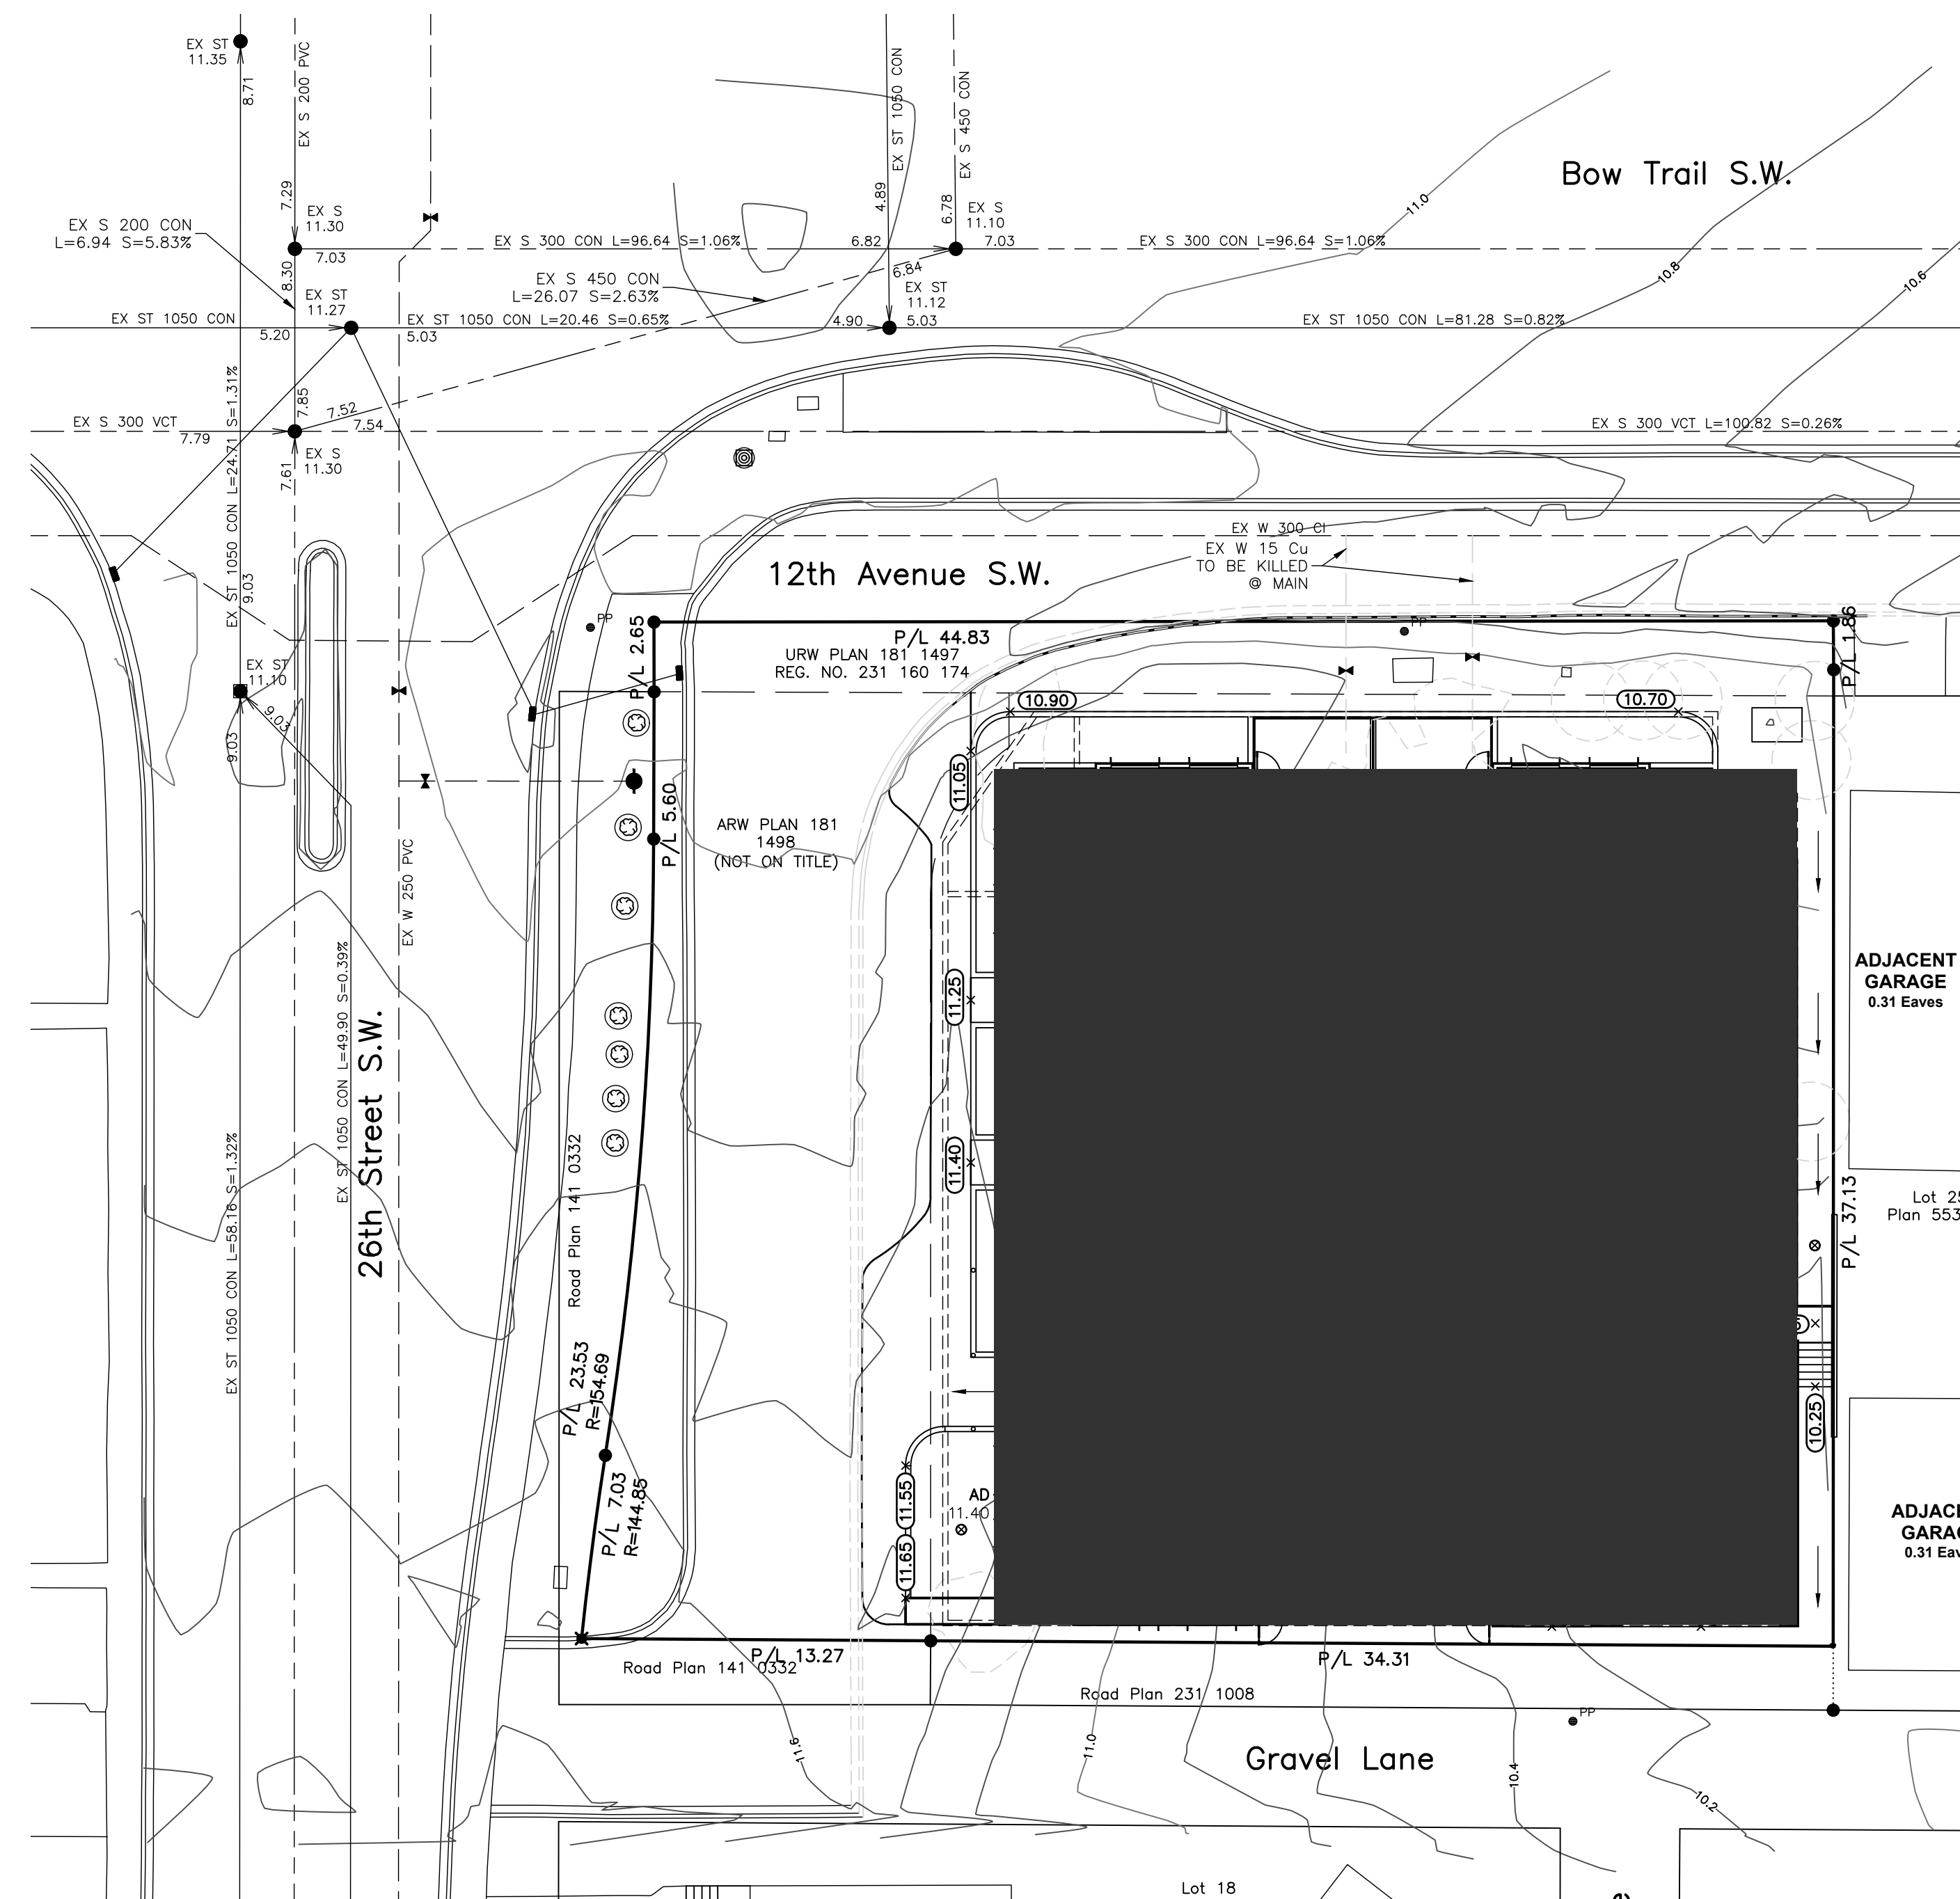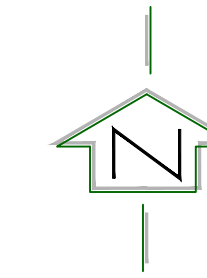

MUNICIPAL ADDRESS
????????????????????
Calgary AB

LEGAL DESCRIPTION
LOT ???, BLOCK ?
PLAN ???, 1/4
SEC. 7-?-?-W?M

FOR DEVELOPMENT PERMIT SUBMISSION ONLY.
NOT FOR TENDER OR CONSTRUCTION.

ONWARD SHAGANAPPI

1406 26 SHREET SE, CALGARY, AB

ISSUED FOR DEVELOPMENT PERMIT
MARCH 06, 2026

- NOTES:
- DIMENSION TO FACE OF STUD (INTERIOR PARTITIONS), CONCRETE, CONCRETE BLOCK, EXTERIOR WALL SHEATHING - UNLESS NOTED OTHERWISE
 - NOTE WHEN REQUIRED MINIMUM CLEAR DIMENSIONS WILL BE IDENTIFIED
 - VERIFY ALL DIMENSIONS, ELEVATIONS, AND DATUM; REPORT ANY ERRORS AND/OR DISCREPANCIES TO THE ARCHITECT PRIOR TO CONSTRUCTION.
 - DO NOT SCALE DRAWINGS.
 - THIS DRAWING SUPERCEDES PREVIOUS ISSUES.

| |
|-------------------|
| Project Component |
| Key Plan |

Seal(s)

CTZN Architecture Inc.
1610 19 AVENUE NW
CALGARY, AB
T2M 1B1
P: 403-861-6930

AES
Designing A Better Tomorrow
1520 - 639 9th Avenue SW, Calgary, AB T2P 0M9
403.250.6800 | www.aeseng.com
CALGARY | KELLOWNA | MANICOUVER | VICTORIA



| LIGHTING COMPLIANCE DOCUMENTATION | | | |
|---|-----|----|-----|
| CODE | YES | NO | N/A |
| ASHRAE 90.1-2018 | | | X |
| NECB 2020 | X | | |
| COMPLIANCE PATH | | | |
| PRESCRIPTIVE | | | |
| SPACE BY SPACE | | | |
| BUILDING AREA | X | | |
| PERFORMANCE | | | |
| INDEPENDENT PROVISIONS CHECKLIST | | | |
| LIGHTING CONTROLS | | | |
| AUTOMATIC LIGHTING SHUTOFF CONTROLS ARE PROVIDED BASED ON EITHER A SCHEDULING DEVICE OR AN OCCUPANT SENSOR | | | |
| EACH ENCLOSED SPACE HAS ITS OWN CONTROL INCLUDING BI-LEVEL OR OCCUPANCY BASED WHERE REQUIRED | | | |
| CONTROLS FOR PARKING GARAGES, INCLUDING BI-LEVEL, TRANSITION AND PERIMETER CONTROL AS REQUIRED. | | | |
| AUTOMATIC DAYLIGHTING CONTROLS FOR PRIMARY SIDELIGHTED AREAS | | | |
| AUTOMATIC DAYLIGHTING CONTROLS FOR TOPLIGHTING | | | |
| ADDITIONAL CONTROLS FOR DISPLAY/ACCENT, CASE, GUEST ROOM, TASK, NONVISUAL AND DEMONSTRATION LIGHTING APPLICATIONS | | | |
| EXTERIOR DIM TO DIM UPON VACANCY OF AREA AFTER 15 MINUTES, DIM TO FULL UPON MOTION, AUTOMATIC OFF UPON DAYLIGHT. | | | |
| | X | | |
| EXIT SIGNS DO NOT EXCEED SW PER FACE | | | |
| INTERIOR LIGHTING POWER BELOW ALLOWABLE LPD | | | |
| | X | | |
| EXTERIOR LIGHTING POWER BELOW ALLOWABLE LPD | | | |
| | X | | |
| FUNCTIONAL TESTING TO BE PERFORMED BY FACTORY CERTIFIED TECHNICIAN | | | |
| | X | | |

| DRAWING LIST | |
|--------------|-----------------------------------|
| E-0.0 | COVER PAGE |
| E-1.0 | ELECTRICAL SITE LAYOUT |
| E-1.1 | ELECTRICAL SITE PHOTOMETRY LAYOUT |

| ELECTRICAL SYMBOL LEGEND | |
|--------------------------|---|
| ABBREVIATIONS | |
| NOTE | EQUIPMENT SHOWN DOTTED IS EXISTING AND TO REMAIN UNLESS INDICATED OTHERWISE |
| WP | DENOTES WEATHER PROOF DEVICE |
| SINGLE LINE | |
| — | FEDER/CONDUCTOR |
| — | BUSBAR/CDP |
| — | GANG OPERATED DISCONNECT SWITCH |
| — | BREAKER |
| — | FUSE |
| — | FUSED DISCONNECT |
| — | METERING TRANSFORMER |
| — | SERVICE PROVIDER METER |
| — | RELAY |
| LIGHTING | |
| □ | SURFACE MOUNTED LUMINAIRE |
| ○ | RECESSED DOWN LIGHT, ARROW IF DIRECTIONAL |
| ○ | WALL MOUNTED LUMINAIRE |
| ○ | RECESSED WALL MOUNTED LUMINAIRE |
| — | SURFACE MOUNTED LINEAR LUMINAIRE |
| — | LANDSCAPE LUMINAIRE |
| ◇ | PHOTOCELL |
| ⊕ | OCCUPANCY SENSOR, CEILING MOUNTED |

| | | |
|------------|--------------------|---|
| 2026-03-06 | DEVELOPMENT PERMIT | 1 |
|------------|--------------------|---|

| DATE | ISSUED FOR | REV |
|------|------------|-----|
|------|------------|-----|

| | |
|--|-------------|
| Client | |
| ONWARD HOMES SOCIETY | |
| 500, 1414 8 STREET SW, CALGARY, AB T2R 1J6 | |
| Project | |
| ONWARD SHAGANAPPI | |
| 1406 26 STREET SW, CALGARY, AB | |
| PLAN 231009, BLOCK 5, LOT 55 | |
| Drawing Title | |
| COVER PAGE | |
| Project Manager | DK |
| Drawn | YC / JW |
| Project Leader | MB |
| Checked | DK |
| Scale | |
| AS SHOWN | |
| Project No. | CTZN24-0007 |
| AES Project No. | 0325.0163 |
| Drawing No. | E-0.0 |

PRELIMINARY - NOT FOR CONSTRUCTION

LANDSCAPE REQUIREMENTS:

LANDSCAPE AREA CALCULATION:

TOTAL SITE AREA: 1771.90m²
 WEST SETBACK LANDSCAPE AREA: 46.9m²
 1 TREE/45m² = 2 TREES
 1 SHRUB/45m² = 4 SHRUBS

TREES PROVIDED


| | |
|---------------------------|----------|
| TOTAL TREES PROVIDED - 06 | |
| DECIDUOUS TREES | PROVIDED |
| 50mm CAL. | 02 |
| 75mm CAL. | 02 |
| TOTAL | 4 |

CONIFEROUS TREES


| | |
|---------|---|
| 3.0m Ht | 2 |
| 2.0m Ht | 0 |
| TOTAL | 2 |

PERCENTAGE OF CONIFEROUS TREES PROVIDED: 50%
 TOTAL NUMBER OF SHRUBS PROVIDED: 54

PLANT LEGEND:

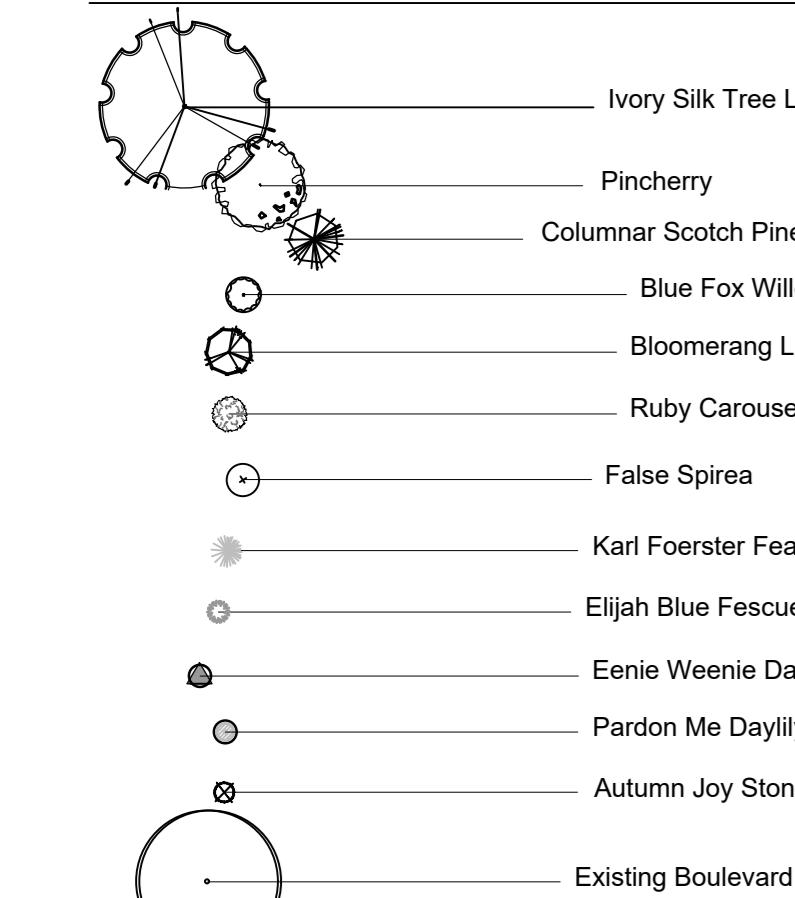

LEGEND:

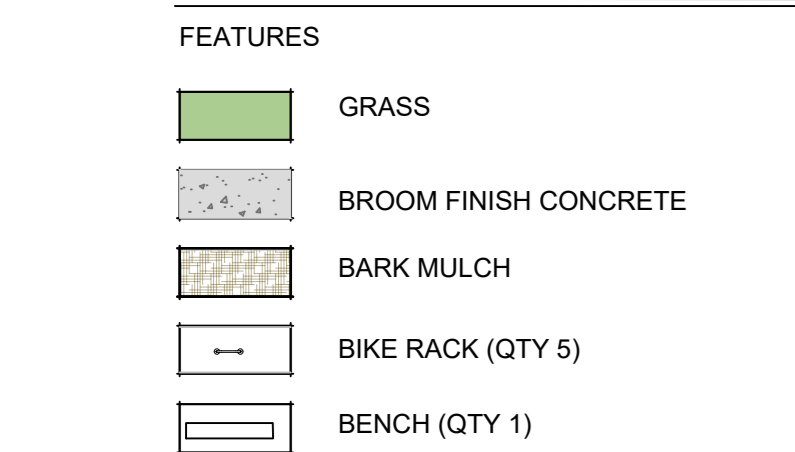

GENERAL NOTES:

- ALL PLANT MATERIAL SHALL CONFORM TO THE STANDARDS OF THE CANADIAN NURSERY TRADES ASSOCIATION FOR NURSERY STOCK.
- WARRANTY ON ALL LANDSCAPE TO BE TWO YEARS FROM DATE OF ACCEPTANCE.
- CONTRACTOR TO CO-ORDINATE WORK WITH ALL OTHER CONTRACTORS ON SITE.
- CONTRACTOR SHALL VERIFY ALL SITE CONDITIONS AT TIME OF CONSTRUCTION.
- CONTRACTOR TO VERIFY ALL UNDERGROUND SERVICES PRIOR TO ANY WORK.
- DURING CONSTRUCTION, ANY DAMAGE OCCURRING TO PUBLIC LANDS, RESULTING FROM ENCROACHMENT WILL BE MADE GOOD AT TIME OF CONSTRUCTION.
- ALL EXISTING TREES WITHIN 6.0m OF CONSTRUCTION TO BE PROTECTED WITH A TREE PROTECTION FENCE ALONG THE DRIFLINE.
- NEW TREE LOCATIONS TO BE STAKED BY THE CONTRACTOR AND APPROVED BY THE LANDSCAPE ARCHITECT PRIOR TO ANY INSTALLATION.
- TREES SHALL BE WATERED IN FOR THE WINTER TO ENSURE THAT THE ROOTS ARE FROZEN. TREES SHALL BE REGULARLY CHECKED IN WINTER TO ENSURE THAT ROOTS ARE STILL FROZEN. IF THE WINTER WEATHER VARIES TO PLUS TEMPERATURES WATERING OF THE TREES SHALL BE DONE BY WATER TRUCK TO ENSURE HEALTHY PLANT MATERIAL.
- CONTRACTOR TO ENSURE ADEQUATE SUPPORT FOR ALL PLANT MATERIAL NOTED ON DRAWINGS.
- ANY SUBSTITUTIONS OF PLANT MATERIAL TO BE APPROVED BY THE LANDSCAPE ARCHITECT PRIOR TO THE SUBSTITUTIONS BEING MADE.
- ANY DAMAGE TO EXISTING HARD AND SOFT SURFACING TO BE MADE GOOD BY THE CONTRACTOR.
- ALL TREE AND SHRUB BEDS TO BE MULCHED WITH 75mm BARK MULCH.
- TREES NOT PLANTED IN BEDS SHALL BE SURROUNDED BY A TREE WELL TO A DEPTH OF 100MM AFTER PLANTING AND WATERING. ALL TREES TO BE MULCHED STARTING 50MM FROM THE ROOT FLARE (TRUNK) AND EXTENDING THE LENGTH OF HOLE.
- SOIL DEPTHS FOR PLANT MATERIAL:
 FOR TREES - 1200mm MIN
 FOR SHRUBS - 600mm MIN
 FOR PERENNIALS - 300mm MIN
- ANY DAMAGE OCCURRING TO THE EXISTING CONSTRUCTION, BUILDINGS, VEGETATION, LANDSCAPING, PATHWAYS AND/OR OTHER SITE AMENITIES ON THE SITE, ADJACENT PRIVATE PROPERTY OR PUBLIC LANDS SHALL BE REHABILITATED, RESTORED AND/OR MADE GOOD, BY THE CONTRACTOR TO THE OWNERS AND/OR THE CITY OR TOWN AUTHORITY'S REQUIREMENTS.
- ALL SITE GRADES SHALL MATCH EXISTING GRADES OF ADJACENT LANDS, WITH GRADING CONFINED TO THE SITE. SEE CIVIL PLAN FOR GRADING, CURB AND SERVICES INFORMATION.
- THE CONTRACTOR SHALL OBTAIN, AT THE CONTRACTOR'S SOLE EXPENSE, ALL UTILITY LOCATES PRIOR TO COMMENCING WORK. ANY AND ALL DAMAGES TO UTILITIES, REGARDLESS OF WHETHER LOCATES WERE COMPLETED, SHALL BE REHABILITATED, RESTORED AND/OR MADE GOOD BY THE CONTRACTOR, TO THE OWNERS AND/OR THE CITY OR TOWN AUTHORITY'S REQUIREMENTS.
- ANY DISCREPANCIES BETWEEN SITE CONDITION AND THOSE ON THE DRAWING TO BE REPORTED IMMEDIATELY TO THE CONSULTANT AT TIME OF CONSTRUCTION.

PLANT LIST:

CONIFEROUS TREES

| QTY | SCIENTIFIC NAME | COMMON NAME | PLANT SIZE |
|-----|-------------------------------------|----------------------|------------------------------------|
| 05 | <i>Pinus sylvestris</i> 'Fastigiat' | Columnar Scotch Pine | 3.0m Ht. B&B, 900mm root ball dia. |

DECIDUOUS TREES

| QTY | SCIENTIFIC NAME | COMMON NAME | PLANT SIZE |
|-----|--|-----------------------|---|
| 02 | <i>Prunus pennsylvanica</i> | Pincherry | 65mm cal. (B&B), min 850mm wide x 600mm depth root ball |
| 02 | <i>Syringa reticulata</i> 'Ivory Silk' | Ivory Silk Tree Lilac | 65mm cal. (B&B), min 750mm wide x 600mm depth root ball |

DECIDUOUS SHRUBS

| QTY | SCIENTIFIC NAME | COMMON NAME | PLANT SIZE |
|-----|--------------------------------------|------------------------|---|
| 14 | <i>Berberis thunbergii</i> 'Ballone' | Ruby Carousel Barberry | Min. 600mm Ht., Min. 4 major basal stems. Root Spread 300mm. - #2 cont. |
| 10 | <i>Salix brachycarpa</i> 'Blue Fox' | Blue Fox Willow | Min. 600mm Ht., Min. 4 major basal stems. Root Spread 300mm. - #2 cont. |
| 19 | <i>Sorbaria sorbifolia</i> | False Spirea | Min. 600mm Ht., Min. 4 major basal stems. Root Spread 300mm. - #2 cont. |
| 09 | <i>Syringa</i> 'Bloomerang' | Bloomerang Lilac | Min. 600mm Ht., Min. 4 major basal stems. Root Spread 300mm. - #2 cont. |

ORNAMENTAL GRASSES

| QTY | SCIENTIFIC NAME | COMMON NAME | PLANT SIZE |
|-----|---|----------------------------------|--------------------------|
| 18 | <i>Calamagrostis acutiflora</i> 'Karl Foerster' | Karl Foerster Feather Reed Grass | Min. 200mm Ht., #2 cont. |
| 23 | <i>Festuca ovina glauca</i> 'Elijah Blue' | Elijah Blue Fescue | Min. 200mm Ht., #2 cont. |

PERENNIALS

| QTY | SCIENTIFIC NAME | COMMON NAME | PLANT SIZE |
|-----|--------------------------------------|------------------------|------------------------|
| 14 | <i>Hemerocallis</i> x 'Eenie Weenie' | Eenie Weenie Daylily | Min. 200mm Ht., #1 ppt |
| 28 | <i>Hemerocallis</i> x 'Pardon Me' | Pardon Me Daylily | Min. 200mm Ht., #1 ppt |
| 06 | <i>Sedum spectabile</i> 'Autumn Joy' | Autumn Joy Stonerocrop | Min. 200mm Ht., #1 ppt |

NOTES:

- ALL TREE AND SHRUB BEDS TO BE MULCHED WITH 75mm BARK MULCH.
- TREES NOT PLANTED IN BEDS SHALL BE SURROUNDED BY A TREE WELL TO A DEPTH OF 100MM AFTER PLANTING AND WATERING. ALL TREES TO BE MULCHED STARTING 50MM FROM THE ROOT FLARE (TRUNK) AND EXTENDING THE LENGTH OF HOLE.
- THE DELIVERY OF THE IRRIGATED WATER IS CONFINED TO TREES AND SHRUBS AREAS ARE IRRIGATED BY A LOW WATER IRRIGATION SYSTEM.

PLANTING NOTES

- ALL PLANT MATERIAL SHALL BE INSTALLED IN ACCORDANCE WITH THE CURRENT CITY OF CALGARY PARKS STANDARDS AND GUIDELINES (CURRENT EDITION).
- THE OWNER'S REPRESENTATIVE WILL INSPECT PLANTS AT THE FOLLOWING STAGES, AT TIME OF DELIVERY PRIOR TO INSTALLATION, INSTALLED PLANTS BEFORE COMMENCEMENT OF MAINTENANCE PERIOD AND AT THE END OF MAINTENANCE PERIOD. NOTIFY OWNER'S REPRESENTATIVE 72 HOURS IN ADVANCE OF EACH REQUIRED INSPECTION. CONTRACTOR SHALL ENSURE REQUIRED PLANTS WILL BE AVAILABLE OR MEET SPECIFICATIONS BEFORE ARRANGING INSPECTION FOR SELECTION AND TAGGING OF PLANTS.
- ALL PLANT MATERIAL TO BE DISEASE FREE AND TRUE TO FORM. SPECIMEN GRADE SINGLE STEM STOCK - UNLESS NOTED OTHERWISE, PLANTS WILL BE REJECTED IF: SOIL BALLS HAVE BEEN CRACKED OR BROKEN BEFORE OR DURING PLANTING OR WHEN BURLAP ROPES REQUIRED IN CONNECTION WITH THEIR TRANSPORTING HAVE BEEN REMOVED. DO NOT USE PLANTS DAMAGED DURING CONTACT WITH EQUIPMENT, OR PLANTS THAT ARE WILTED, WIND BURNED OR STRESSED. CONTRACTOR TO REPLACE DAMAGED OR REJECTED PLANTS AT NO ADDITIONAL COST TO OWNER.
- STAKE OUT LOCATIONS OF TREES, SHRUBS AND PLANTING BEDS. LOCATIONS OF ALL PLANTS SHALL BE REVIEWED AND APPROVED BY OWNER'S REPRESENTATIVE ON SITE BEFORE PLANTING. PLANTS INSTALLED WITHOUT REVIEW AND APPROVAL MAY REQUIRE TRANSPORTING OR RELOCATION AS DIRECTED BY OWNER'S REPRESENTATIVE AT NO ADDITIONAL COST.
- CONTRACTOR SHALL VERIFY THAT ALL MINIMUM CLEARANCES ARE PROVIDED BETWEEN PROPOSED TREES AND UNDERGROUND AND/OR OVERHEAD UTILITIES AS DEFINED BY THE LOCAL PARKS AND PLANNING DEPARTMENT.
- PART OF PLANT MATERIAL INSTALLATION SHALL INCLUDE SUFFICIENT PROTECTION TO PREVENT BARK AND TREE DAMAGE DUE TO FORAGING ANIMALS AND ANCHORING SYSTEM TO PREVENT ROOT BREAKAGE DUE TO STRONG WINDS. LANDSCAPE ARCHITECT NOT RESPONSIBLE FOR ANY DAMAGES THAT ARISE DUE TO IMPROPER INSTALLATION.
- ALL DEVELOPMENT AND CONSTRUCTION ACTIVITIES WITHIN 5 METERS OF EXISTING VEGETATION MUST BE SUPERVISED BY AN ISA (INTERNATIONAL SOCIETY OF ARBORICULTURE) CERTIFIED ARBORIST. ALL PRUNING OF EXISTING VEGETATION MUST BE SUPERVISED BY AN ISA CERTIFIED ARBORIST.
- NO TREES, SHRUBS, BUILDINGS, PERMANENT STRUCTURES OR UNAUTHORIZED GRADE CHANGES ARE PERMITTED WITHIN THE UTILITY RIGHTS-OF-WAY.

LANDSCAPE REMEDIATION


- ANY TURF AREAS DISTURBED DURING THE CONSTRUCTION PROCESS ARE TO BE AMENDED WITH A MINIMUM OF 150 MM DEPTH TOPSOIL AND SOD, AS PER THE CITY OF CALGARY DESIGN STANDARDS.
- ANY PLANTING BEDS DISTURBED DURING CONSTRUCTION ARE TO BE AMENDED WITH A MINIMUM OF 450 MM DEPTH TOPSOIL AND A MINIMUM OF 150 MM DEPTH WOOD CHIP MULCH, AS PER THE CITY OF CALGARY DESIGN STANDARDS.
- ANY PLANT MATERIAL DAMAGED DURING CONSTRUCTION IS TO BE REMOVED, DISPOSED OF, AND REPLACED BY THE CONTRACTOR. ANY REPLACEMENT PLANT MATERIAL MUST BE THE SAME SPECIES OF THE REMOVED ITEM.

EXISTING LANDSCAPE

- LOCATIONS AND SIZES OF EXISTING PLANT MATERIAL ARE APPROXIMATE.


GRADING NOTES:

- REFER TO CIVIL ENGINEERING DRAWINGS FOR GRADING INFORMATION.

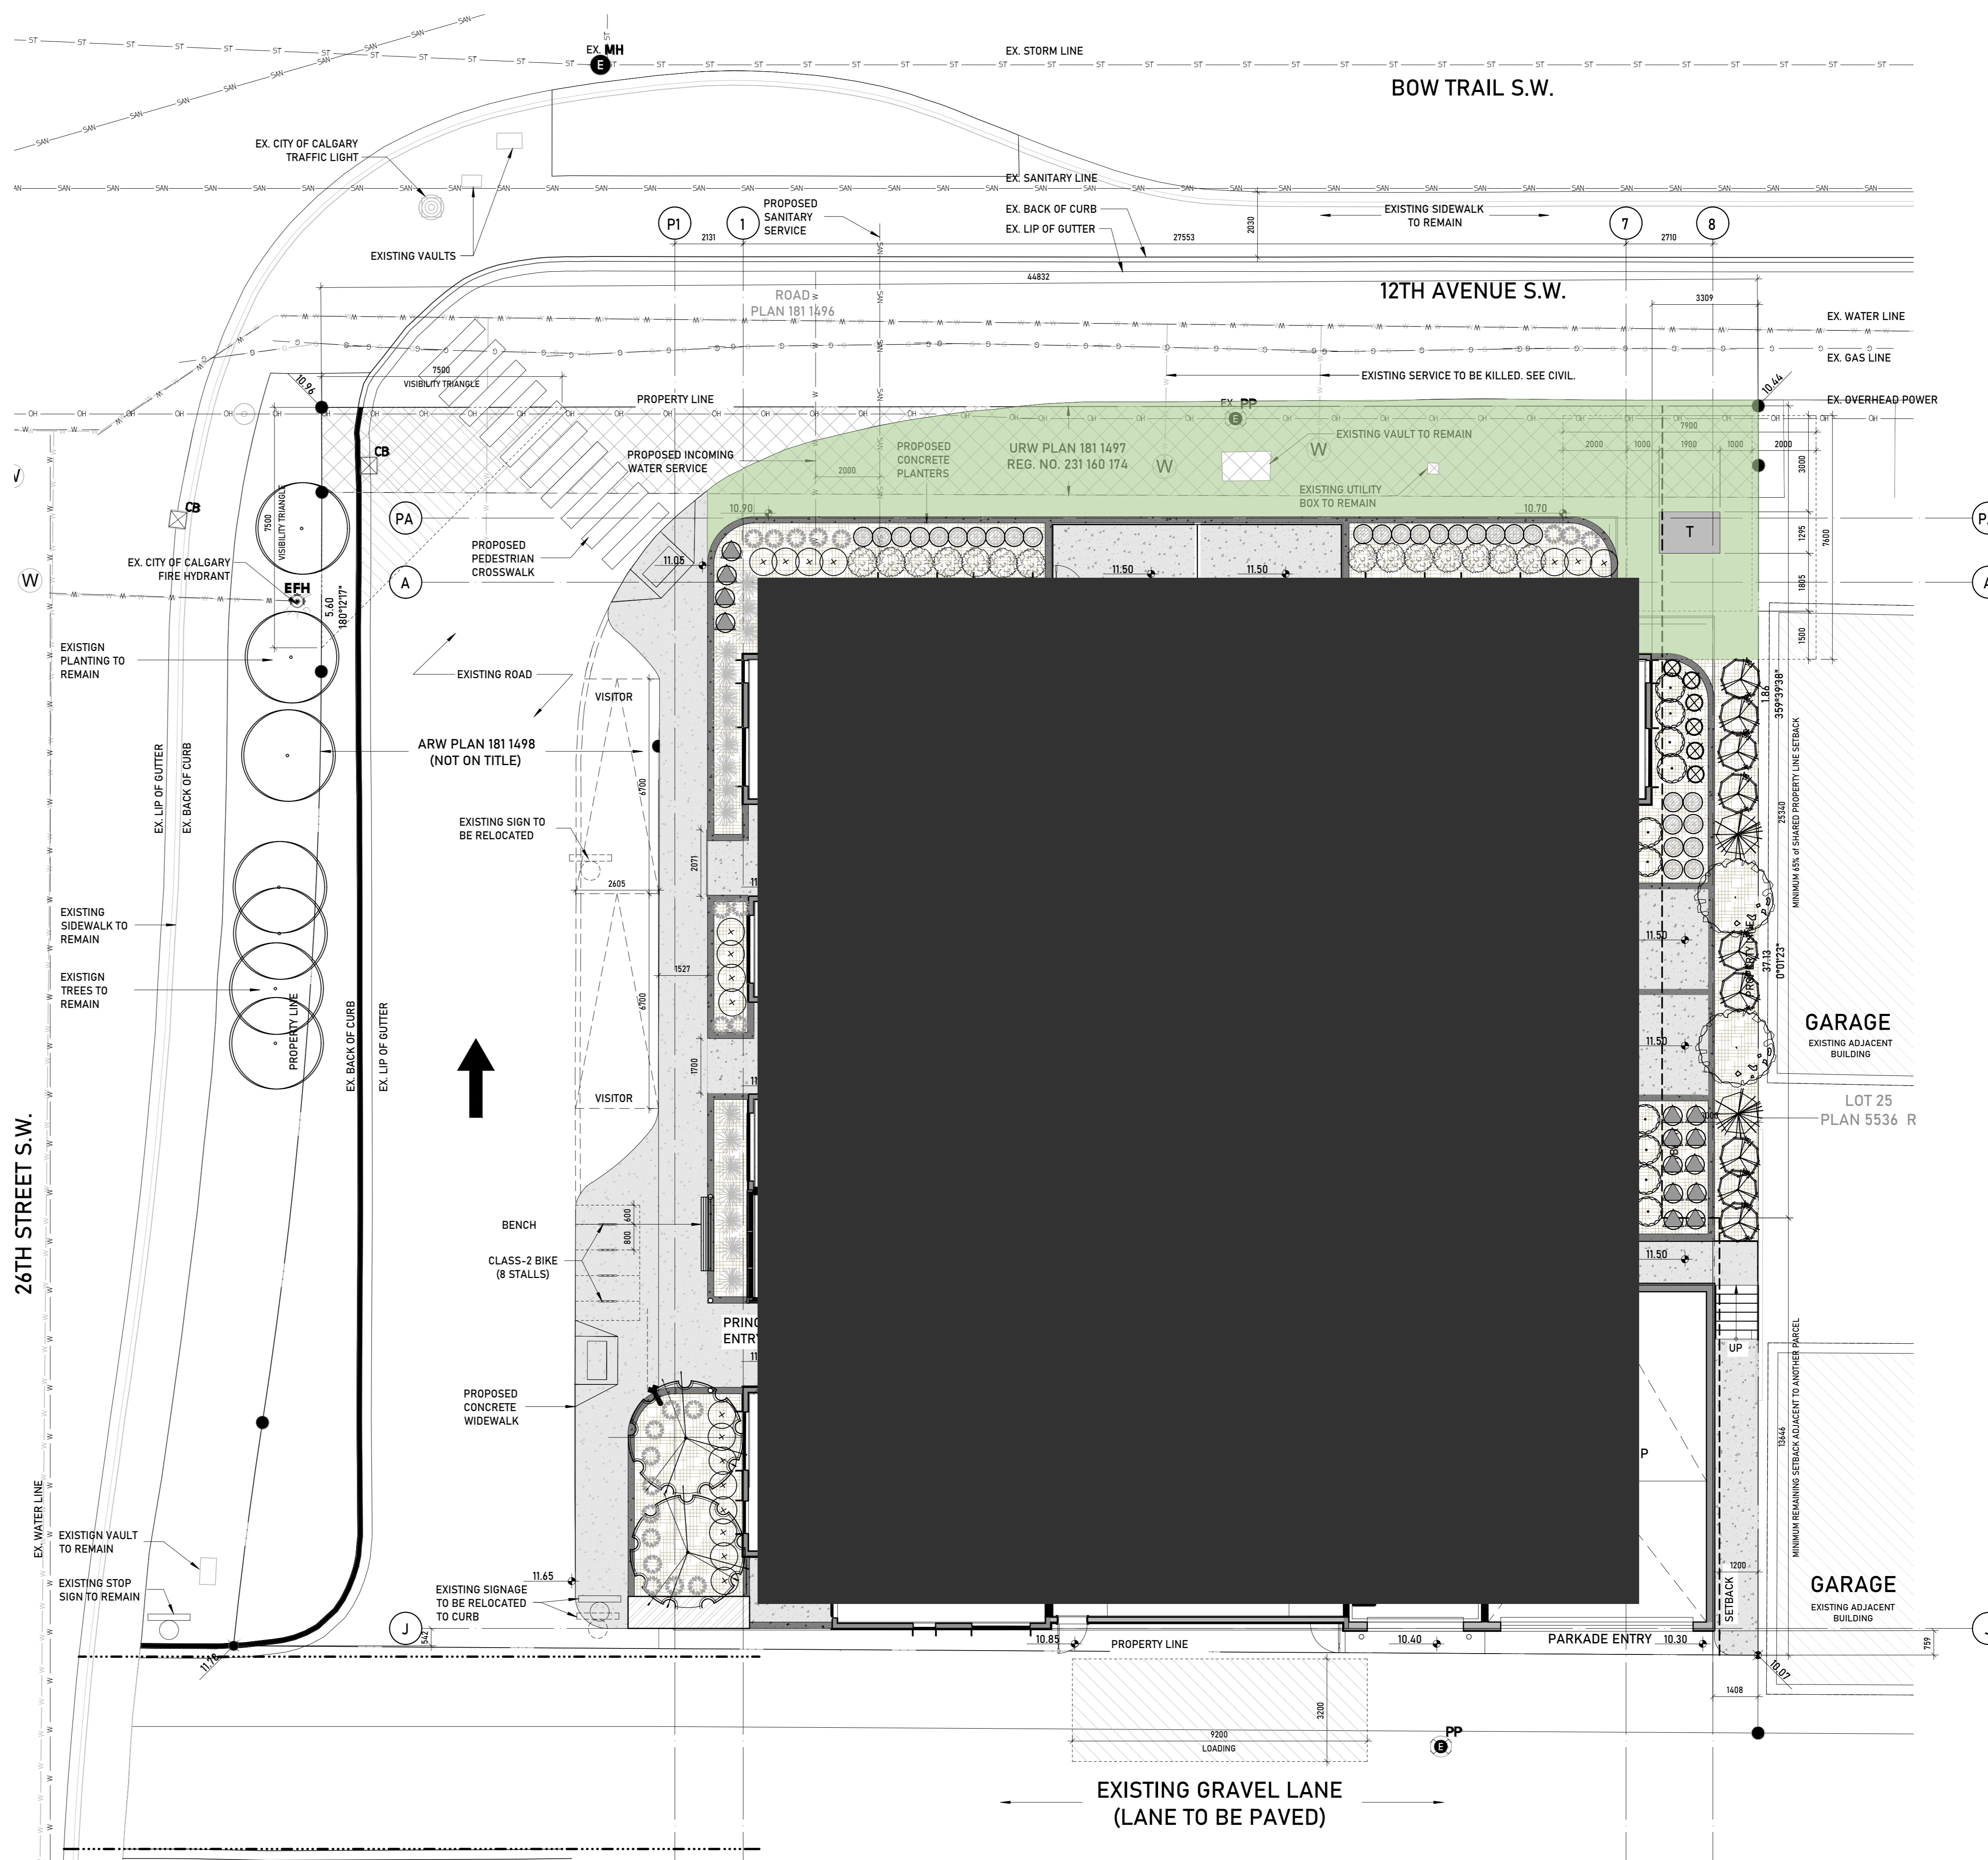

- NOTES:
- DIMENSION TO FACE OF STUD (INTERIOR PARTITIONS), CONCRETE, CONCRETE BLOCK, EXTERIOR WALL SHEATHING - UNLESS NOTED OTHERWISE
 - NOTE WHEN REQUIRED MINIMUM CLEAR DIMENSIONS WILL BE IDENTIFIED.
 - VERIFY ALL DIMENSIONS, ELEVATIONS, AND DATUM REPORT ANY ERRORS AND/OR DISCREPANCIES TO THE ARCHITECT PRIOR TO CONSTRUCTION.
 - DO NOT SCALE DRAWINGS.
 - THIS DRAWING SUPERCEDES PREVIOUS ISSUES.

| | |
|-------------------|--|
| Project Component | |
| Key Plan | |

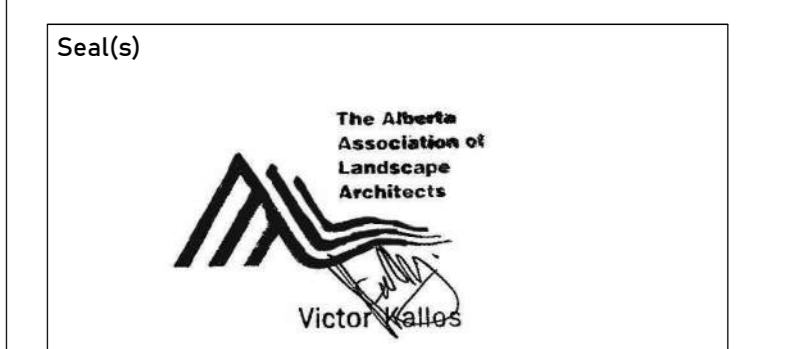

| | |
|---------|--|
| Seal(s) | |
|---------|--|

plAnt studio
 landscape architecture + planning


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| 2026-03-05 | ISSUED FOR DP | 01 |
| DATE | ISSUED FOR | REV |

Client

Project
ONWARD SHAGANAPPI
 1406 26 Street SW, Calgary, Alberta
 Plan 2310009, Block 5, Lot 55
 Drawing Title
LANDSCAPE PLAN

| | | | |
|-----------------|---------|---------|----|
| Project Manager | CK | Drawn | CK |
| Project Leader | CK | Checked | VK |
| Scale | 1:100 | | |
| Project No. | - | | |
| Drawing No. | DPL1.00 | | |

LANDSCAPE PLAN
 SCALE: 1:100

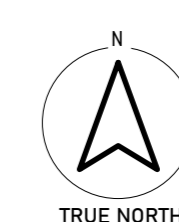


PRELIMINARY - NOT FOR CONSTRUCTION

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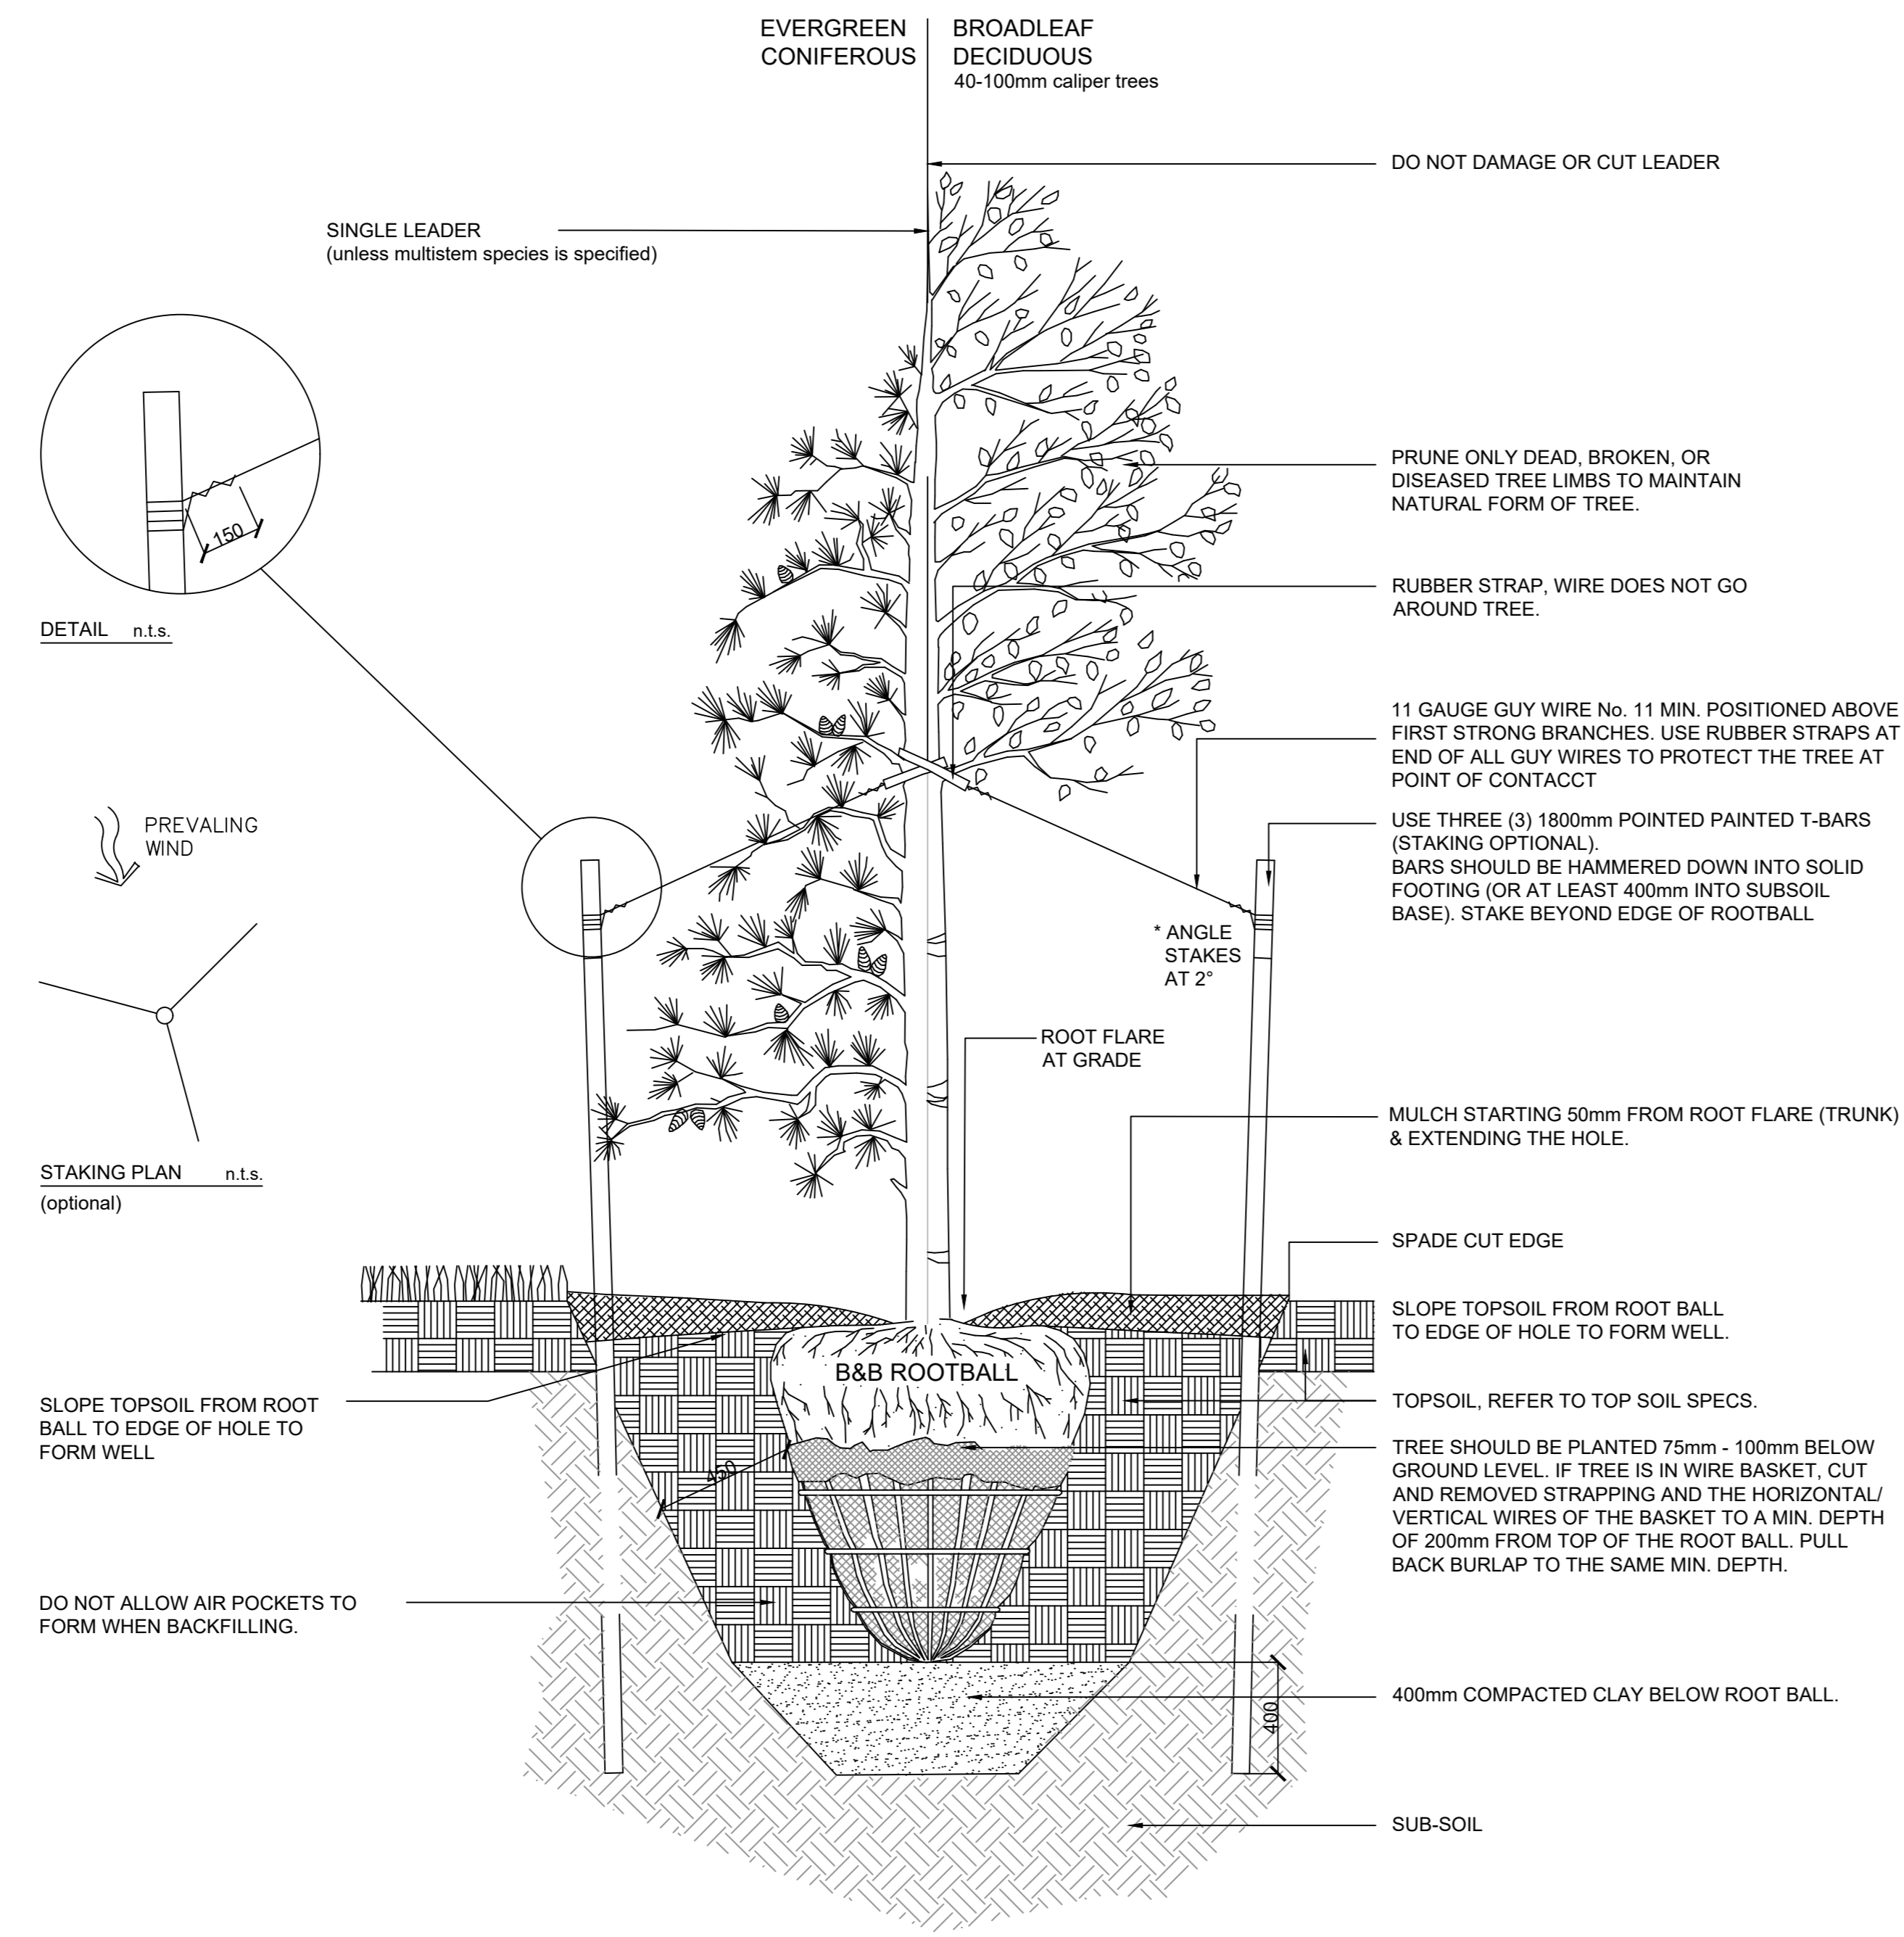
- NOTES:
- DIMENSION TO FACE OF STUD (INTERIOR PARTITIONS), CONCRETE, CONCRETE BLOCK, EXTERIOR WALL SHEATHING - UNLESS NOTED OTHERWISE
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Project Component


Key Plan




plAnt studio
landscape architecture + planning

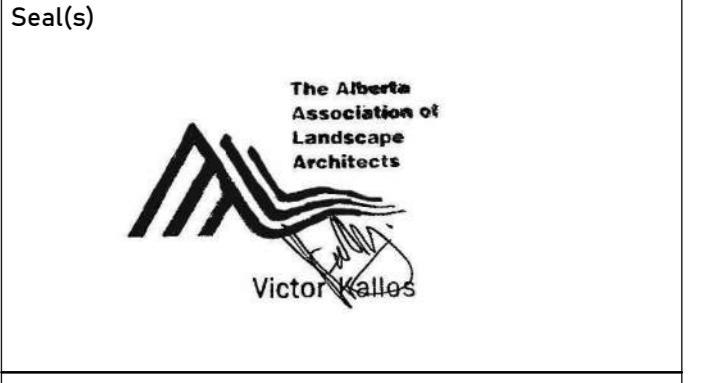


1 TREE PLANTING DETAIL
SCALE: 1:20

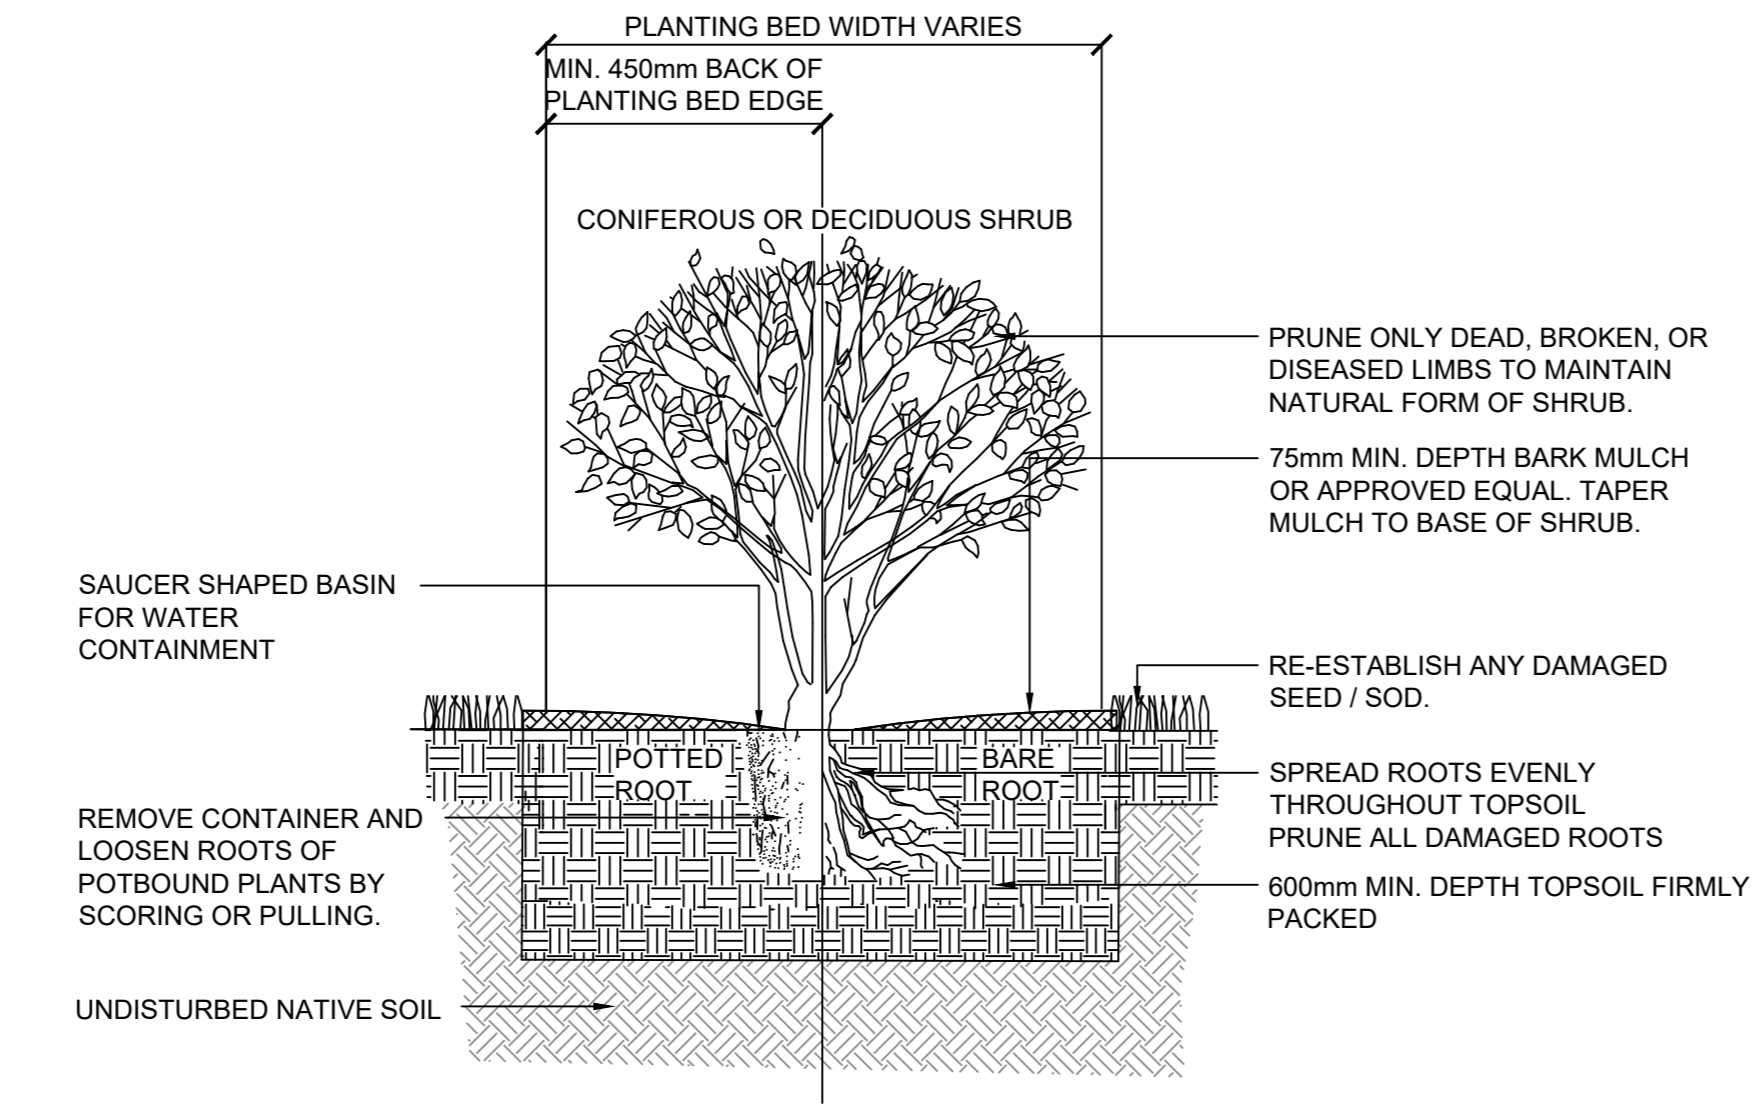

3 SHRUB PLANTING DETAIL
SCALE: 1:20

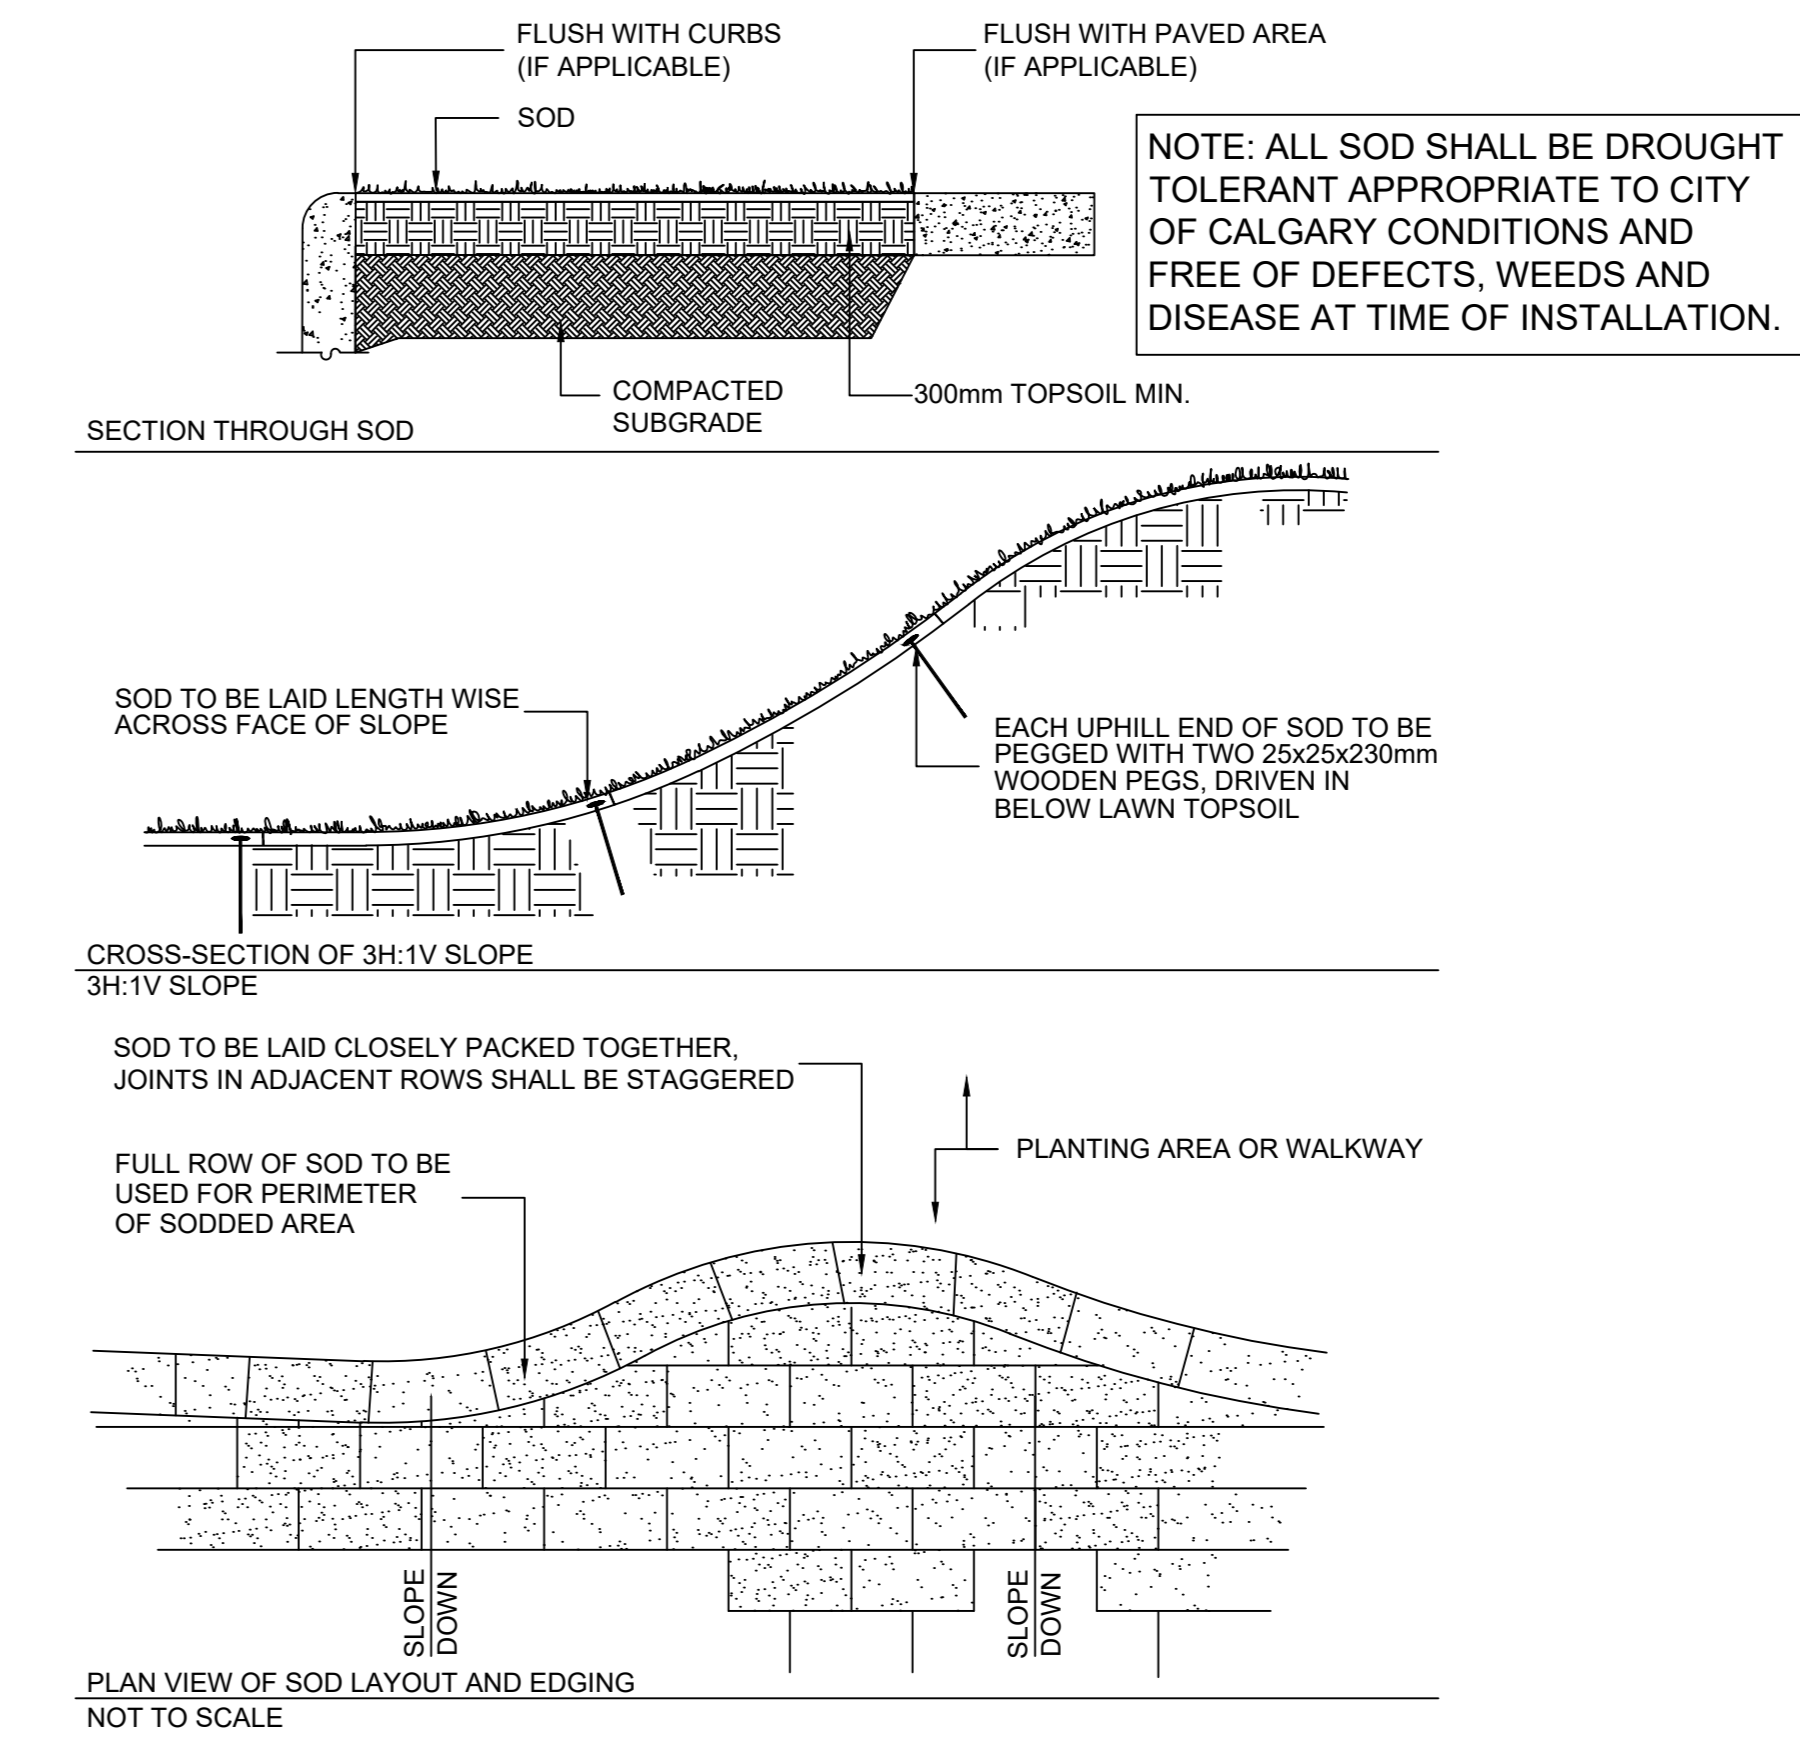

2 SOD INSTALLATION DETAIL
SCALE: 1:20

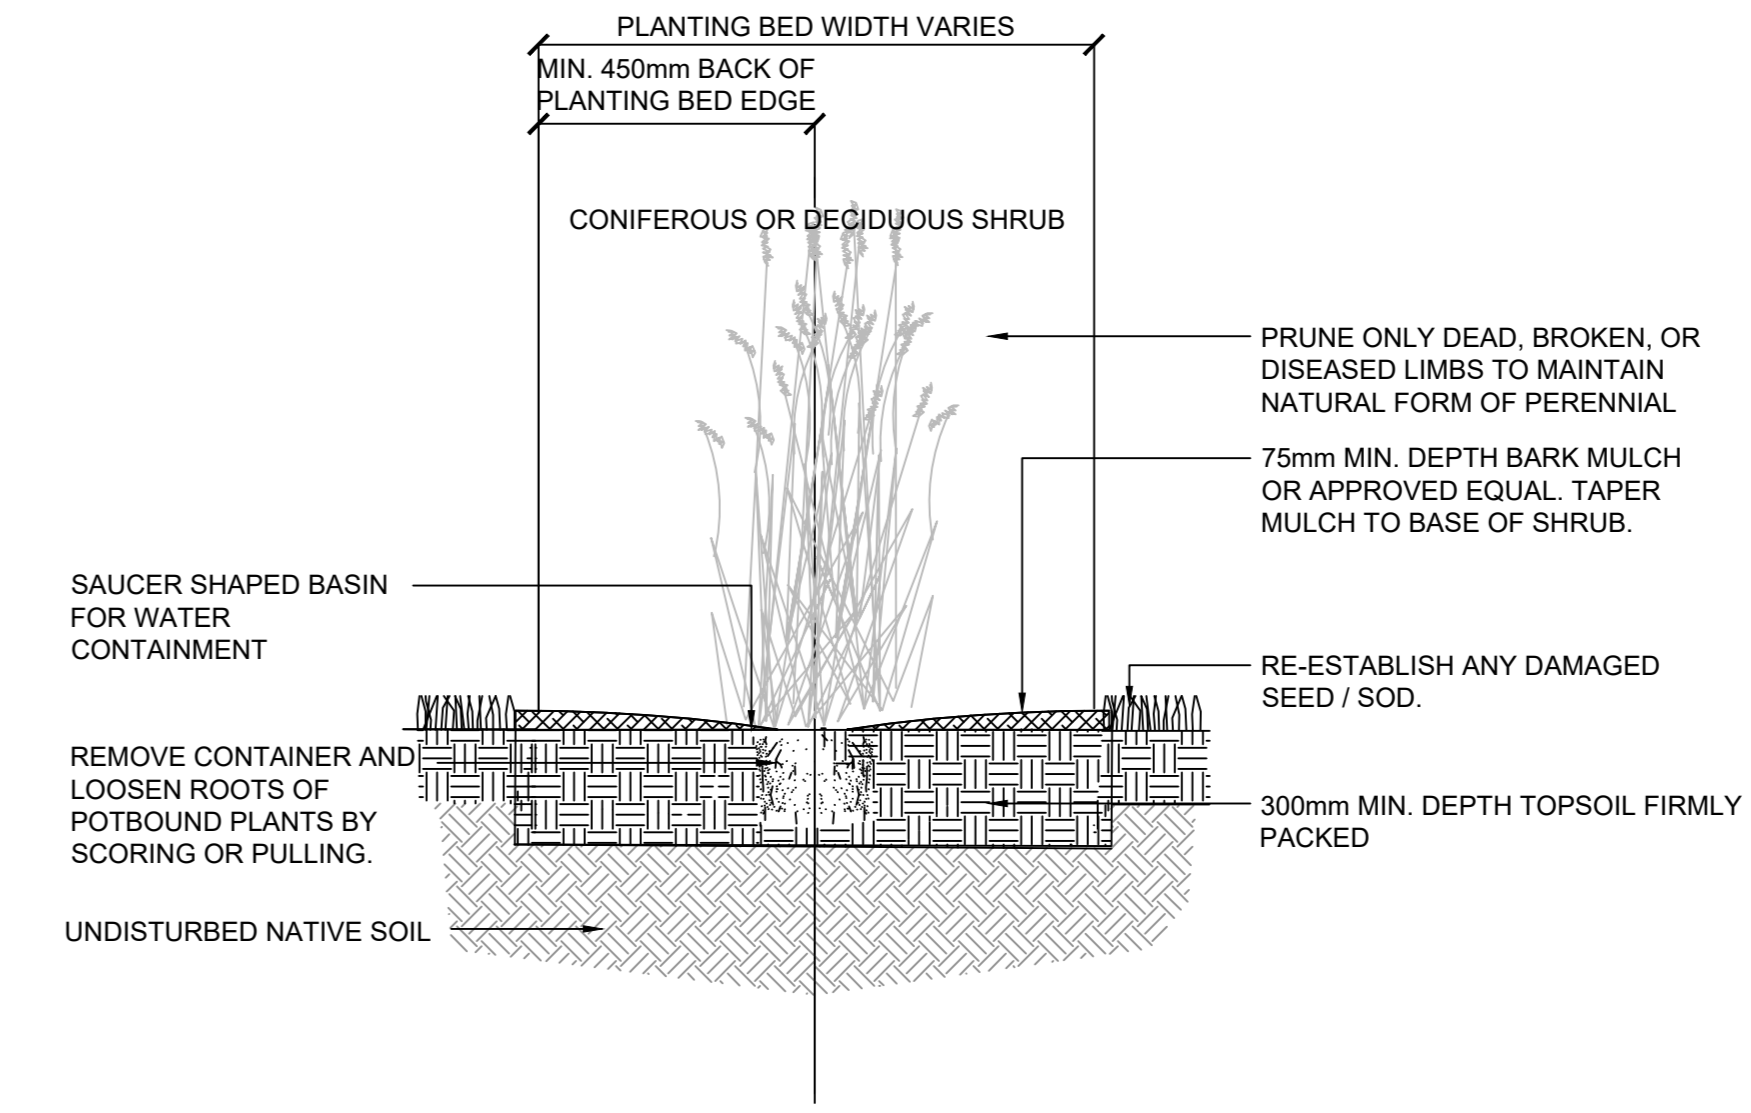

4 PERENNIAL PLANTING DETAIL
SCALE: 1:20

| | | |
|------------|---------------|-----|
| 2026-03-05 | ISSUED FOR DP | 01 |
| DATE | ISSUED FOR | REV |

Client

Project
ONWARD SHAGANAPPI
1406 26 Street SW, Calgary, Alberta
Plan 231009, Block 5, Lot 55

Drawing Title
LANDSCAPE DETAILS


| | |
|------------------------|---------------|
| Project Manager CK | Drawn CK |
| Project Leader CK | Checked VK |
| Scale 1:20 | |
| Project No. - | |
| Drawing No. DPL2.00 | |

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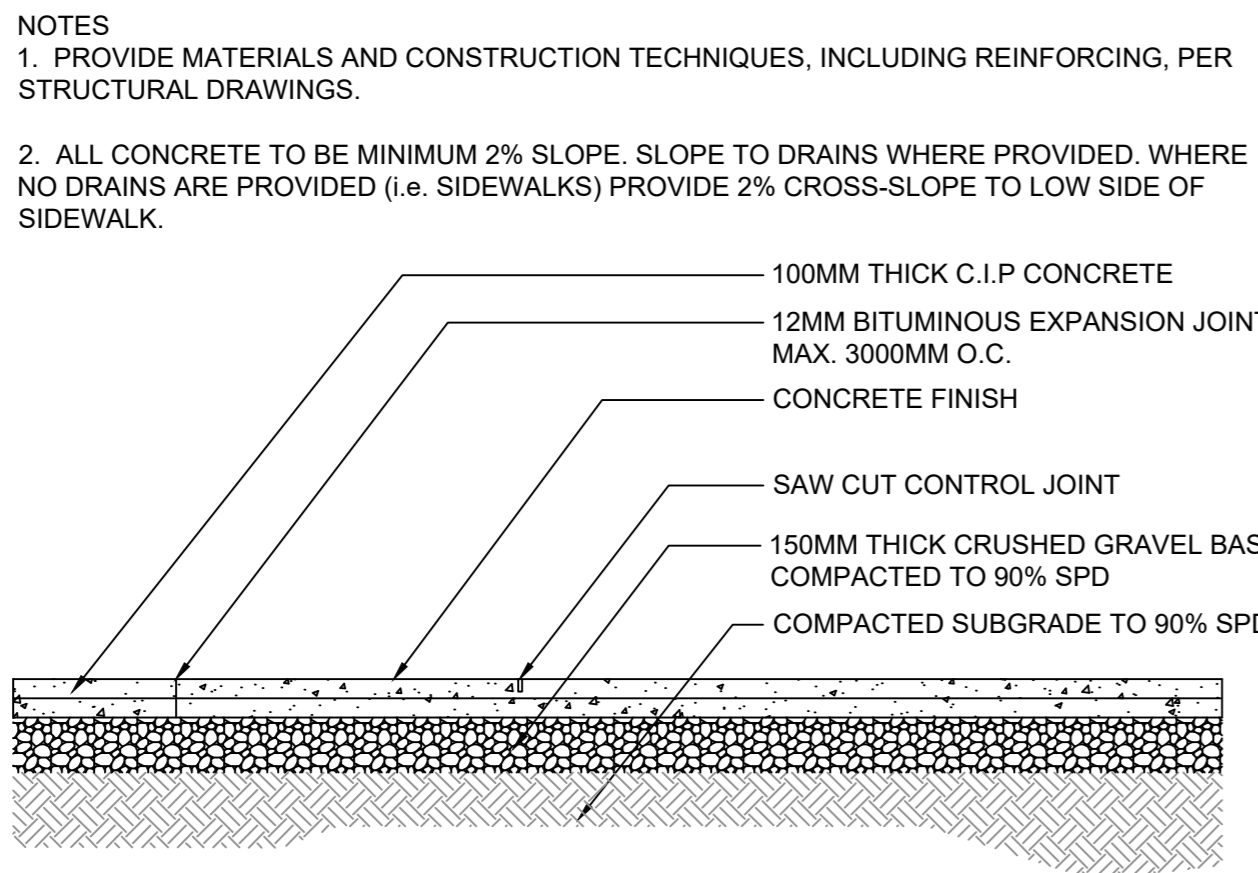
PRELIMINARY - NOT FOR CONSTRUCTION

NOTES:
 - DIMENSION TO FACE OF STUD (INTERIOR PARTITIONS), CONCRETE, CONCRETE BLOCK, EXTERIOR WALL SHEATHING - UNLESS NOTED OTHERWISE
 - NOTE WHEN REQUIRED MINIMUM CLEAR DIMENSIONS WILL BE IDENTIFIED
 - VERIFY ALL DIMENSIONS, ELEVATIONS, AND DATUM REPORT ANY ERRORS AND/OR DISCREPANCIES TO THE ARCHITECT PRIOR TO CONSTRUCTION.
 - DO NOT SCALE DRAWINGS.
 - THIS DRAWING SUPERCEDES PREVIOUS ISSUES.


Project Component
 Key Plan

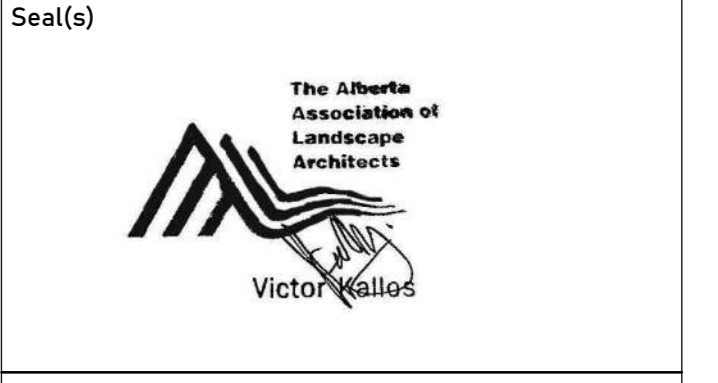

pLant studio
 landscape architecture + planning




1 CONCRETE WALKWAY DETAIL
 SCALE: 1:20

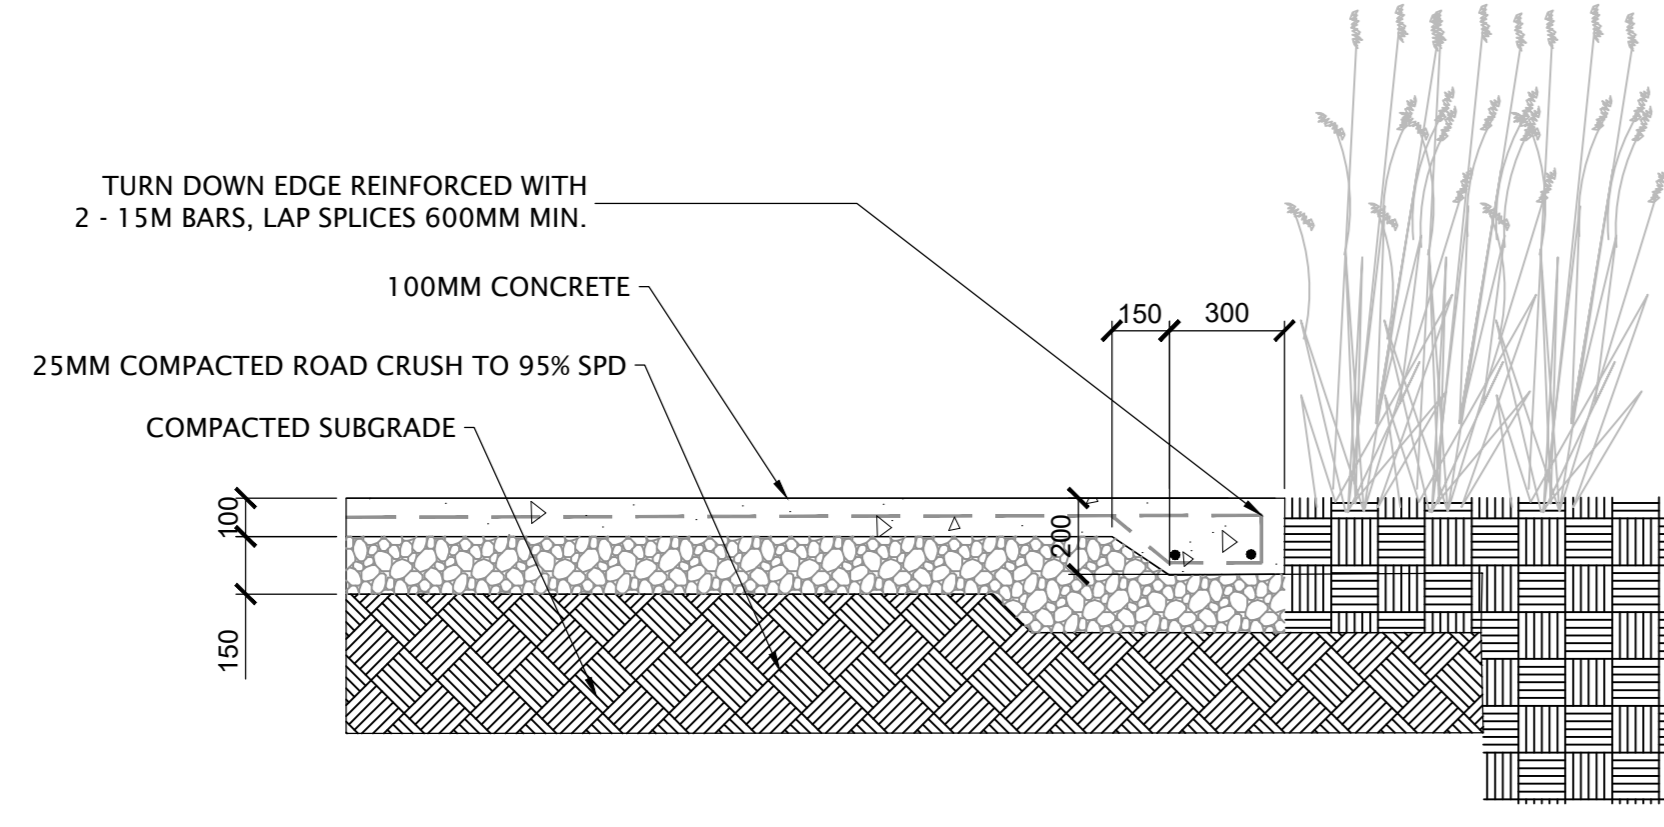


2 CONCRETE EDGE DETAIL
 SCALE: 1:20

- NOTES:
- ALL FENCE & GATE WOOD MEMBERS TO BE SPF NO 1 OR BETTER THAN PTW-FREE OF KNOTS AND BLEMISHES.
 - CONTRACTOR TO PROVIDE SAMPLE OF WOOD FOR APPROVAL PRIOR TO ANY INSTALLATION
 - CONTRACTOR TO USE GALVANIZED SCREWS FOR CONSTRUCTION.
 - CONTRACTOR TO SUPPLY AND INSTALL RUST-PROOF FASTENING HARDWARE (TYP).
 - CONTRACTOR TO PROVIDE A 12" DIA CONCRETE PILE MIN 4' BELOW GRADE DEPTH.
 - CONTRACTOR TO STAIN WOOD TO MATCH EXISTING FENCE ON SITE.

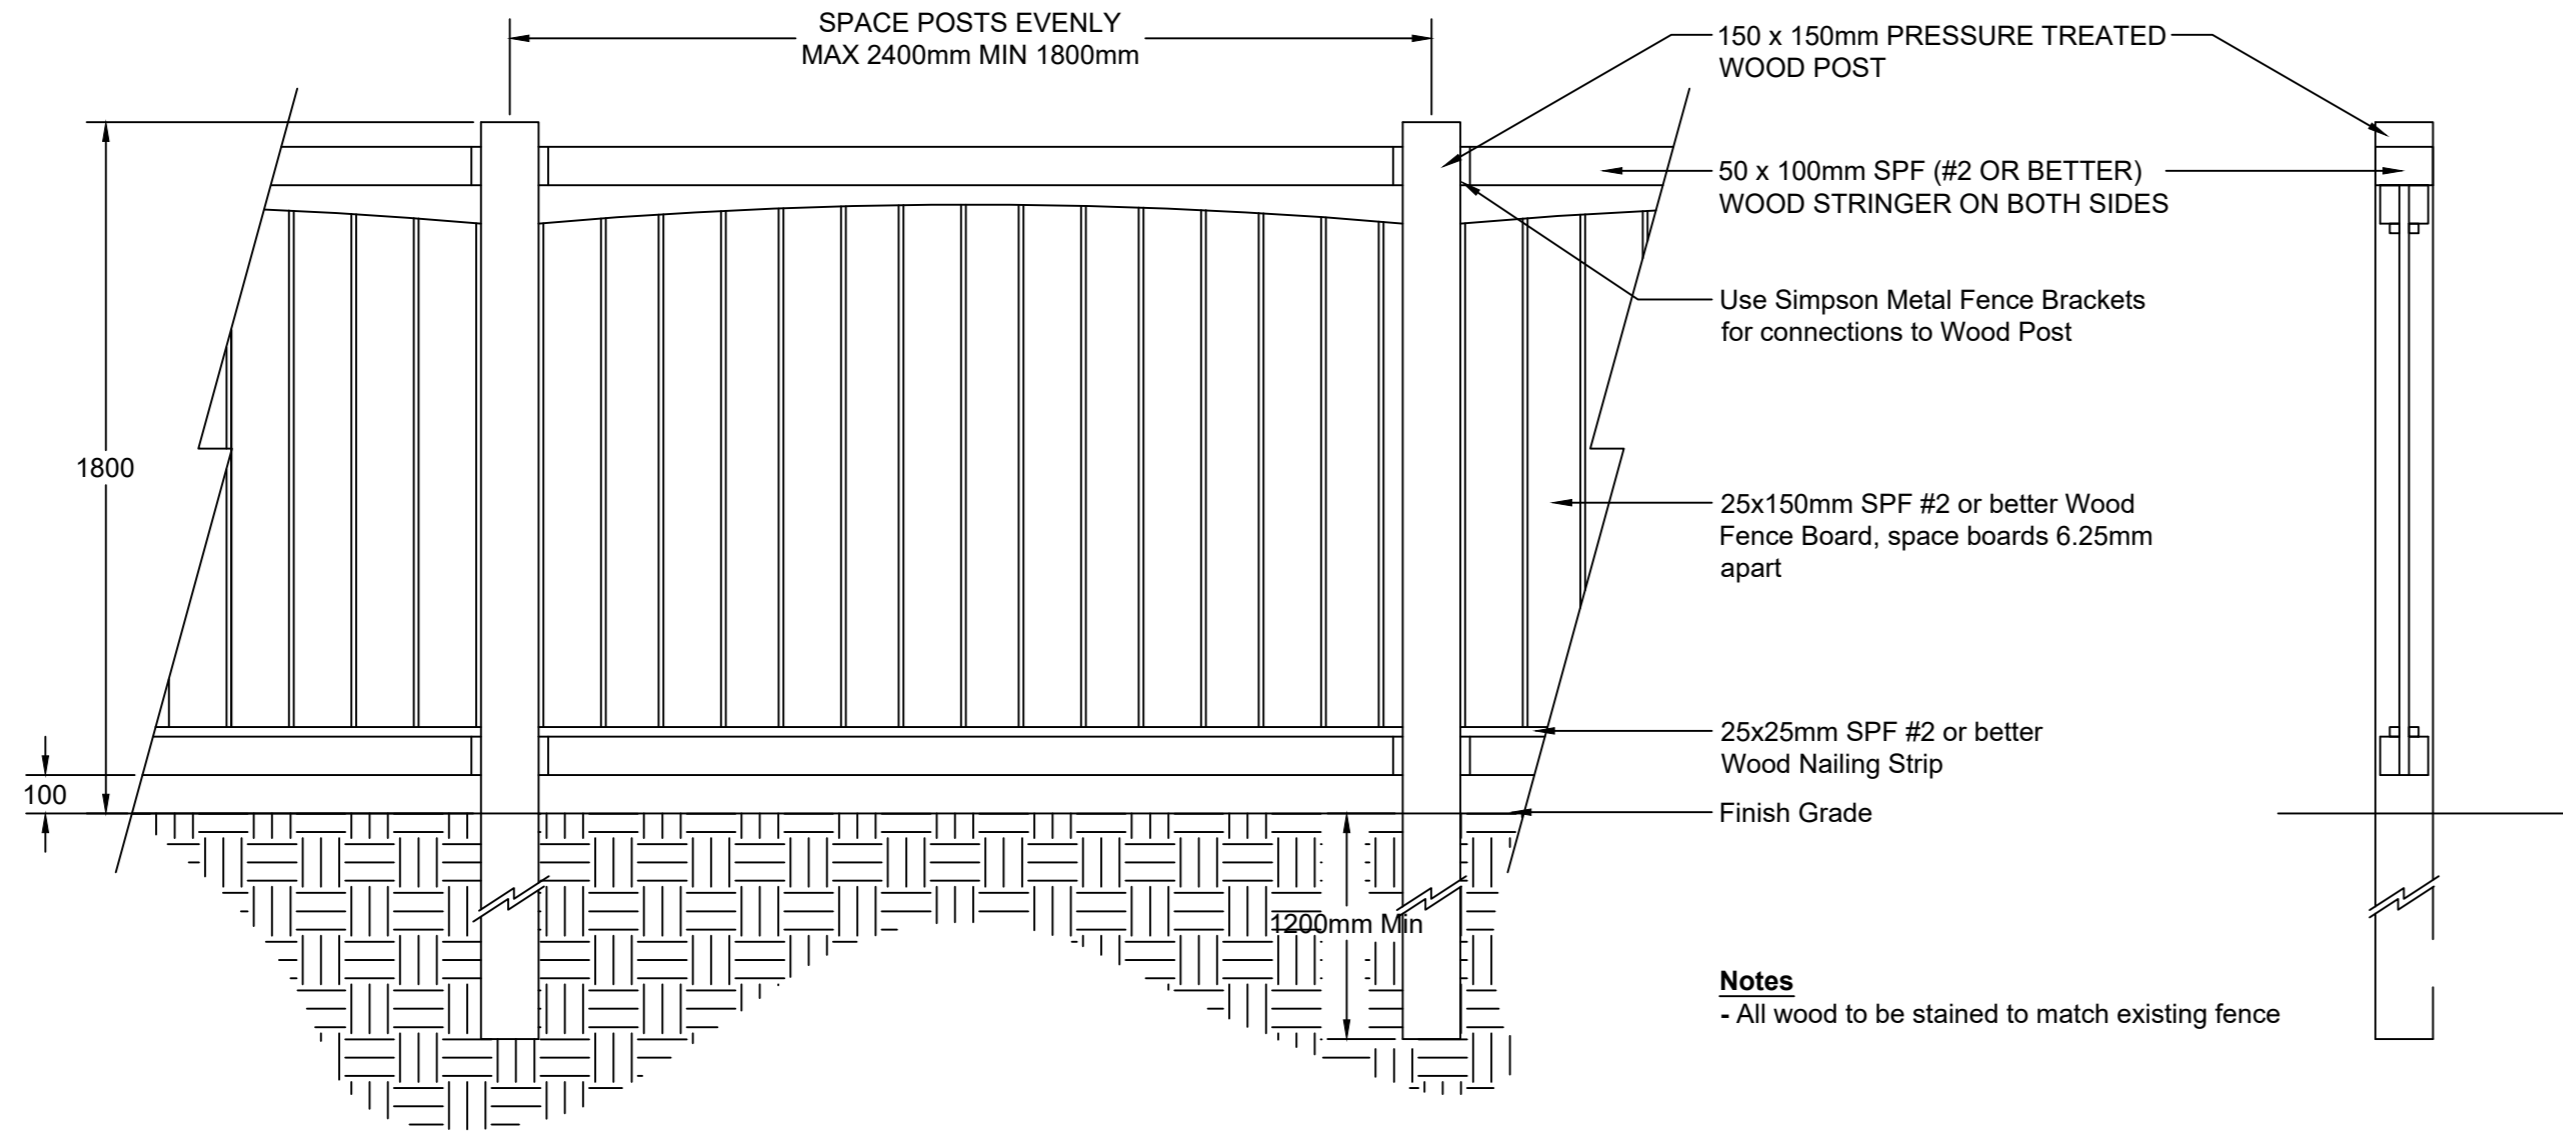


5 WOOD FENCE DETAIL
 SCALE: 1:20

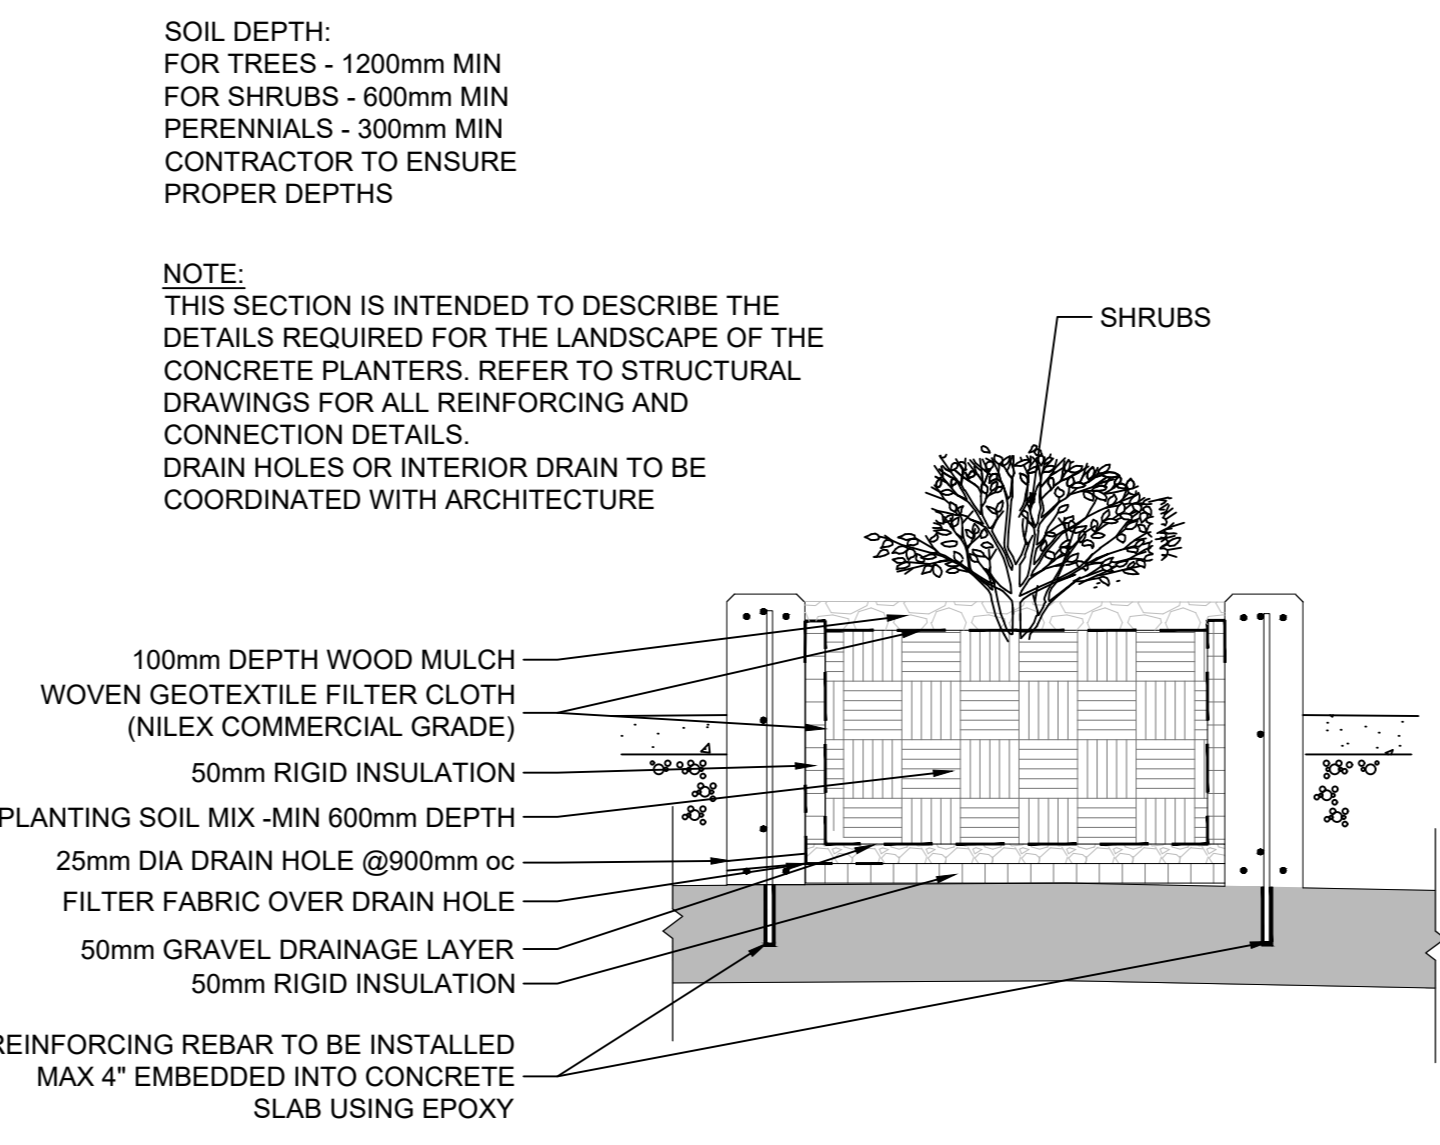


3 PLANTER DETAIL
 SCALE: 1:20

NOTE:
 THIS SECTION IS INTENDED TO DESCRIBE THE DETAILS REQUIRED FOR THE LANDSCAPE OF THE CONCRETE PLANTERS. REFER TO STRUCTURAL AND ARCHITECTURE DRAWINGS FOR ALL REINFORCING AND CONNECTION DETAILS AND DRAINAGE DETAILS SEE R10 ON ARCHITECTURAL

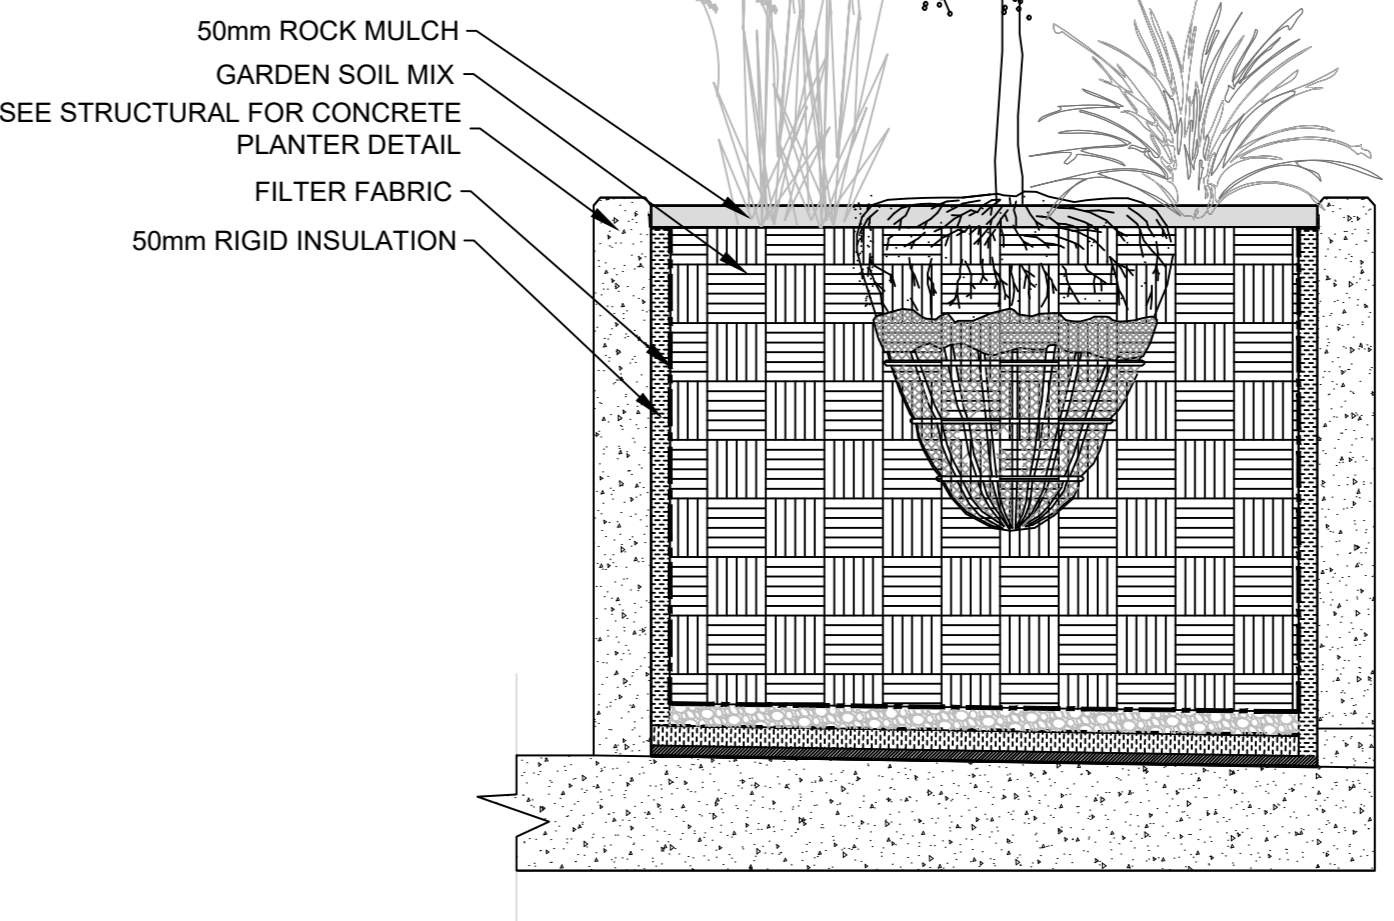

4 TREE PLANTER DETAIL
 SCALE: 1:20

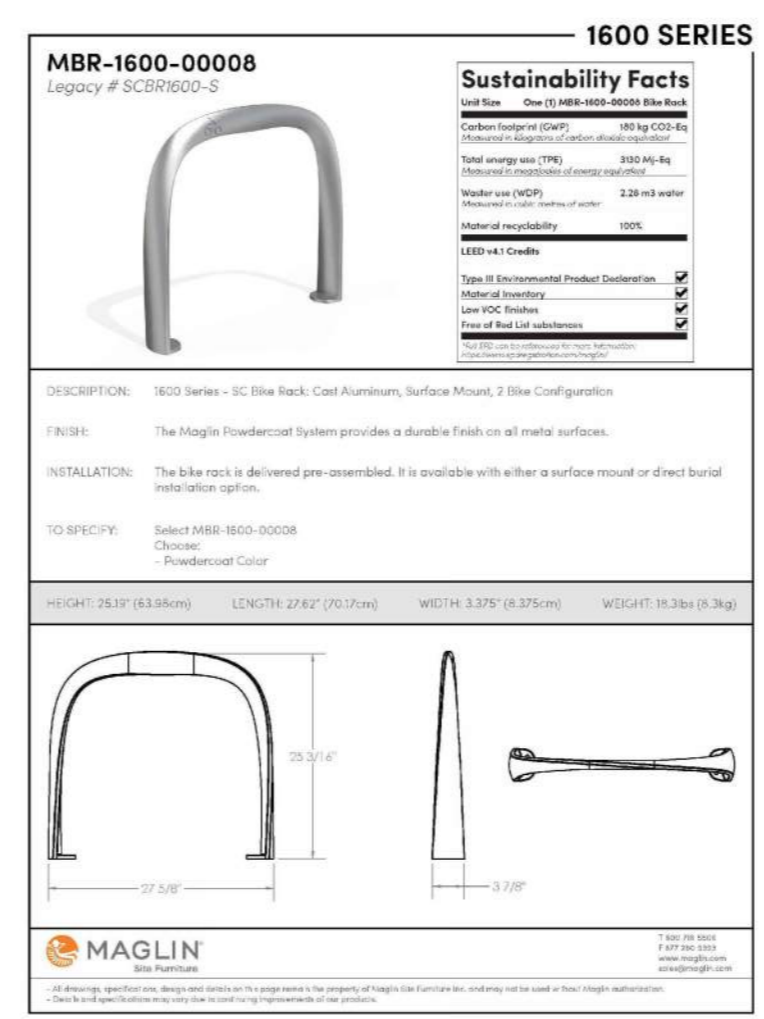

- NOTES:
- MAGLIN BIKE RACK.
 - BIKE RACK TO BE SURFACE MOUNTED.
 - CONTRACTOR TO SUPPLY AND INSTALL AS PER MANUFACTURER'S SPECIFICATIONS

6 BIKE RACK DETAIL
 SCALE: NTS



- NOTES:
- LANDSCAPE FORMS UNIVERSE SYSTEM BENCH.
 - BENCH TO BE SURFACE MOUNTED.
 - CONTRACTOR TO SUPPLY AND INSTALL AS PER MANUFACTURER'S SPECIFICATIONS

7 BENCH DETAIL
 SCALE: NTS

| 2026-03-05 | ISSUED FOR DP | 01 |
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| DATE | ISSUED FOR | REV |

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|-------------------------------------|---------|
| Client | |
| - | |
| Project | |
| ONWARD SHAGANAPPI | |
| 1406 26 Street SW, Calgary, Alberta | |
| Plan 231009, Block 5, Lot 55 | |
| Drawing Title | |
| LANDSCAPE DETAILS | |
| - | |
| Project Manager | CK |
| Project Leader | CK |
| Scale | 1:20 |
| Project No. | - |
| Drawing No. | DPL2.01 |

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